




ENLARGED SITE PLAN



- CONSTRUCTION NOTES:**
- ① 6" CONCRETE SLAB WITH #4 AT 18" OC ON 4" OF 5/8" MINUS CRUSHED GRAVEL ON COMPACTED SUBBASE.
  - ② 4" CONCRETE SIDEWALK WITH #4 AT 18" OC ON 4" OF 5/8" MINUS CRUSHED GRAVEL ON COMPACTED SUBBASE.
  - ③ CONTROL JOINT. FILL CONTROL JOINTS WITH SEALANT. CONTROL JOINTS SHALL BE TRUE STRAIGHT LINES, 1/4" WIDE BY 3/4" INCH DEEP AND CUT WITHIN 24 HOURS AFTER CONCRETE POUR.

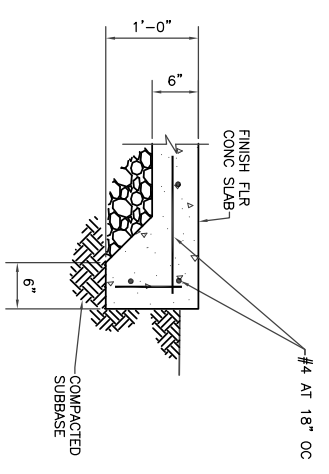

SECTION 1  
SCALE: 1" = 1'-0"

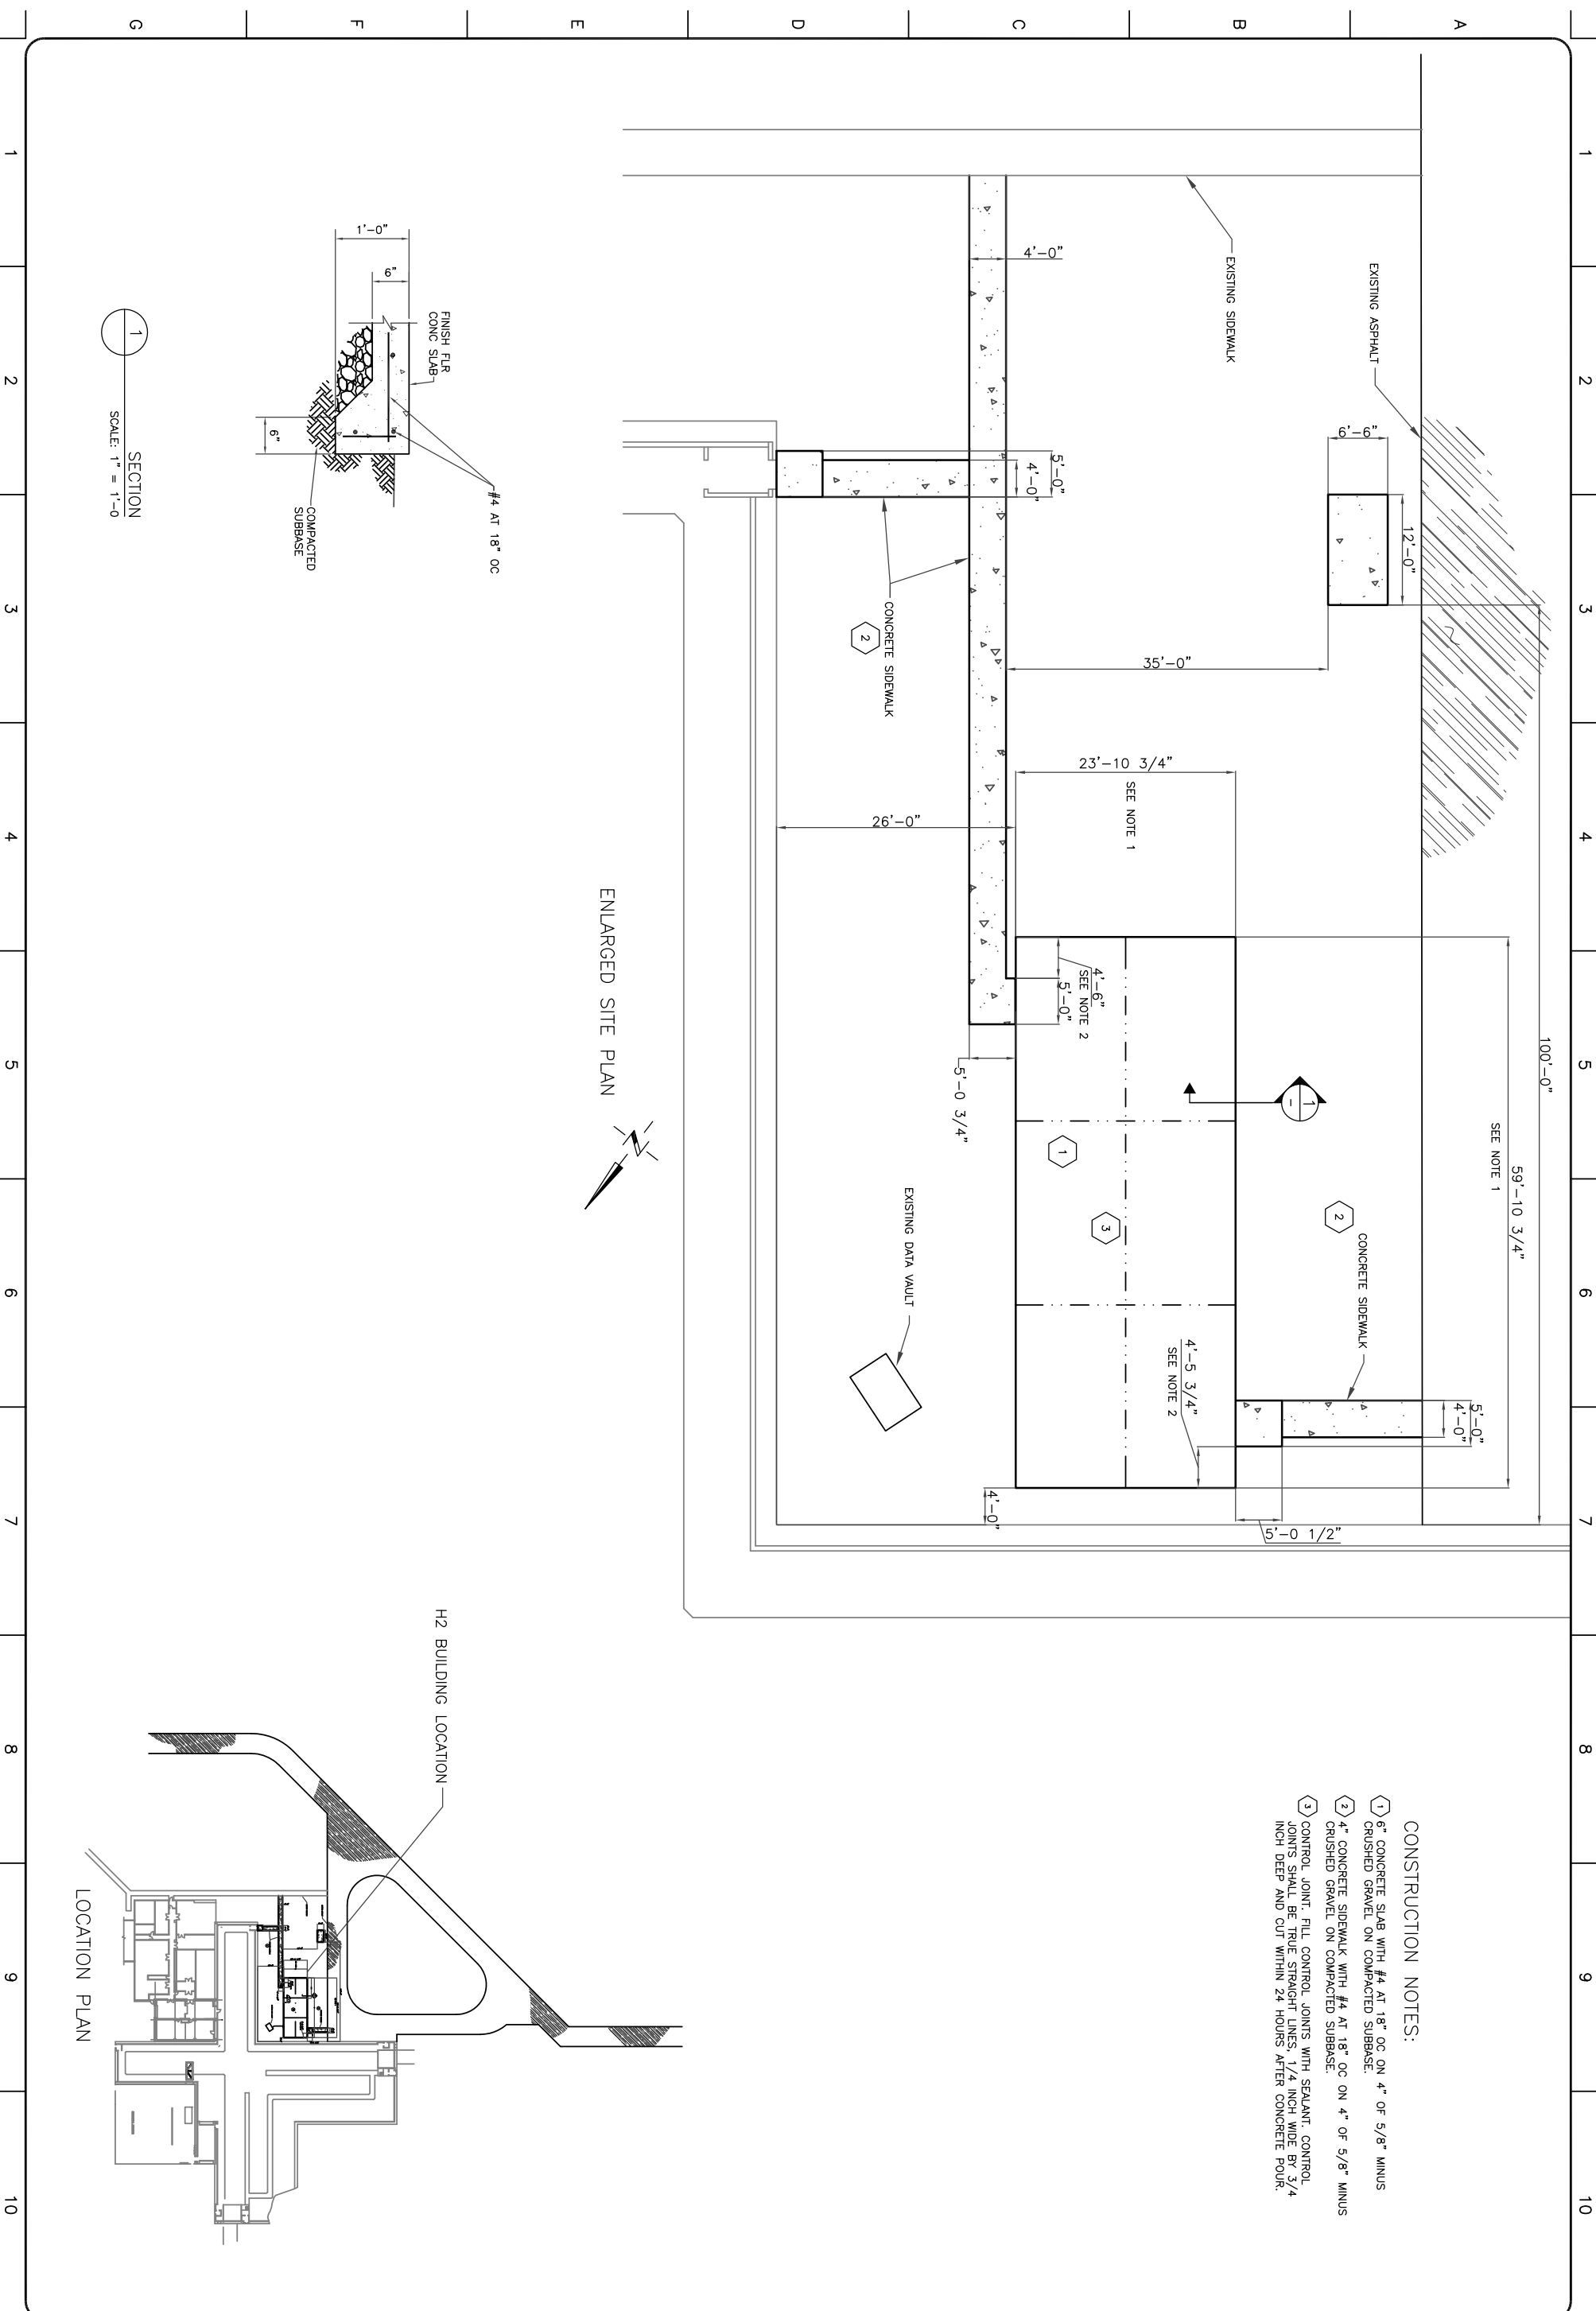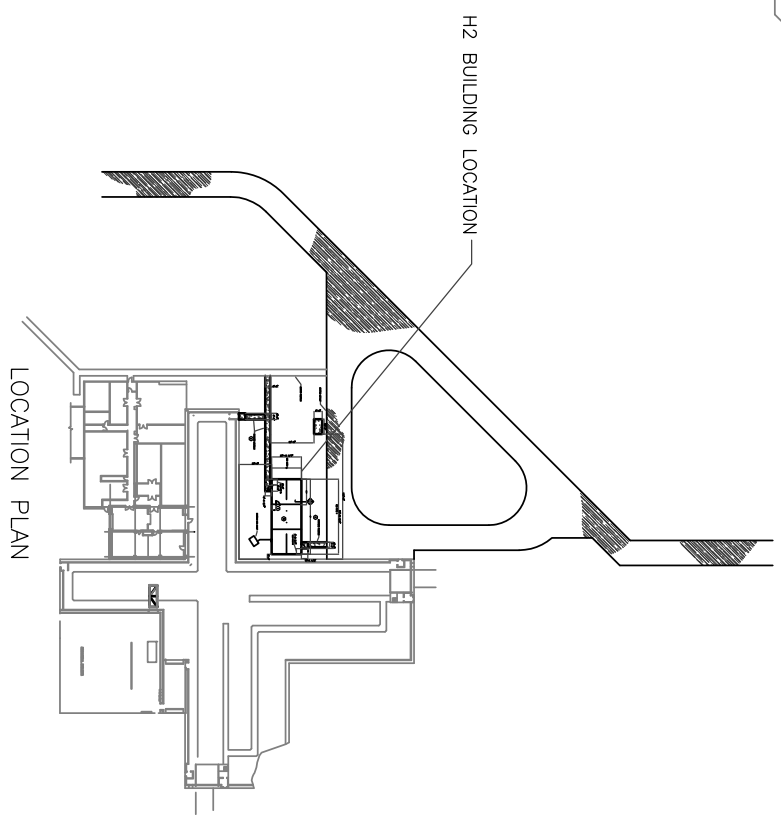

5/20/2010 DATE OF ISSUE

REV #	DATE	BY	DESCRIPTION	APPROVED

DRAWN BY: GLH	
CHECKED BY:	DESIGN GM
DESIGN A/E	
HEI APPROVAL	

H2 BUILDING CONCRETE PLAN	
PROJECT NUMBER: 1035.010	CAD FILE: 10351A01.DWG

LIGO HANFORD OBSERVATORY  
DRAWING: LIGO-D1002509-v1

**HIBBS ENGINEERING, INC.**  
KENNEWICK, WASHINGTON

DRAWING NUMBER	REV
S1	0

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