
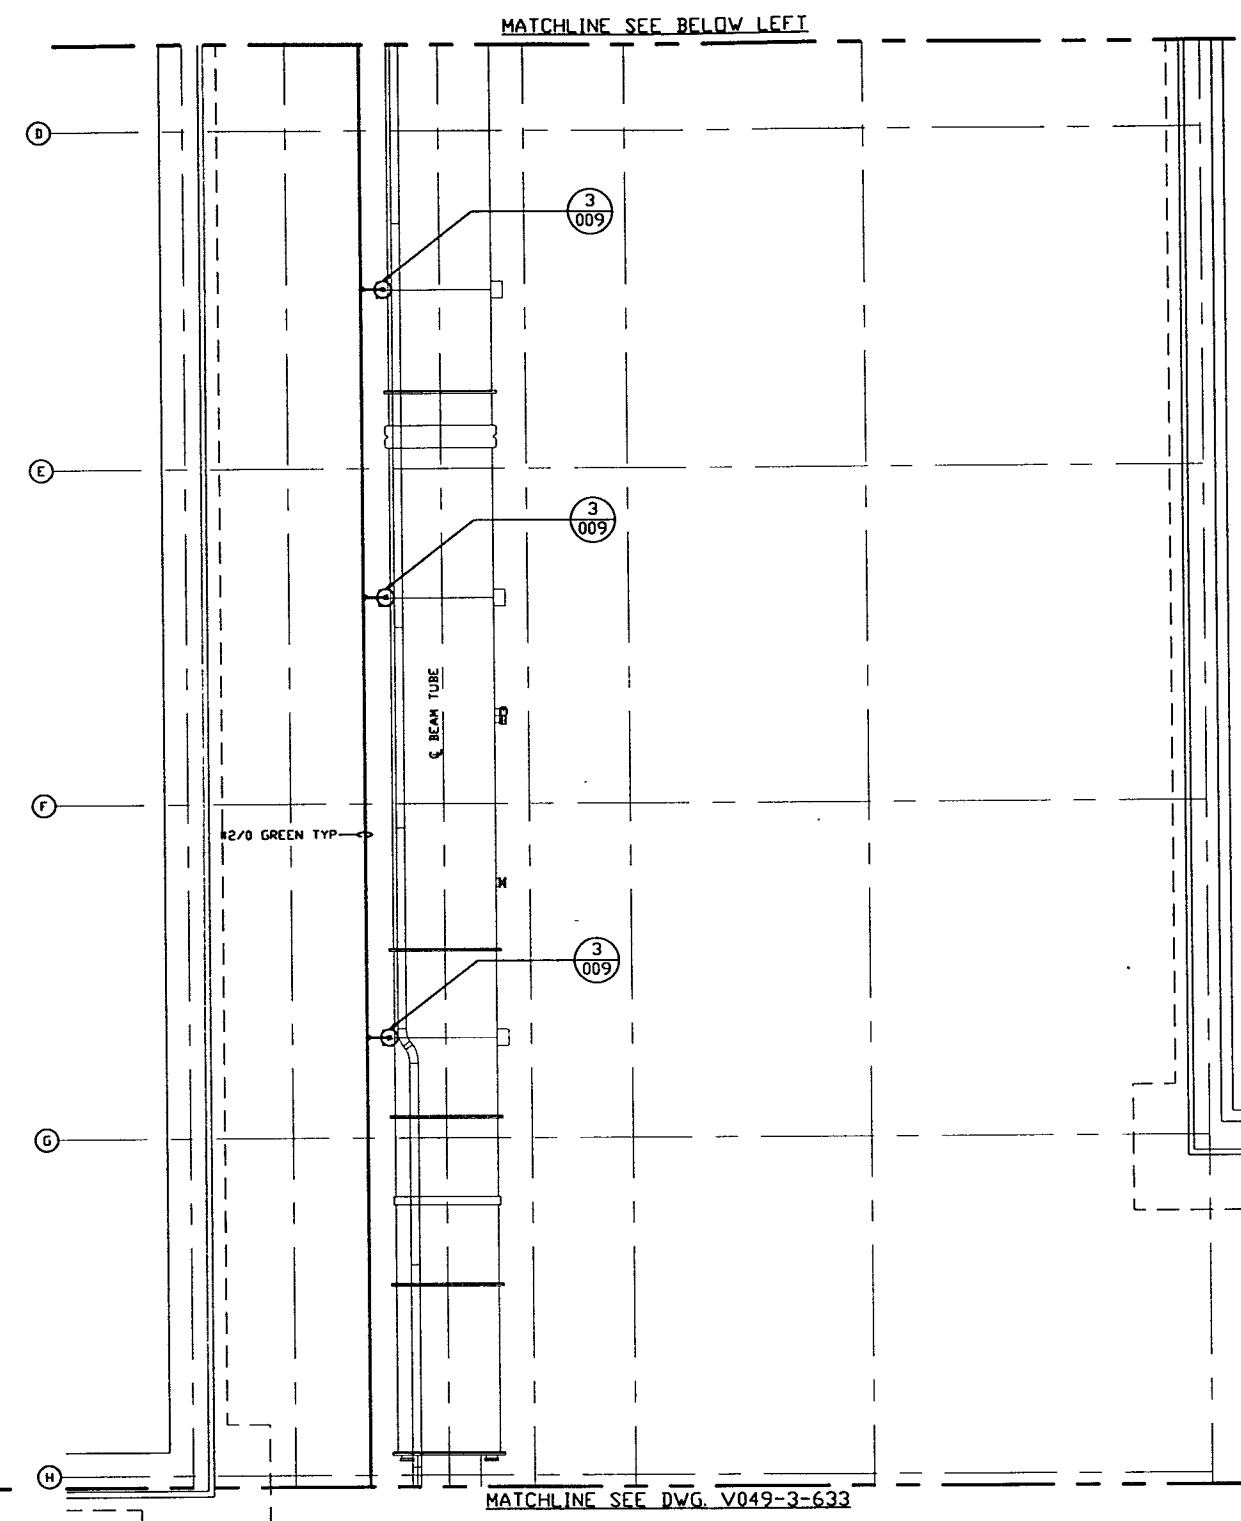



NOTES:

- 1.) FOR GENERAL NOTES & LEGEND SEE PSI DWG. #V049-3-001 SHT. 1.
- 2.) FOR LIST OF CIVIL CONTRACTORS REFERENCE DWGS. WITH CURRENT REVISIONS SEE PSI DWG. #V049-3-001 SHT. 2.
- 3.) GROUND GRID IS BY OTHERS.
- 4.) TIE GROUNDING CONDUCTOR TO EXISTING GROUND GRID SEE PARSONS DWG. #LA-E-103.

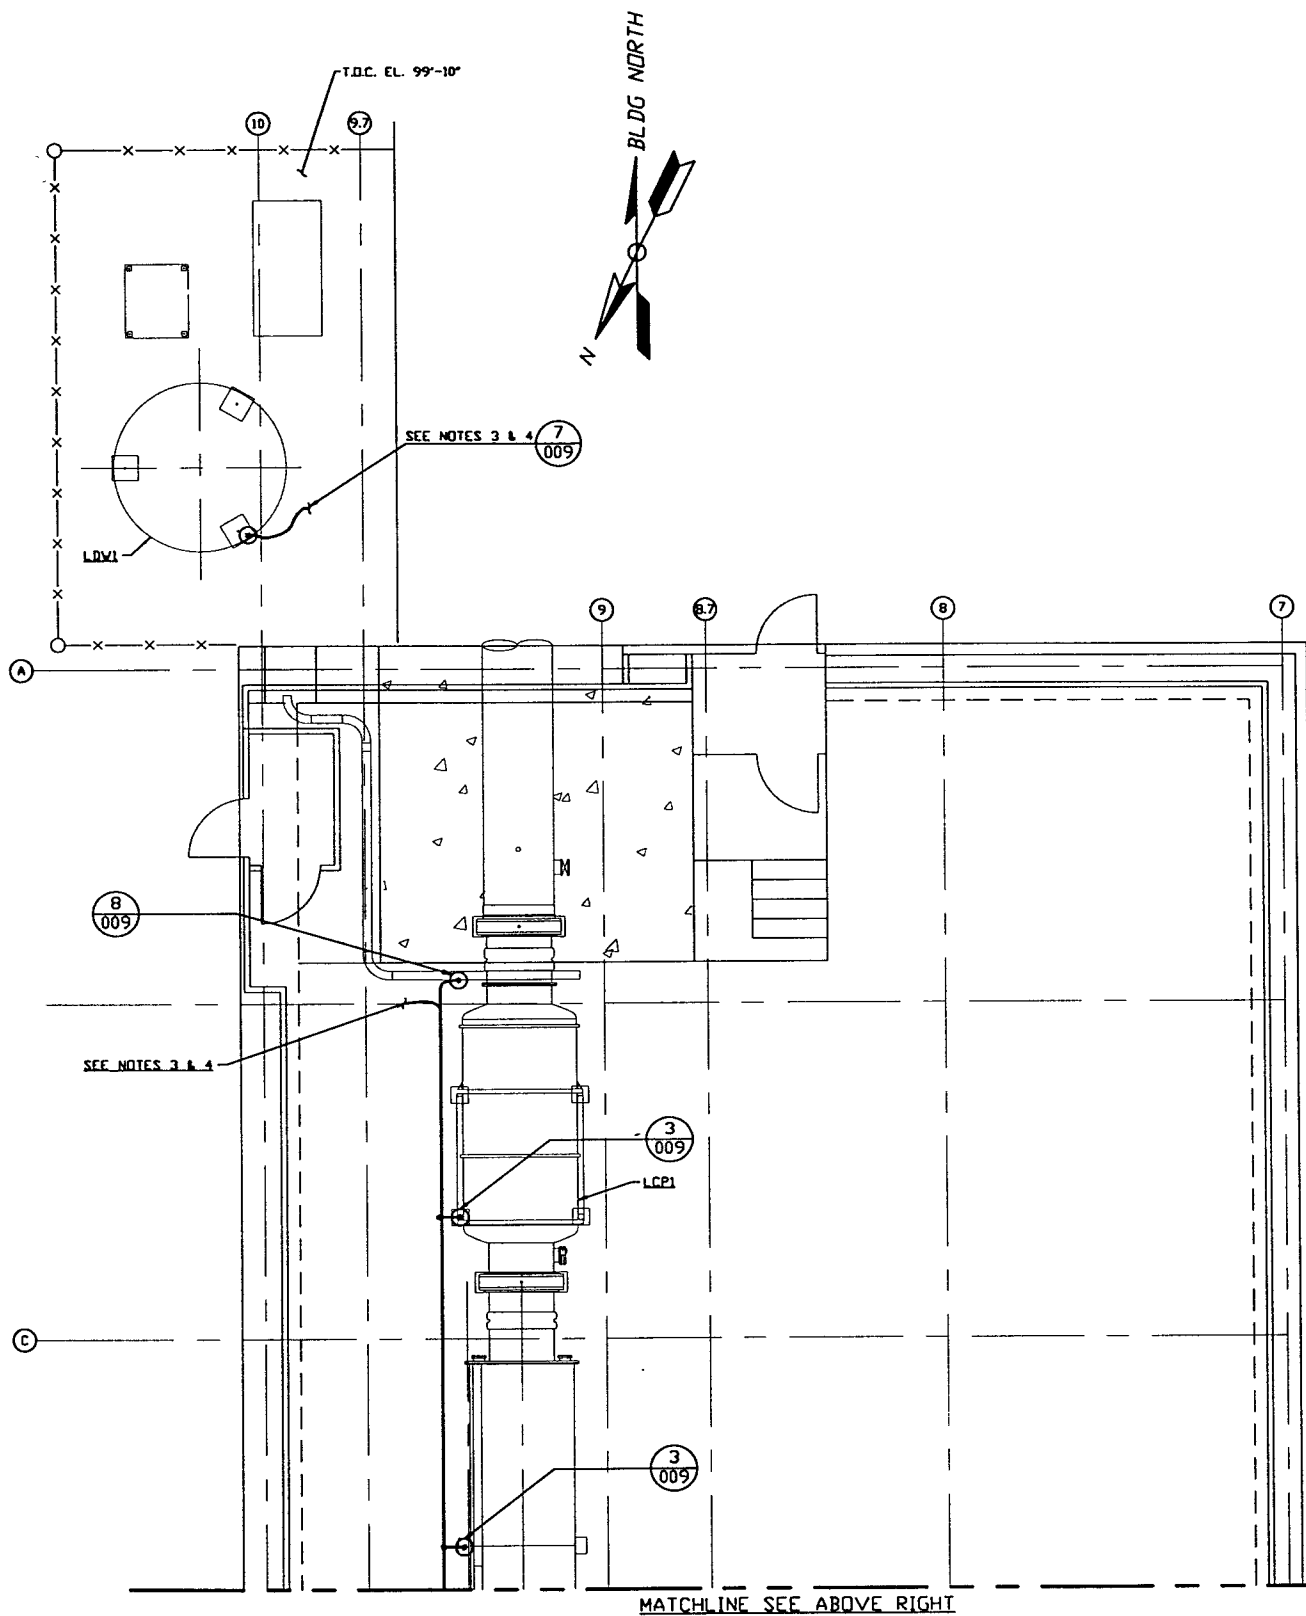

LEFT BEAM MANIFOLD PLAN @ EL. 100'-0"

PRELIMINARY NOT FOR CONSTRUCTION

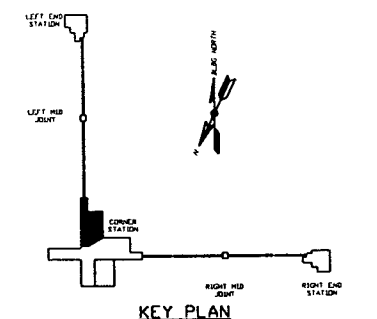

LIGO-D970134-00-V

<p>PROPRIETARY AND CONFIDENTIAL</p> <p>THIS DOCUMENT CONTAINS PROPRIETARY INFORMATION BELONGING TO PROCESS SYSTEMS INTERNATIONAL, INC. OR ITS AFFILIATED COMPANIES AND SHALL BE USED ONLY FOR THE PURPOSE FOR WHICH IT WAS SUPPLIED. IT SHALL NOT BE COPIED, REPRODUCED OR OTHERWISE USED, NOR SHALL SUCH INFORMATION BE FURNISHED IN WHOLE OR IN PART TO OTHERS EXCEPT IN ACCORDANCE WITH THE TERMS OF ANY AGREEMENT UNDER WHICH IT WAS SUPPLIED OR WITH THE PRIOR WRITTEN CONSENT OF PROCESS SYSTEMS INTERNATIONAL, INC. AND SHALL BE RETURNED UPON REQUEST.</p>		<p>V049-3-633 GROUNDING PLAN LOUISIANA VERTEX SECTION</p> <p>V049-3-607 CABLE TRAY PLAN LOUISIANA LEFT BEAM MANIFOLD</p> <p>V049-3-009 GROUNDING DETAILS</p> <p>V049-3-003 LOUISIANA OVERALL SITE PLAN</p> <p>V049-3-001 GENERAL NOTES & LEGEND</p>	<p>UNLESS OTHERWISE SPECIFIED DIMENSIONS ARE IN INCHES</p> <p>TOLERANCES:</p> <p>FRACTIONAL ANGULAR/AROUND 1/8"-3/16" BEND 1/2" TWO PLACE DECIMAL 1/32" FINISHED SURFACE DIMS BREAK CORNERS 1/4" OUT REMOVE ALL BURRS</p> <p>DO NOT SCALE THIS DRAWING</p> <p>USED ON: _____</p> <p>NEXT ASSY: _____</p>	<p>0 ISSUE FOR LA DESIGN REVIEW</p> <p>REV _____ DESCRIPTION _____</p> <p>CHKD _____ DRWN _____ DATE 02-24-97 04:30</p> <p>ISSUE DESCRIPTION _____</p>	<p>PROCESS SYSTEMS INTERNATIONAL, INC. 20 WALKUP DR. WESTBOROUGH, MASSACHUSETTS 01581 USA</p> <p>GROUNDING PLAN LIGO VACUUM EQUIPMENT LOUISIANA SITE LEFT BEAM MANIFOLD</p> <p>CAD FILE V0493634 SIZE D DWG NO. V049-3-634 SHEET 1 OF 1</p>
<p>REFERENCE DRAWINGS</p>					<p>SCALE 3/16" = 1' - 0"</p>