



- NOTES:**
- FOR GENERAL NOTES & LEGEND SEE PSI DVG. #V049-3-001 SHT. 1.
  - FOR LIST OF CIVIL CONTRACTORS REFERENCE DWGS. WITH CURRENT REVISIONS SEE PSI DVG. #V049-3-001 SHT. 2.
  - GROUND GRID IS BY OTHERS.
  - TIE GROUNDING CONDUCTOR TO EXISTING GROUND GRID. SEE PARSONS DVG. #VA-E-212.
  - GROUND VENT PIPE SUPPORT TO EXISTING GROUND GRID. SEE PARSONS DVG. #VA-E-212.

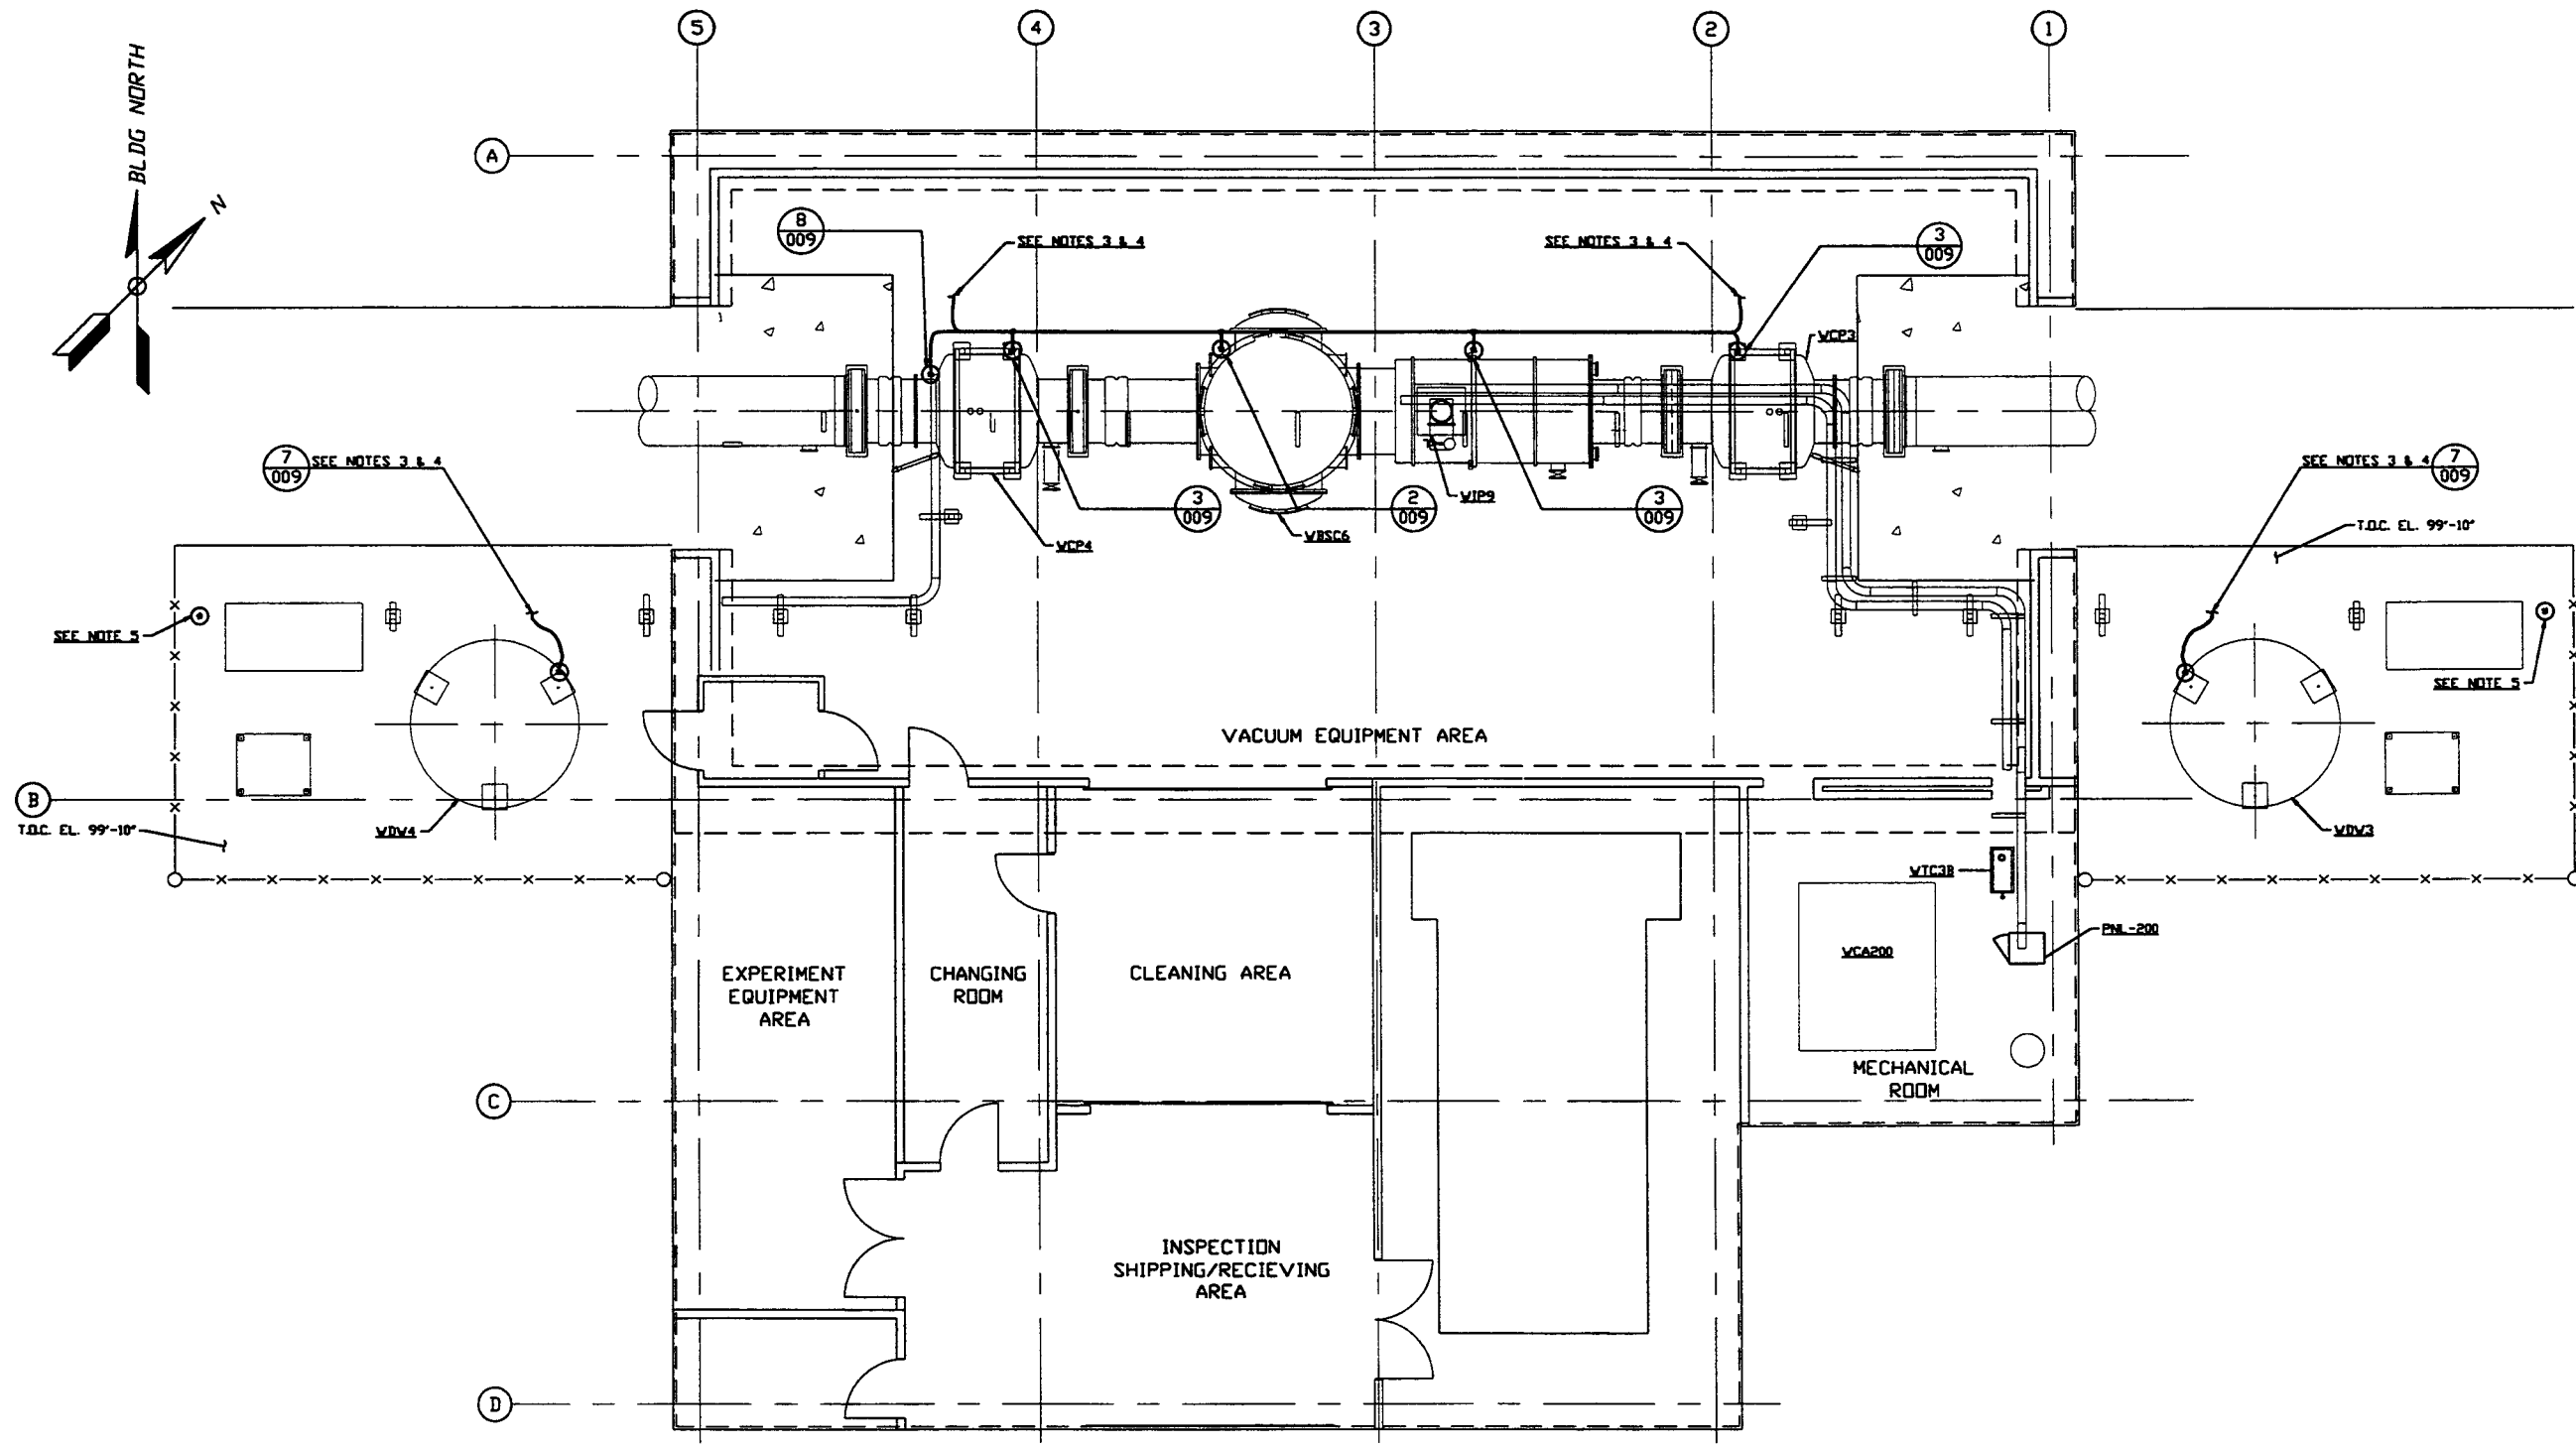

LEFT MID STATION PLAN @ EL. 100'-0"

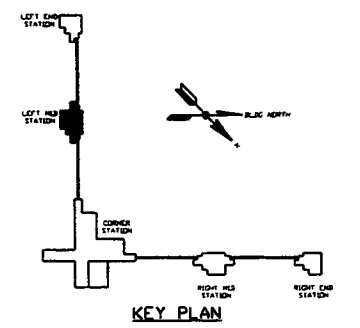

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THIS DOCUMENT CONTAINS PROPRIETARY INFORMATION BELONGING TO PROCESS SYSTEMS INTERNATIONAL, INC. OR ITS AFFILIATED COMPANIES AND SHALL BE USED ONLY FOR THE PURPOSE FOR WHICH IT WAS SUPPLIED. IT SHALL NOT BE COPIED, REPRODUCED OR OTHERWISE USED, FOR SHALL, SUCH INFORMATION BE FURNISHED BY WHOLE OR IN PART TO OTHERS EXCEPT IN ACCORDANCE WITH THE TERMS OF ANY AGREEMENT UNDER WHICH IT WAS SUPPLIED OR WITH THE PRIOR WRITTEN CONSENT OF PROCESS SYSTEMS INTERNATIONAL, INC. AND SHALL BE RETURNED UPON REQUEST.				DIMENSIONS ARE IN INCHES TOLERANCES: FRACTIONAL ± ANGULAR ± TWO PLACE DECIMAL ± THREE PLACE DECIMAL ± FINISHED SURFACE THIS BREAK CORNERS IN OUT REMOVE ALL BURRS				20 WALKUP DR. WESTBOROUGH, MASSACHUSETTS 01581 USA			
V049-3-202	CABLE TRAY PLAN WASHINGTON LEFT MID STATION			1	ISSUE FOR CONSTRUCTION	REB	DMCV	05.12.97	0480	GROUNDING PLAN LIGO VACUUM EQUIPMENT WASHINGTON SITE LEFT MID STATION	
V049-3-009	GROUNDING DETAILS			0	ISSUE FOR FOR UPDATE & BID			11.25.96	0355	CAN FILE V0493209	
V049-3-002	OVERALL SITE PLAN WASHINGTON									REV. D V049-3-209 1	
V049-3-001	GENERAL NOTES & LEGEND									SCALE 3/16" = 1' - 0"	
DWG. NO.	DESCRIPTION	DWG. NO.	DESCRIPTION	REV	DESCRIPTION	CHKD	DRWN	DATE	DECR	SHEET 1 OF 1	
	REFERENCE DRAWINGS				ISSUE DESCRIPTION					LIGO-D961754-01-V	