



not be reproduced, copied, loaned, exhibited, or used in any other way, except by written consent from PARSONS to the borrower.

This document and the design it covers are the property of PARSONS. They are loaned only with the borrower's expressed written agreement that they will



NOTES:
 1. SEE SHEET RG-C-002 FOR GENERAL NOTES, LEGEND AND ABBREVIATIONS.

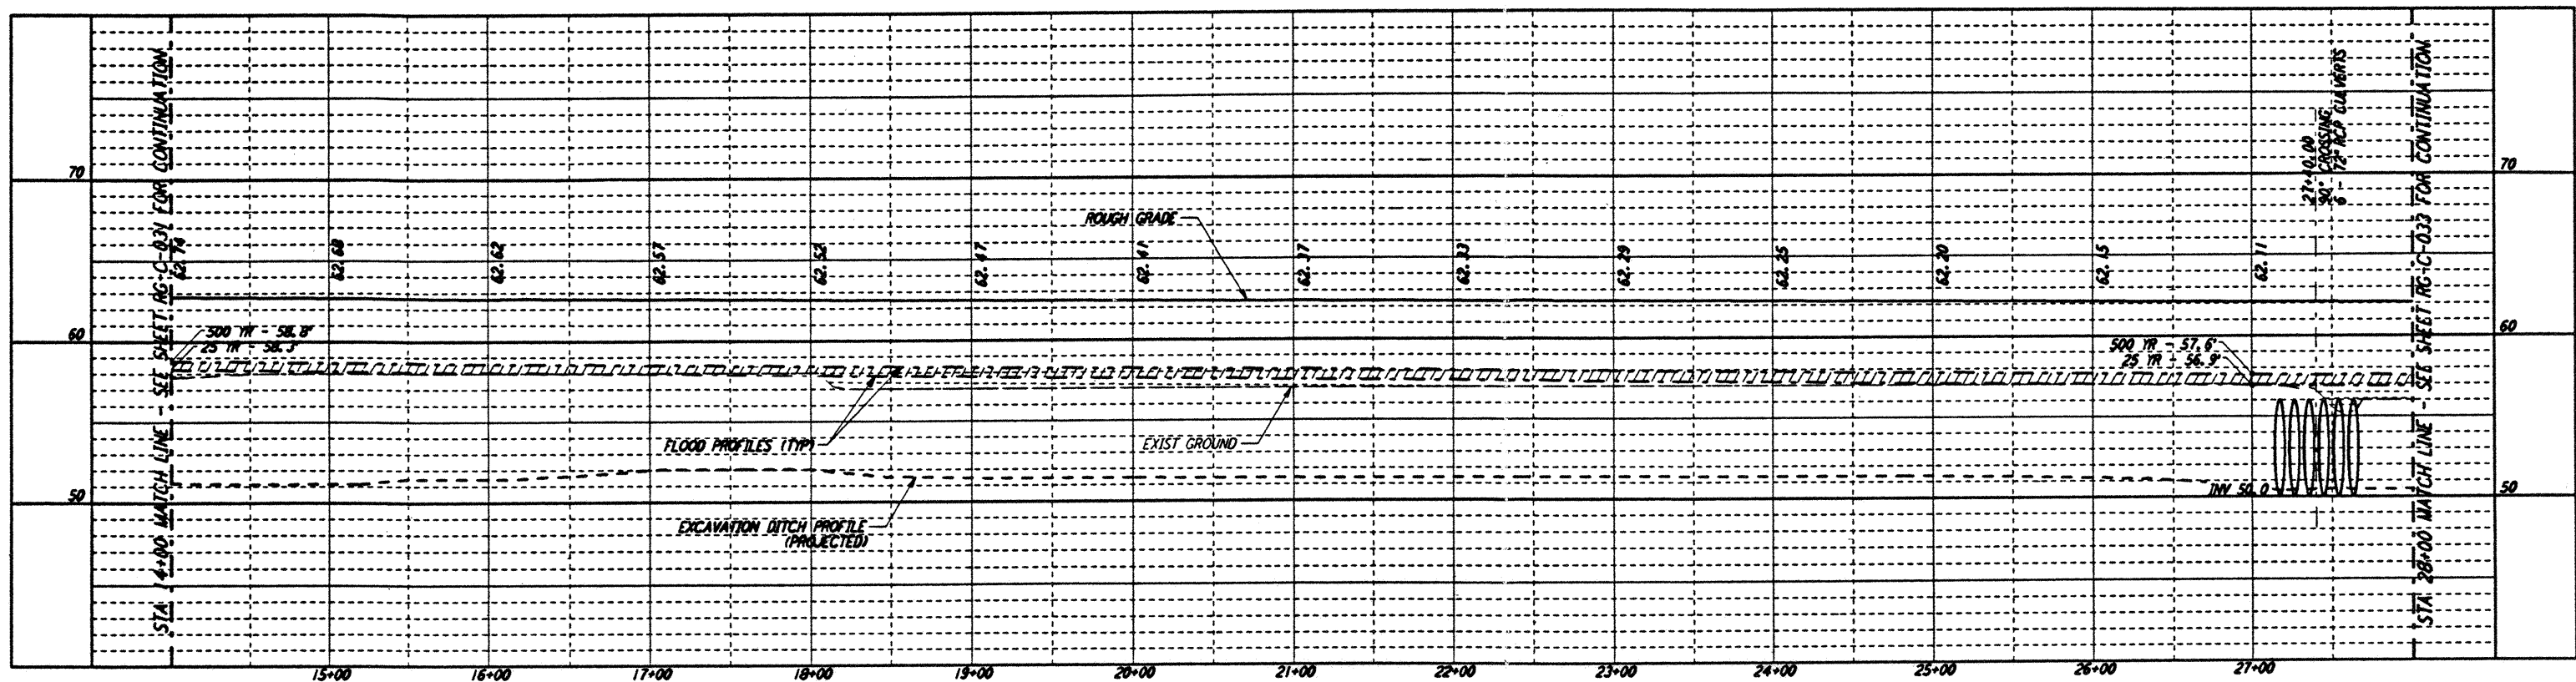

PROFILE
 SCALES: HORIZ: 1" = 50'
 VERT: 1" = 5'

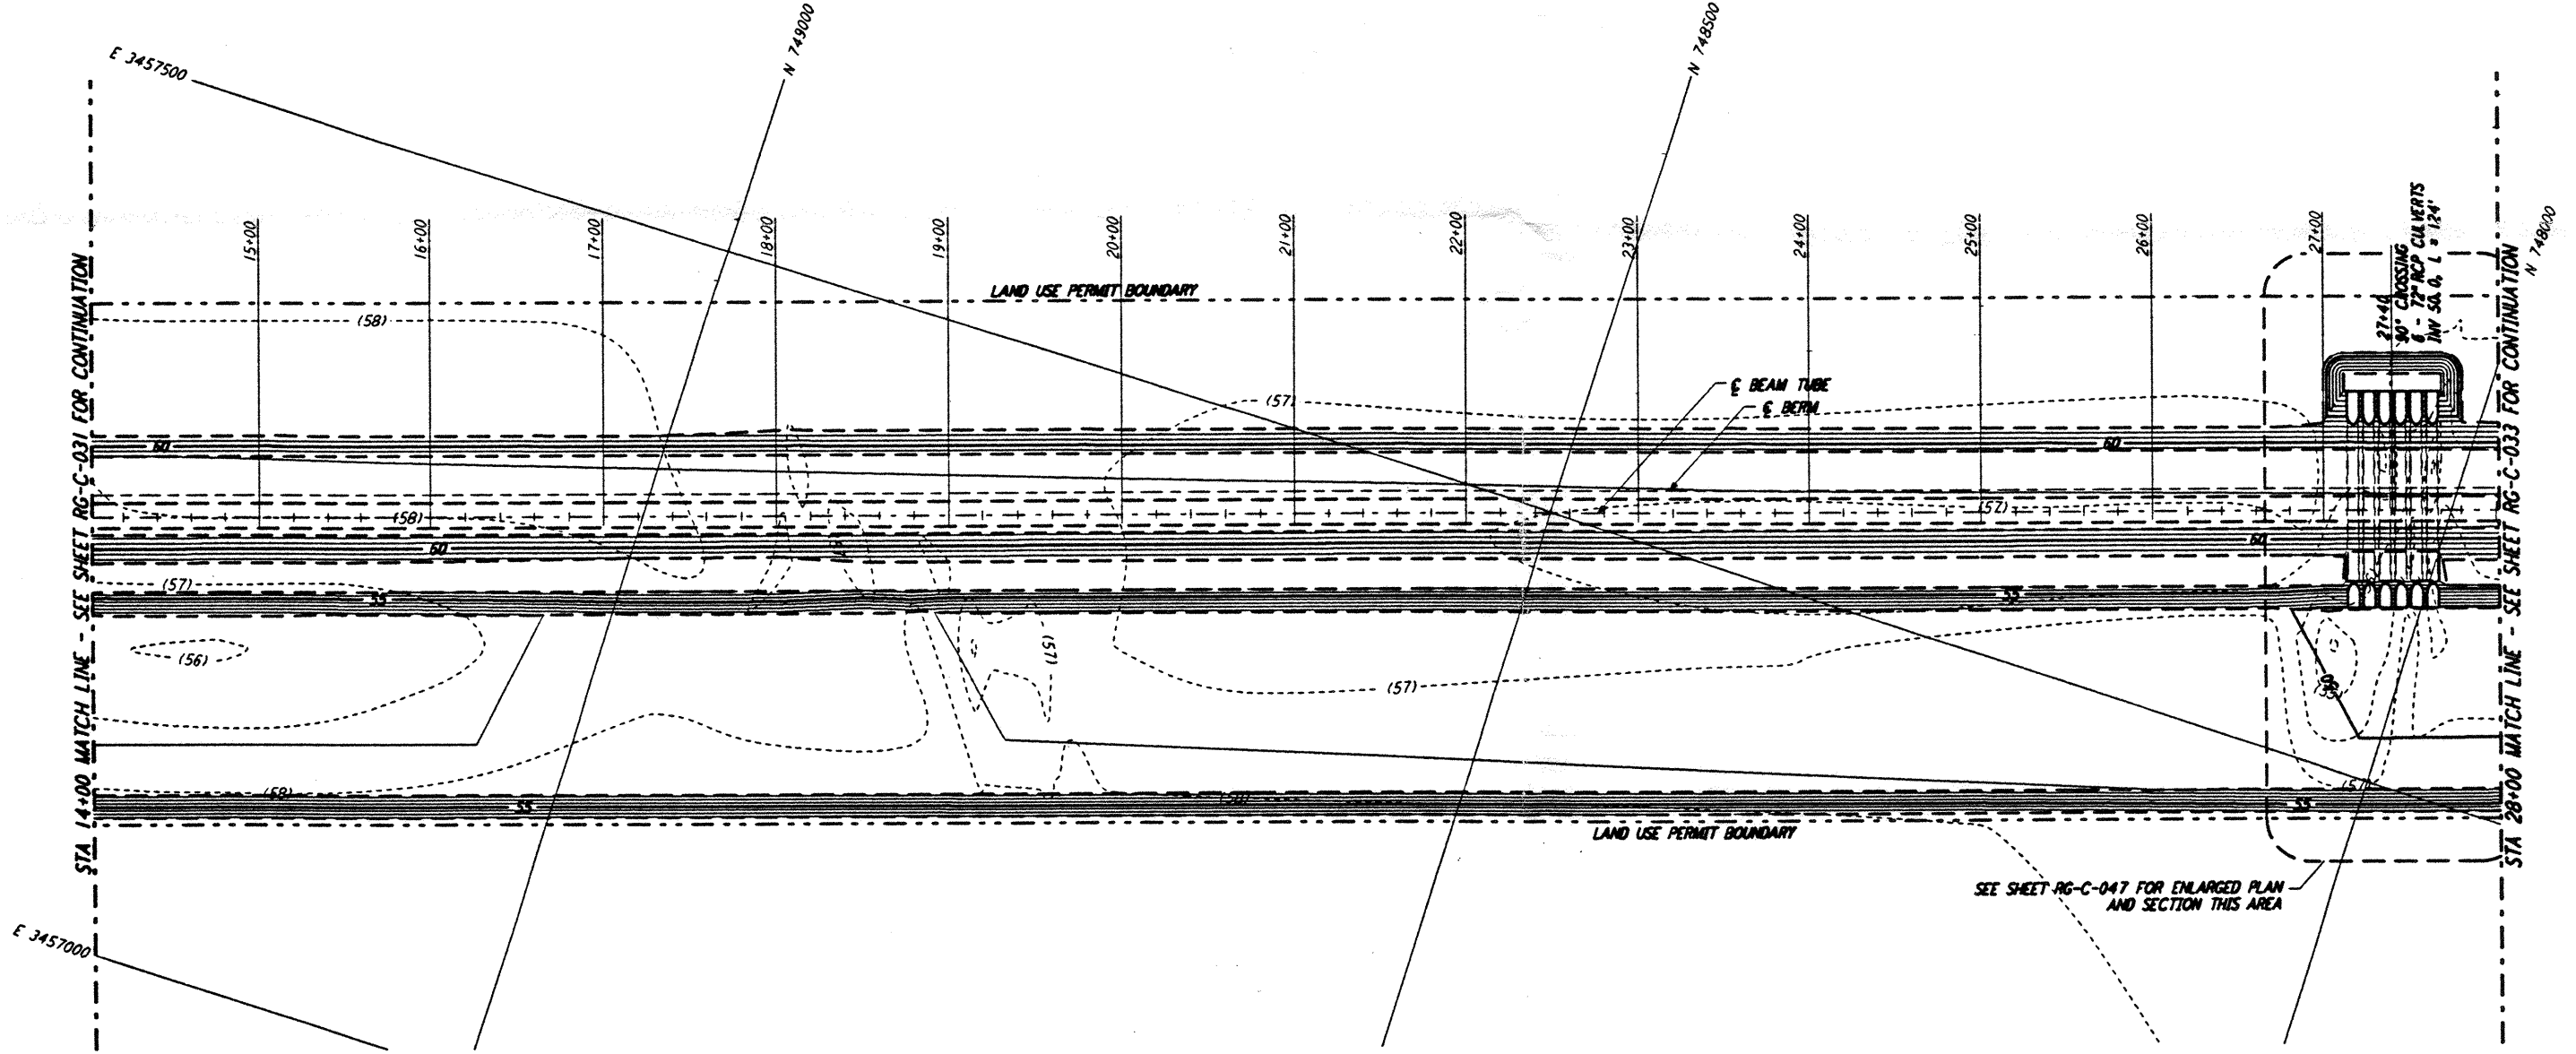

PLAN
 SCALE: 1" = 50'

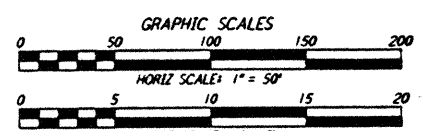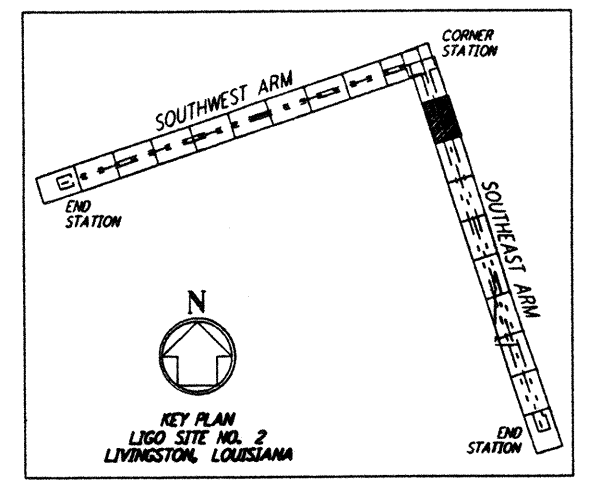

LIGO-0961737-00-0

NO.	DATE	APRD BY	DESCRIPTION OF REVISION	NO.	DATE	APRD BY	ISSUED FOR
1	8/28/95	TJM	ISSUED FOR BID				

DATE	8/11/95
DRAWN	WRB 8/95
CHECKED	MCP 8/8/95
ENGINEER	TJM 8/18/95
PROJ MGR	JLL 8/28/95

PARSONS
 100 WEST WALNUT STREET
 PASADENA, CALIFORNIA

LIGO
 CALIFORNIA INSTITUTE OF TECHNOLOGY
 MASSACHUSETTS INSTITUTE OF TECHNOLOGY

**LASER INTERFEROMETER
 GRAVITATIONAL-WAVE OBSERVATORY
 ROUGH GRADING - LIVINGSTON, LA**

TITLE	ROUGH GRADING SOUTHWEST ARM PLAN AND PROFILE STA 14+00 TO STA 28+00	SCALE	AS NOTED	CHECKED NUMBER	PP150969	PROJECT NUMBER	8094
SHEET NUMBER	RG-C-032						

Fri Aug 25 13:49:48 1995 s3-v18b2 K:\PLOTS\QUEUES\V18B2\CE032A.PRF