

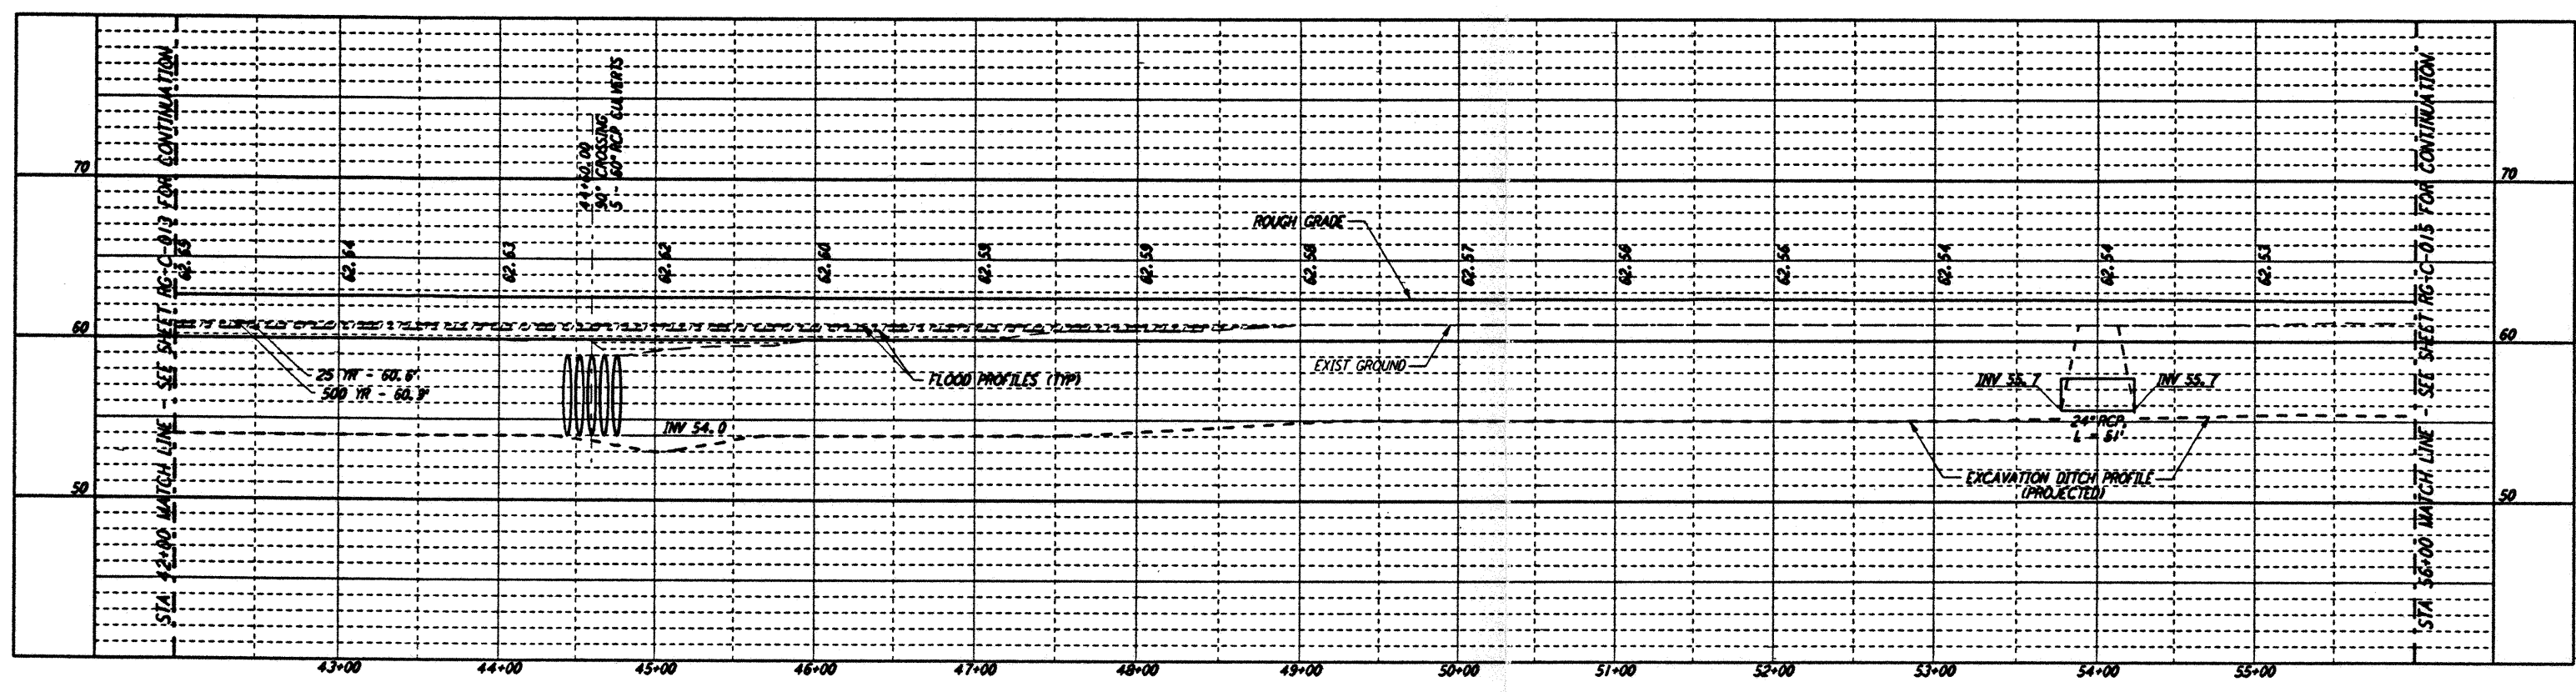




**NOTES:**  
 1. SEE SHEET RG-C-002 FOR GENERAL NOTES, LEGEND AND ABBREVIATIONS.

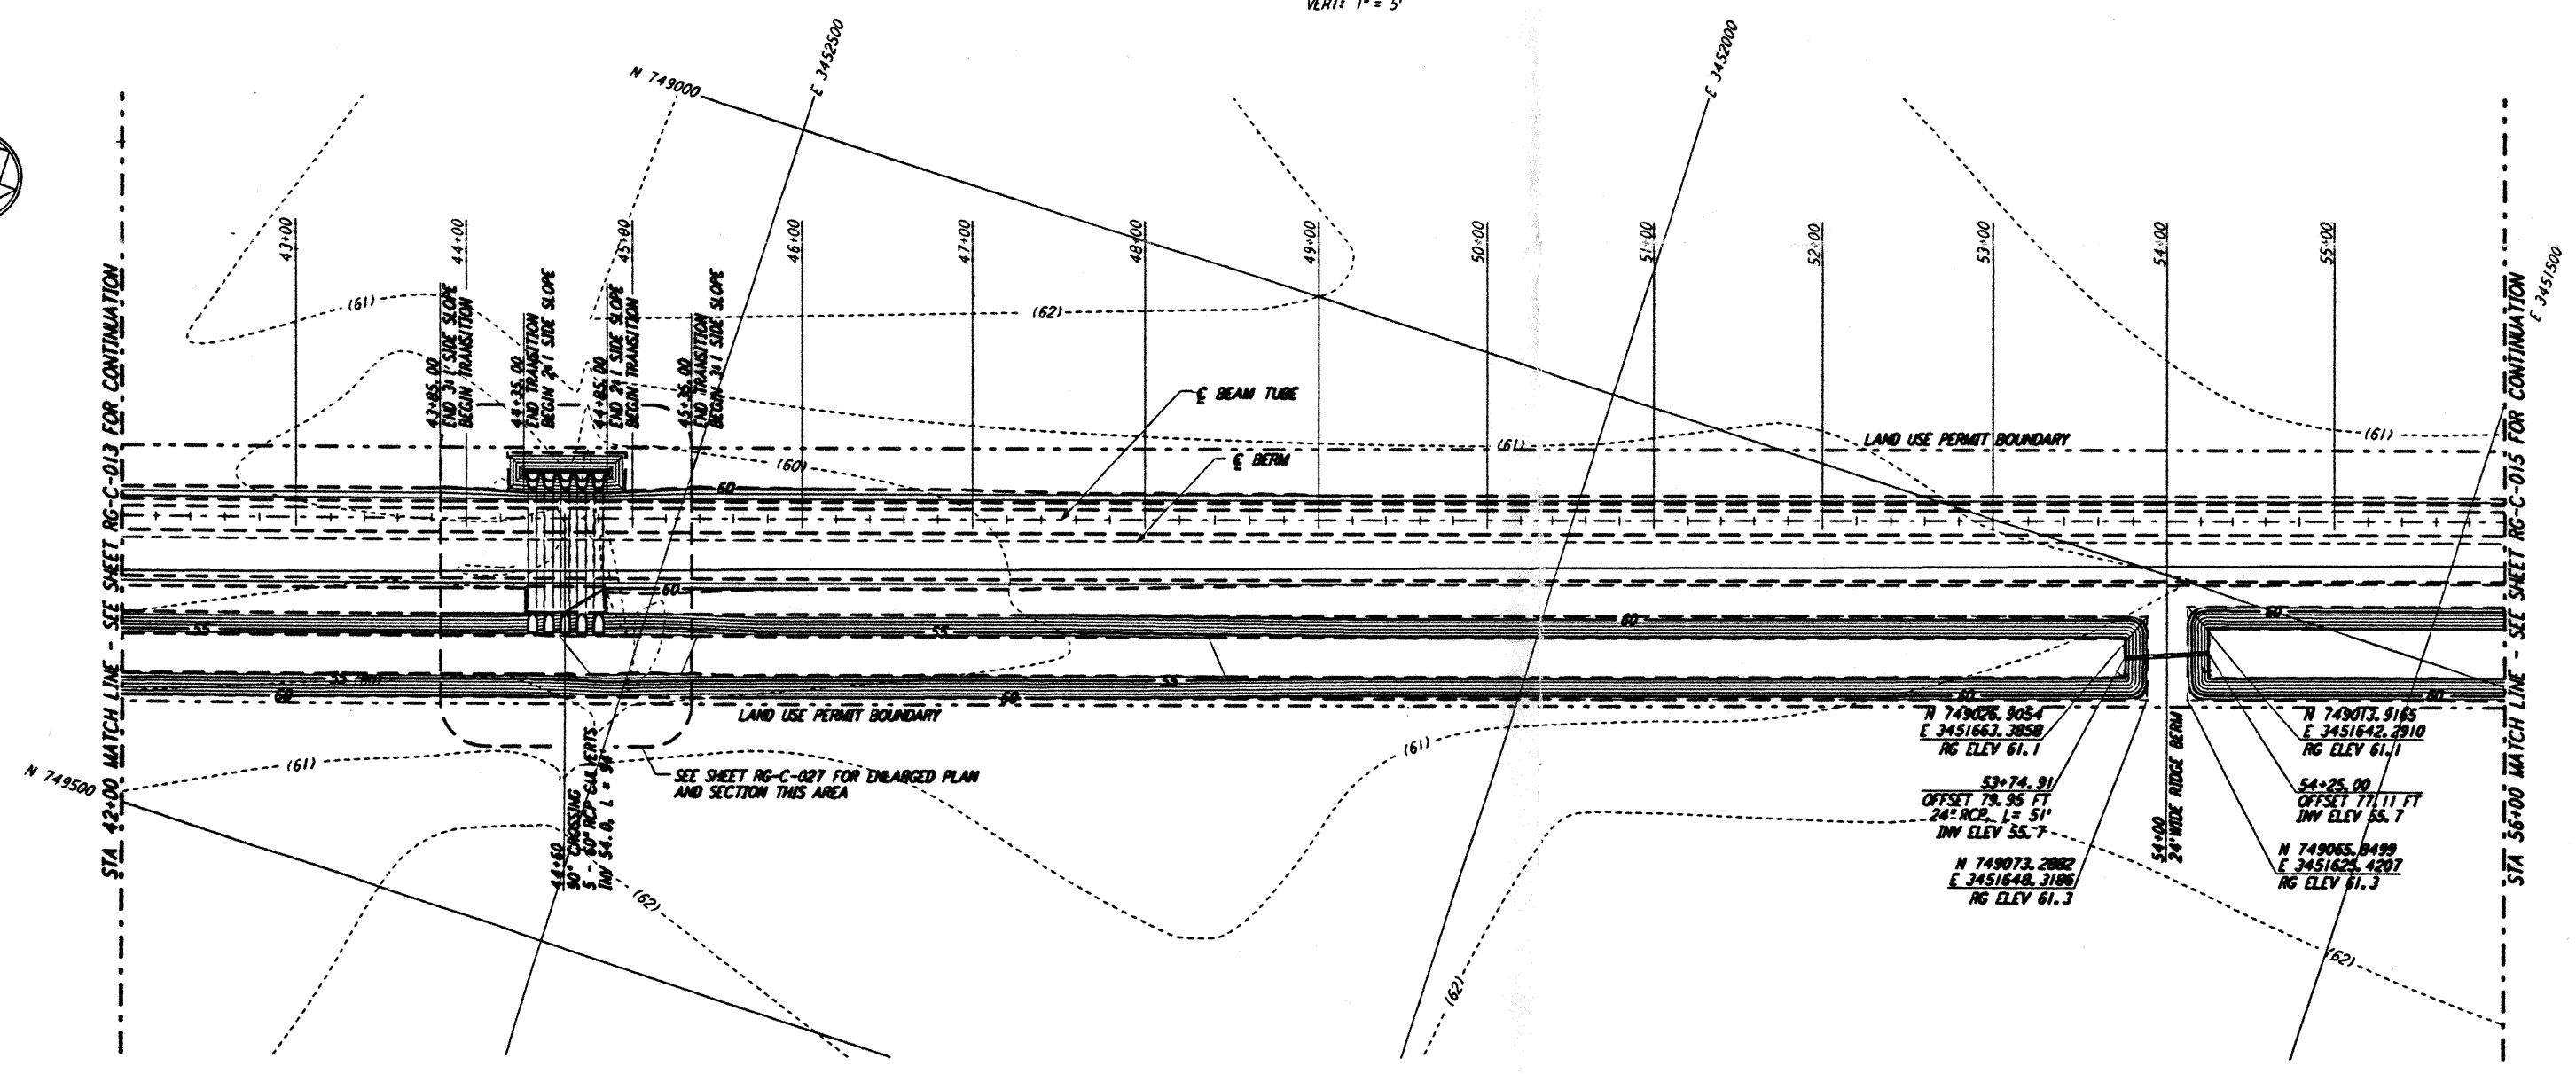

**PROFILE**  
 SCALES: HORIZ: 1" = 50'  
 VERT: 1" = 5'

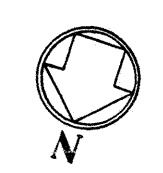

**PLAN**  
 SCALE: 1" = 50'

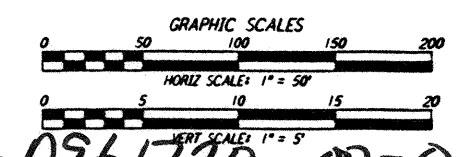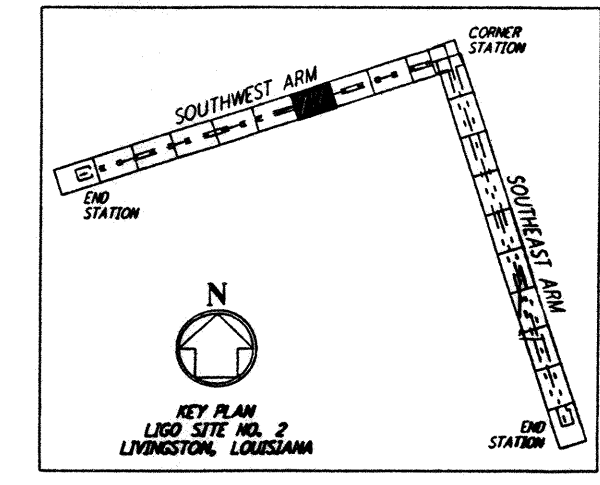

**LIGO-0961720-00-0**  
**LASER INTERFEROMETER**  
**GRAVITATIONAL-WAVE OBSERVATORY**  
**ROUGH GRADING - LIVINGSTON, LA**  
 TITLE: **ROUGH GRADING SOUTHWEST ARM PLAN AND PROFILE STA 42+00 TO STA 56+00**  
 AS NOTED: **PP150969 8094**  
 SHEET NUMBER: **RG-C-014**

**PARSONS**  
 100 WEST WALNUT STREET  
 PASADENA, CALIFORNIA

**LIGO**  
 CALIFORNIA INSTITUTE OF TECHNOLOGY  
 MASSACHUSETTS INSTITUTE OF TECHNOLOGY

NO.	DATE	APPRO BY	DESCRIPTION OF REVISION	NO.	DATE	APPRO BY	ISSUED FOR
1	8/28/95	DIT	ISSUED FOR BID	1	8/11/95	WRB	DATE
2				2		MGR	DRAWN
3				3		MGR	CHECKED
4				4		MGR	ENGINEER
5				5		MGR	PROJ MGR
6				6			
7				7			
8				8			
9				9			

This document and the design it covers are the property of **PARSONS**. They are loaned only with the borrower's expressed written agreement that they will not be reproduced, copied, loaned, exhibited, or used in any other way, except by written consent from **PARSONS** to the borrower.