



not be reproduced, copied, loaned, exhibited, or used in any other way, except by written consent from PARSONS to the borrower.

This document and the design it covers are the property of PARSONS. They are loaned only with the borrower's expressed written agreement that they will


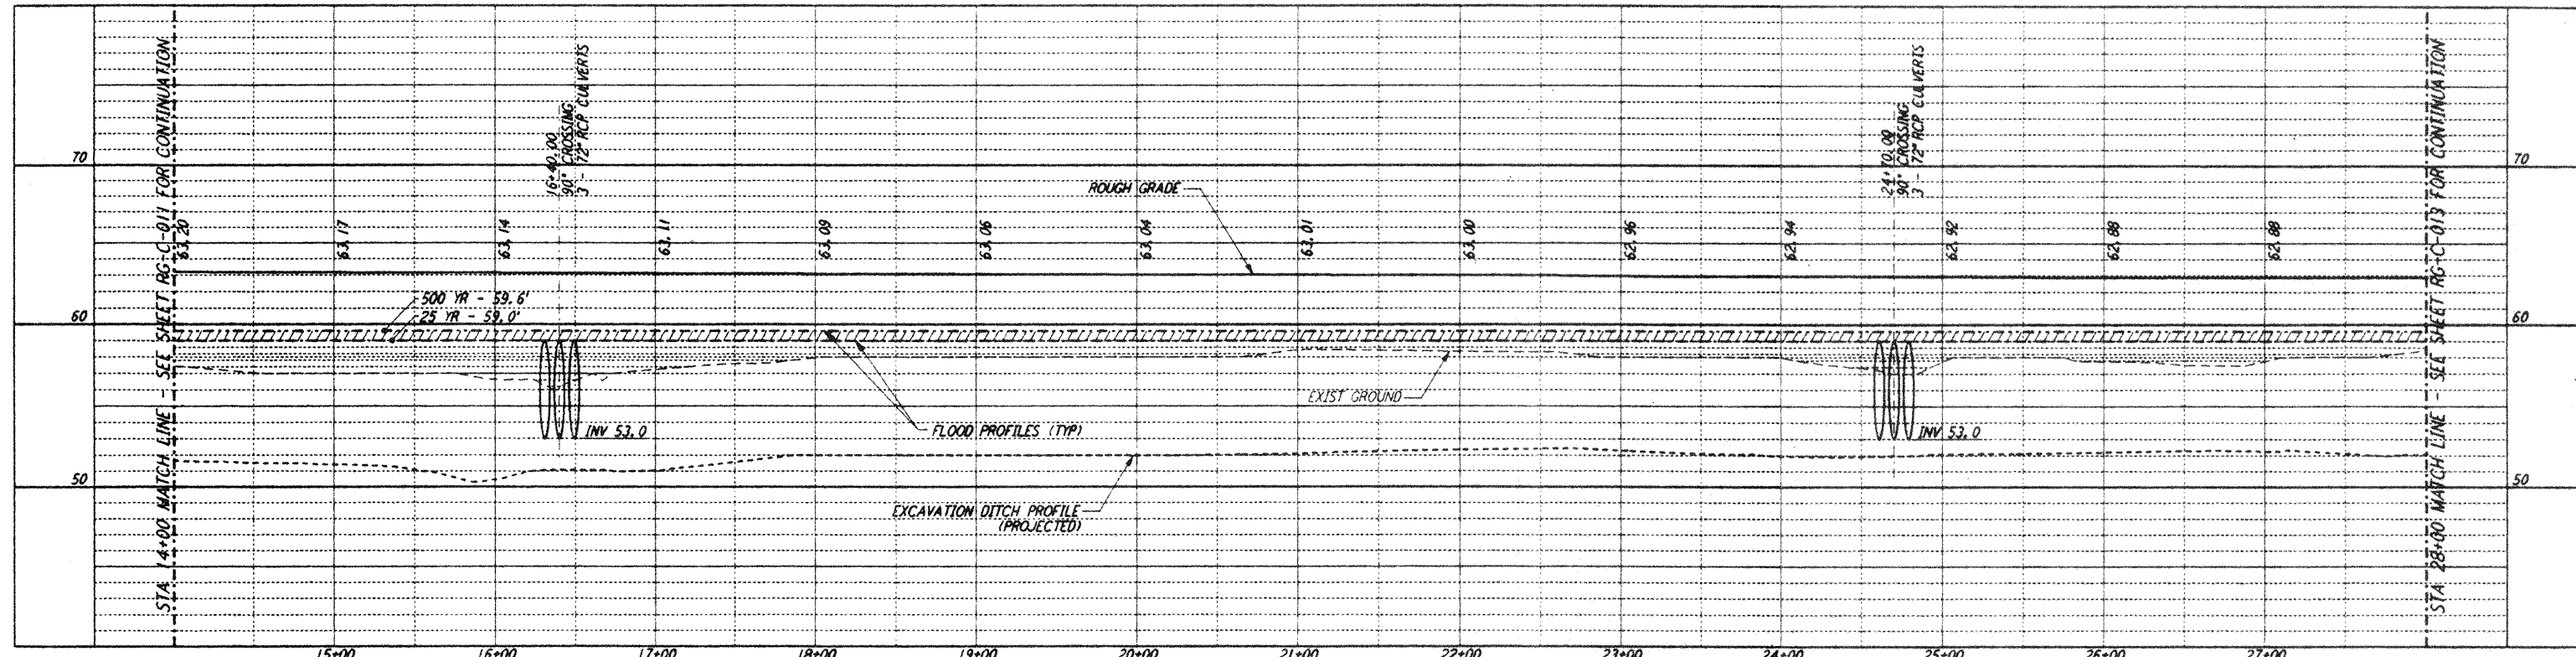


**PROFILE**  
 SCALES: HORIZ: 1" = 50'  
 VERT: 1" = 5'

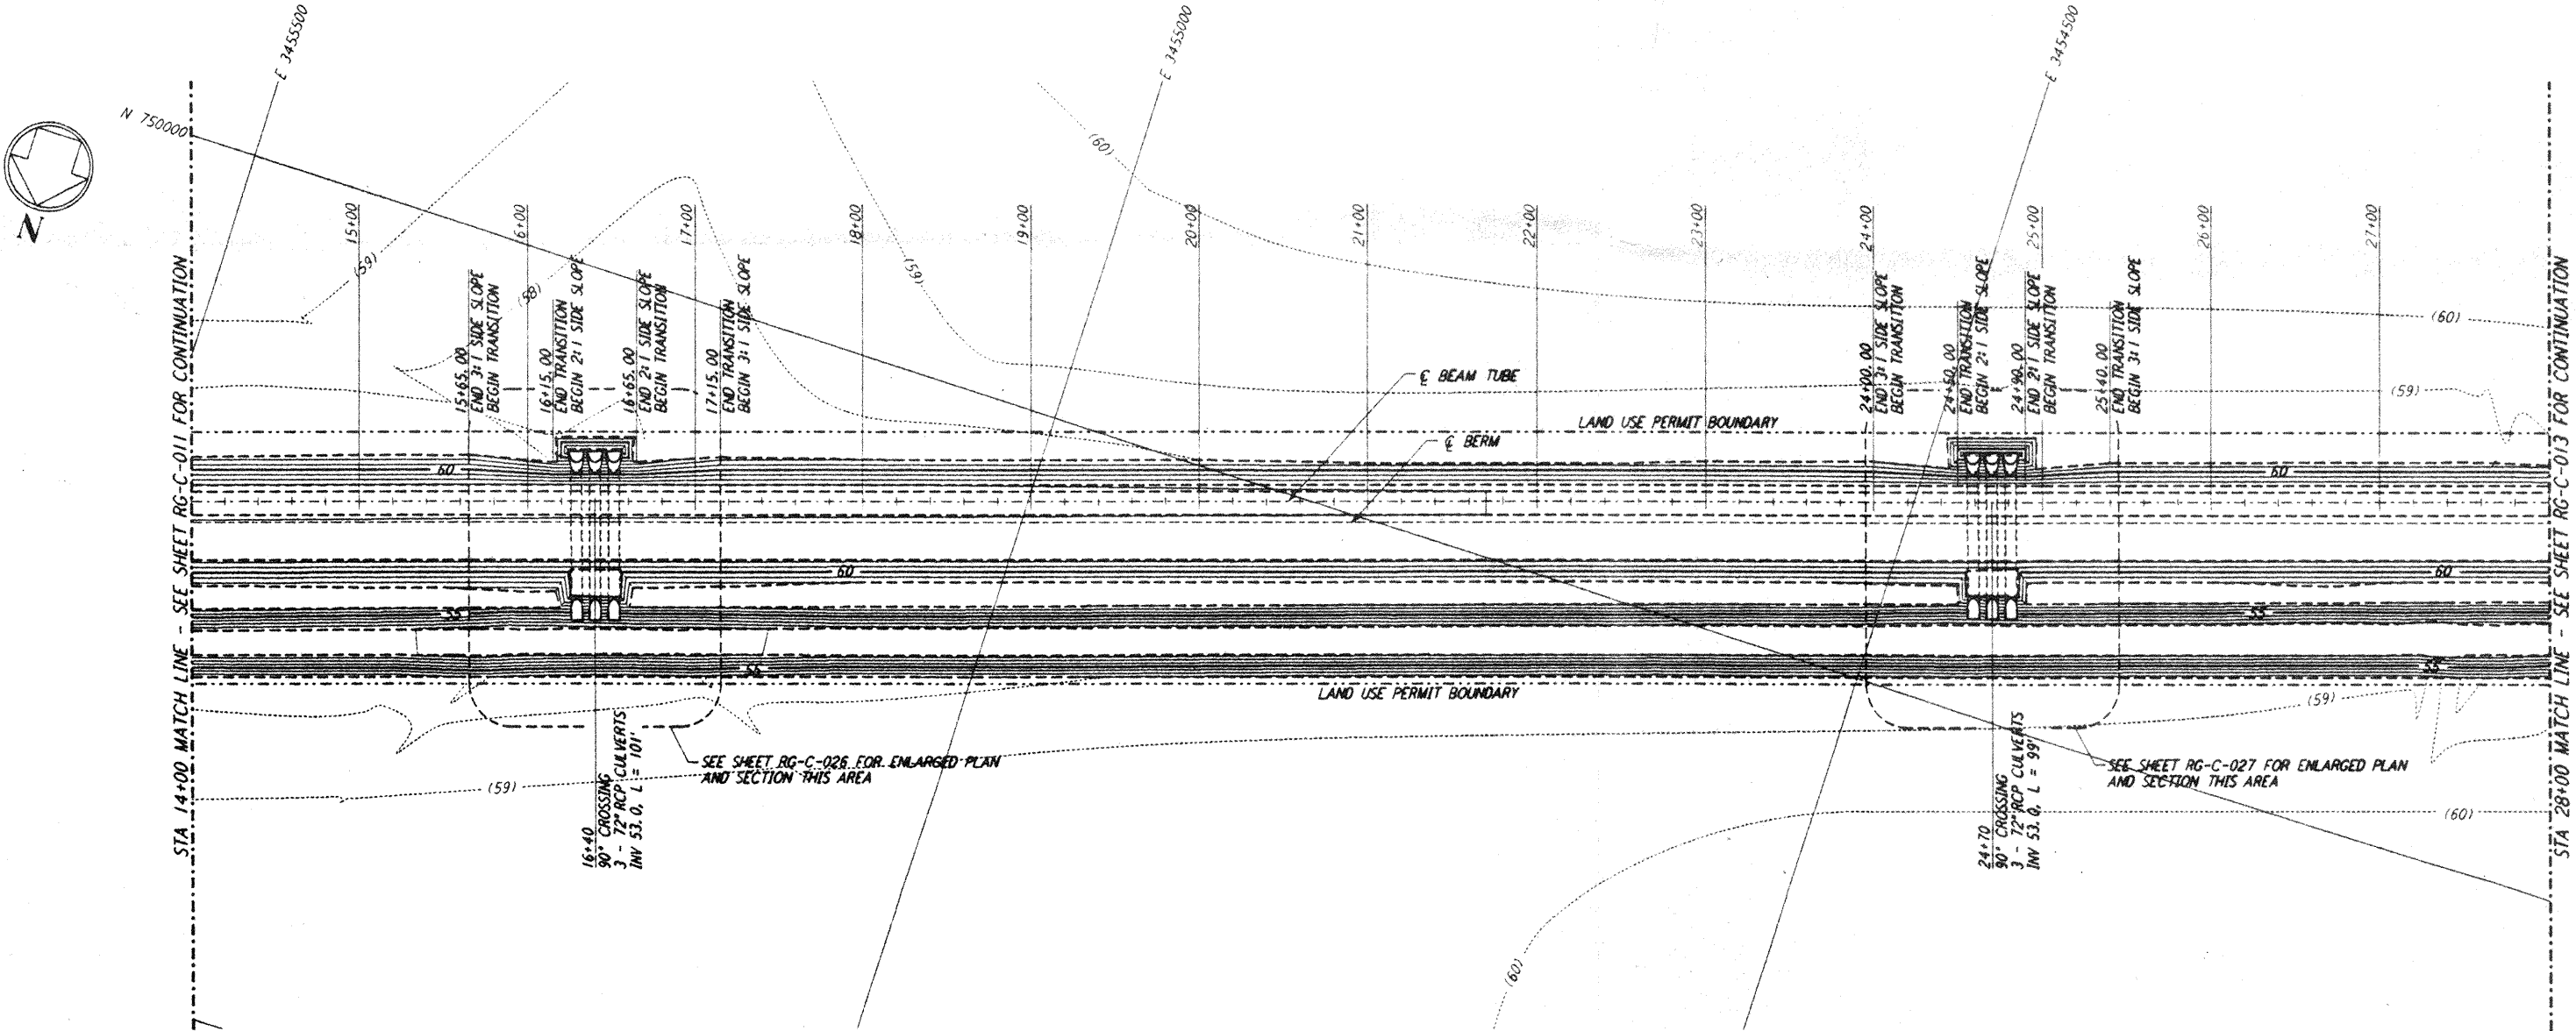

**PLAN**  
 SCALE: 1" = 50'

**NOTES:**  
 1. SEE SHEET RG-C-002 FOR GENERAL NOTES, LEGEND AND ABBREVIATIONS.

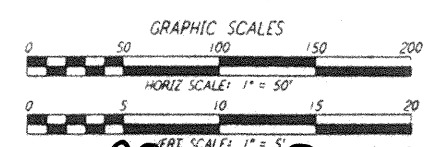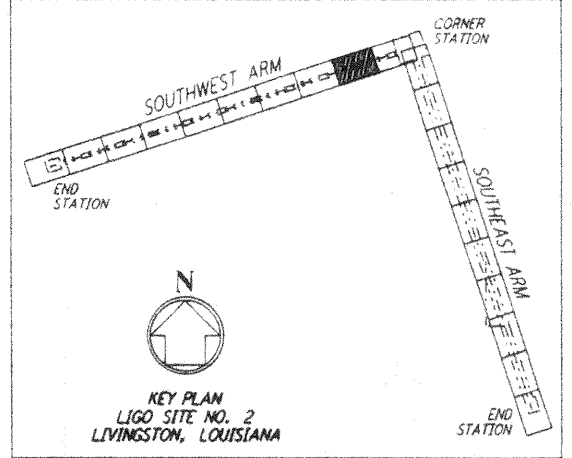


**L160-0961718-01-0**

LASER INTERFEROMETER GRAVITATIONAL-WAVE OBSERVATORY ROUGH GRADING - LIVINGSTON, LA			
TITLE	AS NOTED	PROJECT NUMBER	PROJECT CODE
ROUGH GRADING SOUTHWEST ARM PLAN AND PROFILE STA 14+00 TO STA 28+00	PP150969	8094	
SHEET NUMBER		RG-C-012	

NO.	DATE	APPROD BY	DESCRIPTION OF REVISION
1	11/1/95	Tom	NO REVISIONS

NO.	DATE	APPROD BY	ISSUED FOR
2	11/1/95	Tom	ISSUED FOR CONSTRUCTION
1	8/28/95	Tom	ISSUED FOR BID

DATE	8/11/95
DRAWN	WRB 8/95
CHECKED	MCP 8/8/95
ENGINEER	8/28/95
PROJ MGR	8/28/95

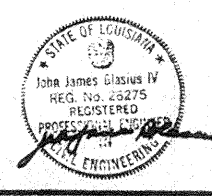

**PARSONS**  
 100 WEST WALNUT STREET  
 PASADENA, CALIFORNIA

**LIGO**  
 CALIFORNIA INSTITUTE OF TECHNOLOGY  
 MASSACHUSETTS INSTITUTE OF TECHNOLOGY