



- NOTES:**
- SEE SHEET LA-C-502 FOR GENERAL NOTES, LEGEND AND ABBREVIATIONS.
 - SEE SHEET LA-C-504 FOR TYPICAL SECTIONS AND DETAILS.



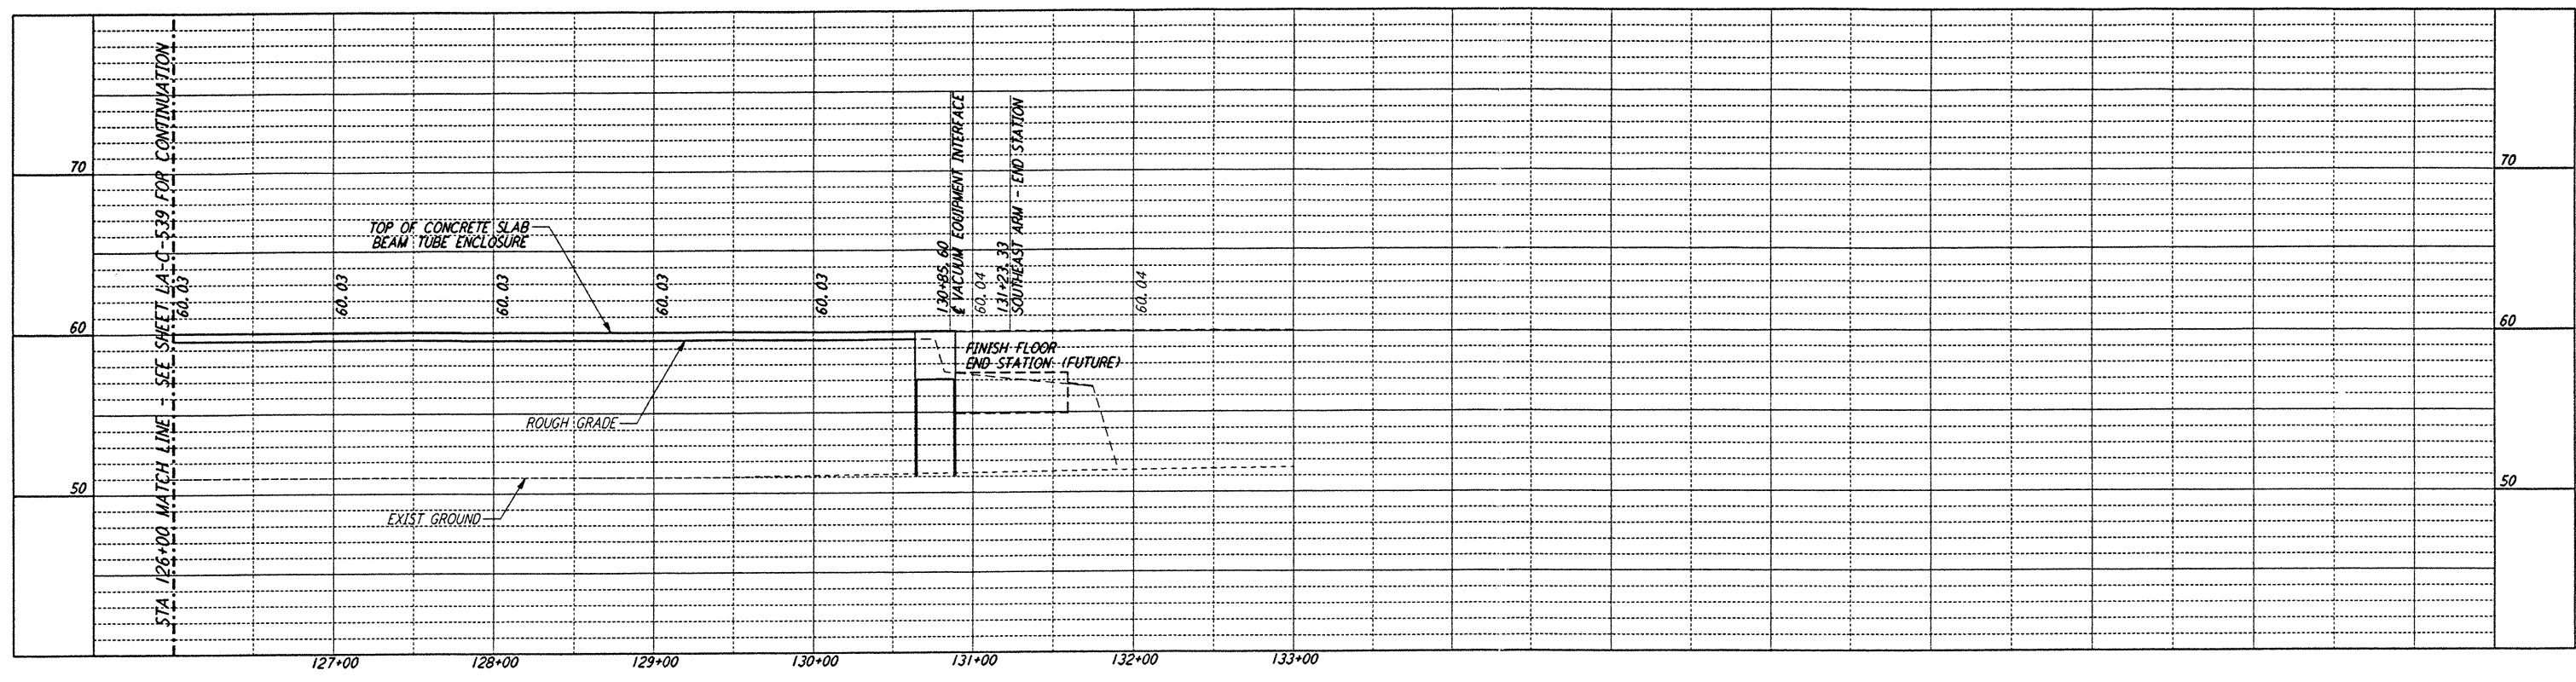


CURVE DATA					
Δ	RADIUS	LENGTH	TANGENT	REMARK	
1 35°00'00"	110'	67.19'	34.68'	⚡ ROAD	
2 35°00'00"	100'	61.07'	31.53'	⚡ ROAD	

PROFILE
 SCALES: HORIZ: 1" = 50'
 VERT: 1" = 5'

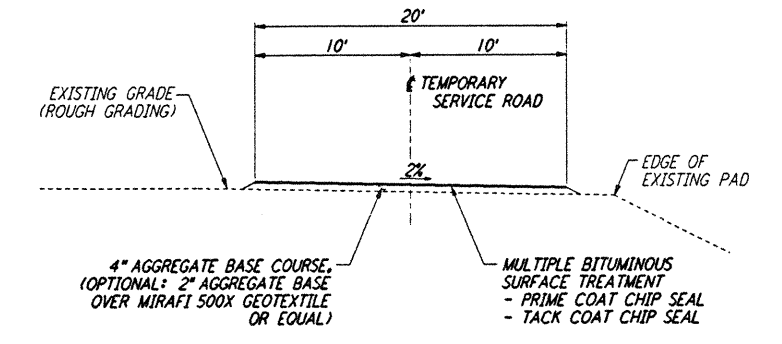

TEMPORARY SERVICE ROAD
 NOT TO SCALE

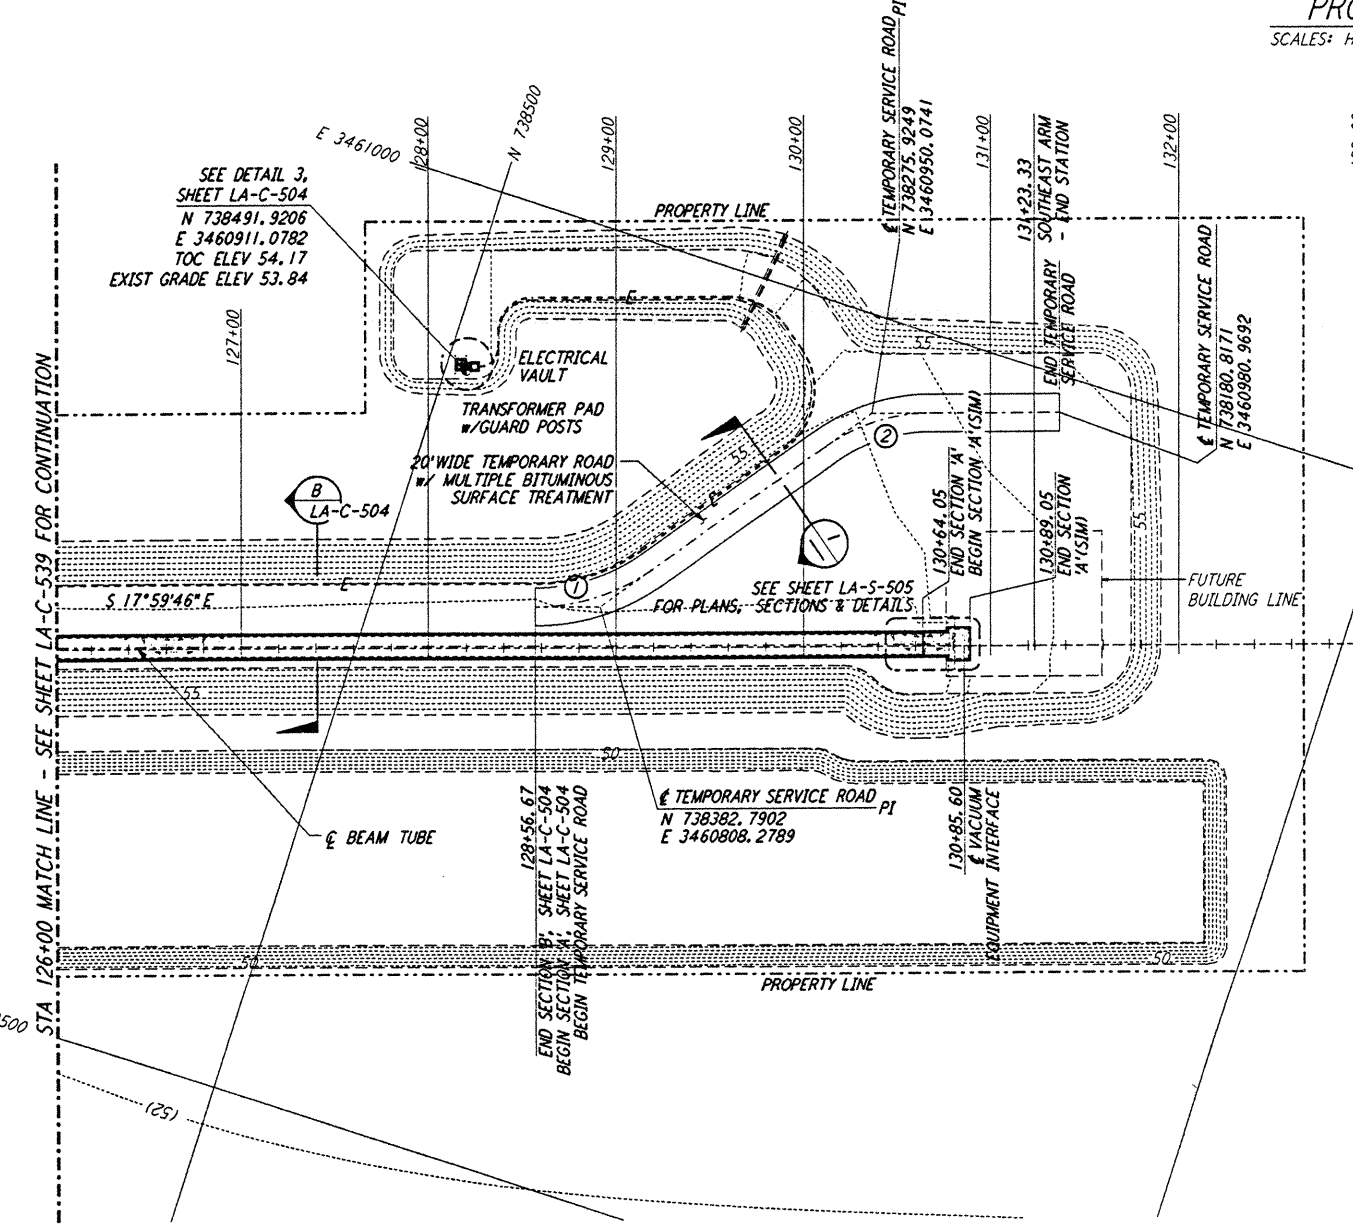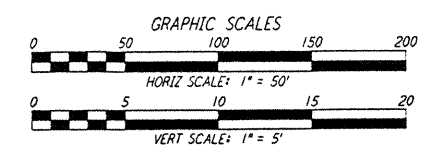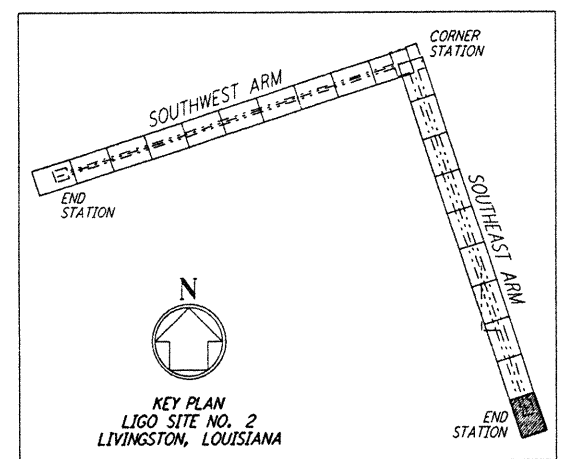


PLAN
 SCALE: 1" = 50'

This document and the design it covers are the property of PARSONS. They are loaned only with the borrower's expressed written agreement that they will not be reproduced, copied, loaned, exhibited, or used in any other way, except by written consent from PARSONS to the borrower.

DRAWING NO.	DESCRIPTION	NO.	DATE	BY	CHKD	ENGR	PROJ	DESCRIPTION

ISSUED FOR CONSTRUCTION	DATE
DRAWN	11-15-96
CHECKED	11-15-96
ENGINEER	11/15/96
PROJ	11/15/96

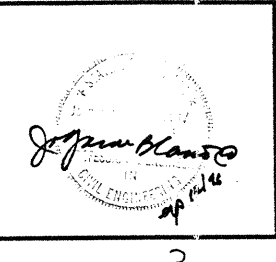

PARSONS
 100 WEST WALNUT STREET
 PASADENA, CALIFORNIA

LIGO
 CALIFORNIA INSTITUTE OF TECHNOLOGY
 MASSACHUSETTS INSTITUTE OF TECHNOLOGY

LASER INTERFEROMETER GRAVITATIONAL-WAVE OBSERVATORY BEAM TUBE ENCLOSURE - LIVINGSTON, LA

TITLE	CIVIL SOUTHWEST ARM PLAN AND PROFILE STA 126+00 TO STA 133+00	SHEET NUMBER	LA-C-540
SCALE	AS NOTED	CONTRACT NUMBER	PP150969
PROJECT NUMBER	8094	REVISIONS	