





NOTES:
 1. SEE SHEET LA-C-502 FOR GENERAL NOTES, LEGEND AND ABBREVIATIONS.
 2. SEE SHEET LA-C-504 FOR TYPICAL SECTIONS AND DETAILS.

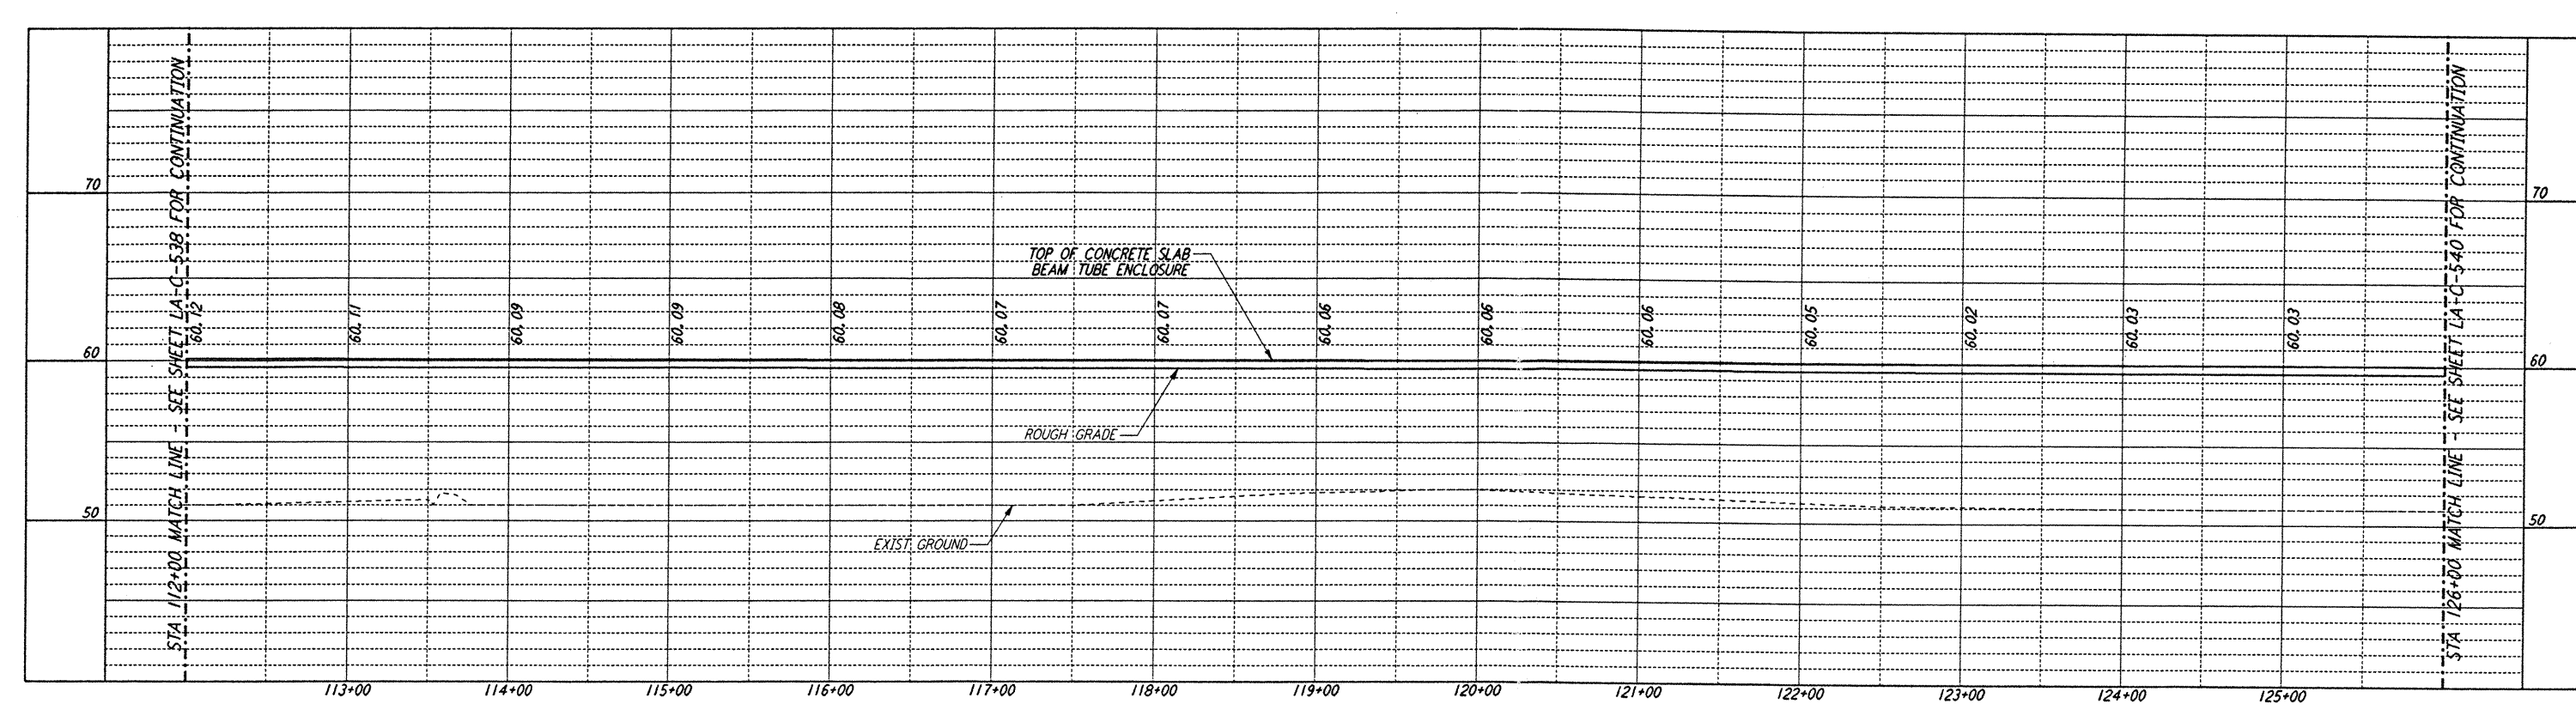

PROFILE
 SCALES: HORIZ: 1" = 50'
 VERT: 1" = 5'

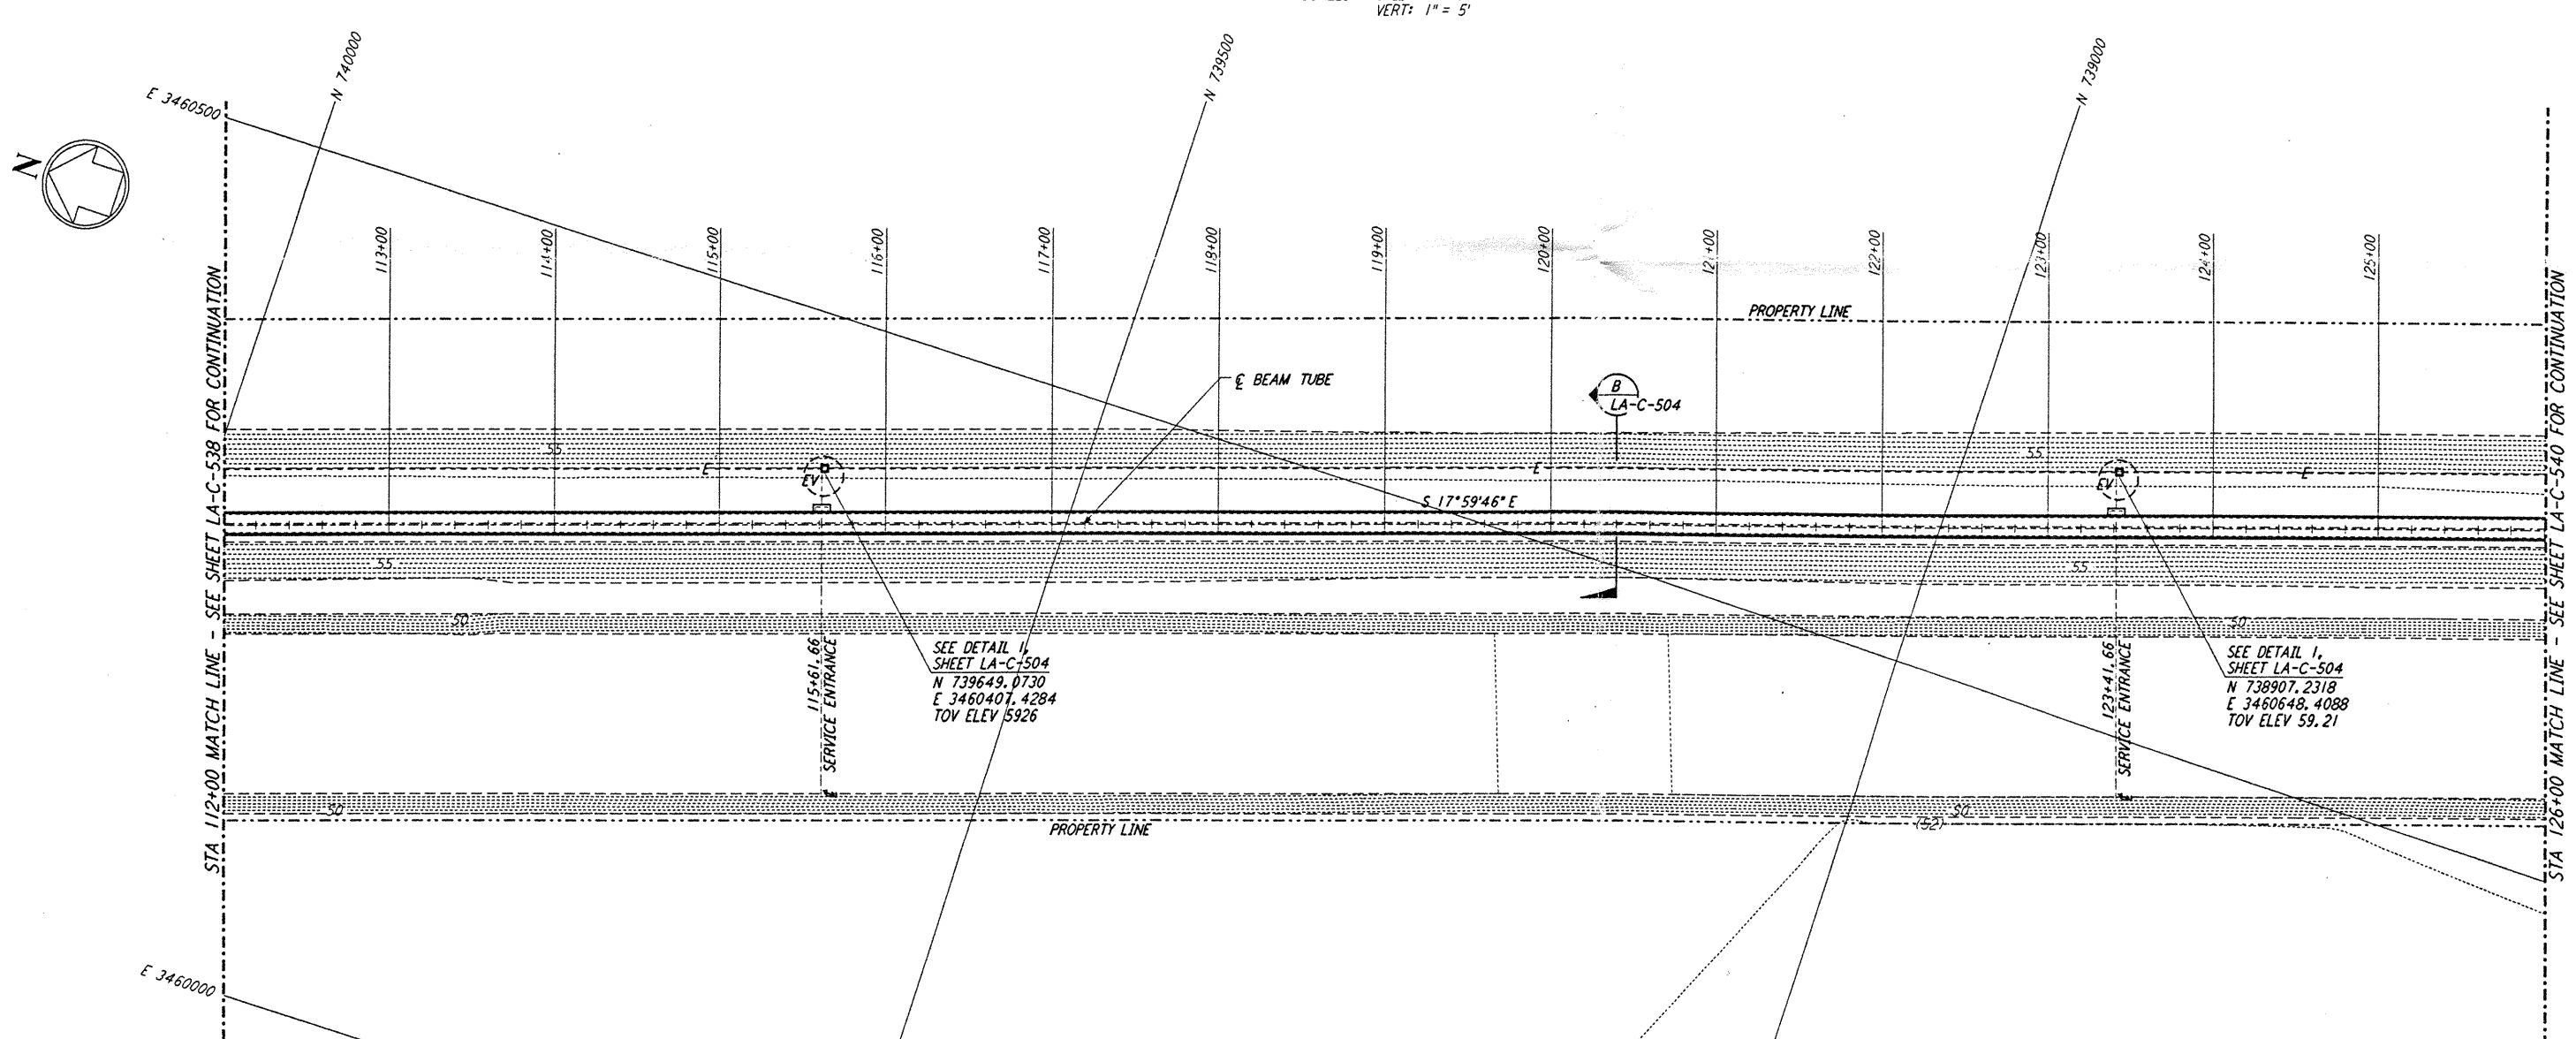

PLAN
 SCALE: 1" = 50'

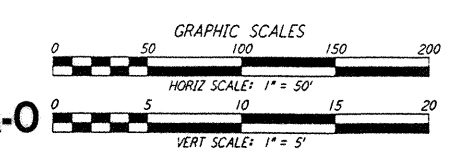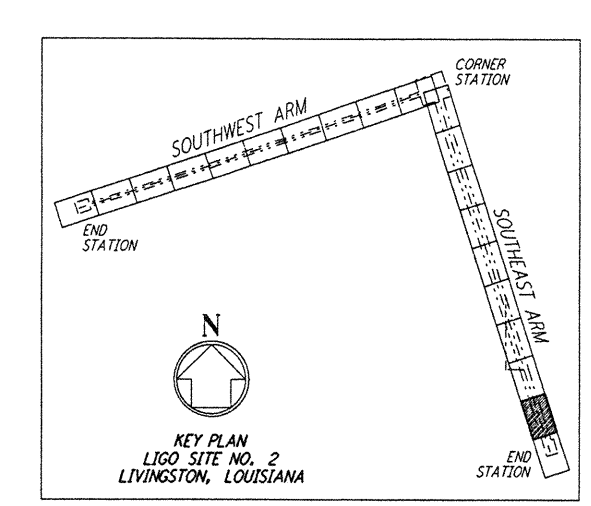

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NO.	DATE	BY	CHKD	ENGR	PROJ	DESCRIPTION
A	6/28/96	WRB	MLK	MD	MM	FINAL DESIGN REVIEW

DRAWN	WRB	6/24/96
CHECKED		
ENGINEER		
PROJ		

DRAWING NO.	DESCRIPTION
5	

PARSONS
 100 WEST WALNUT STREET
 PASADENA, CALIFORNIA

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LASER INTERFEROMETER
 GRAVITATIONAL-WAVE OBSERVATORY
 BTE SITework & FABRICATION - LIVINGSTON, LA

TITLE	CIVIL	AS NOTED	PP150969	8094
SHEET NUMBER	SOUTHEAST ARM	LA-C-539		
PLAN AND PROFILE		STA 112+00 TO STA 126+00		
LIGO-D961284-A-0		LIGO-D961284-A-0		