



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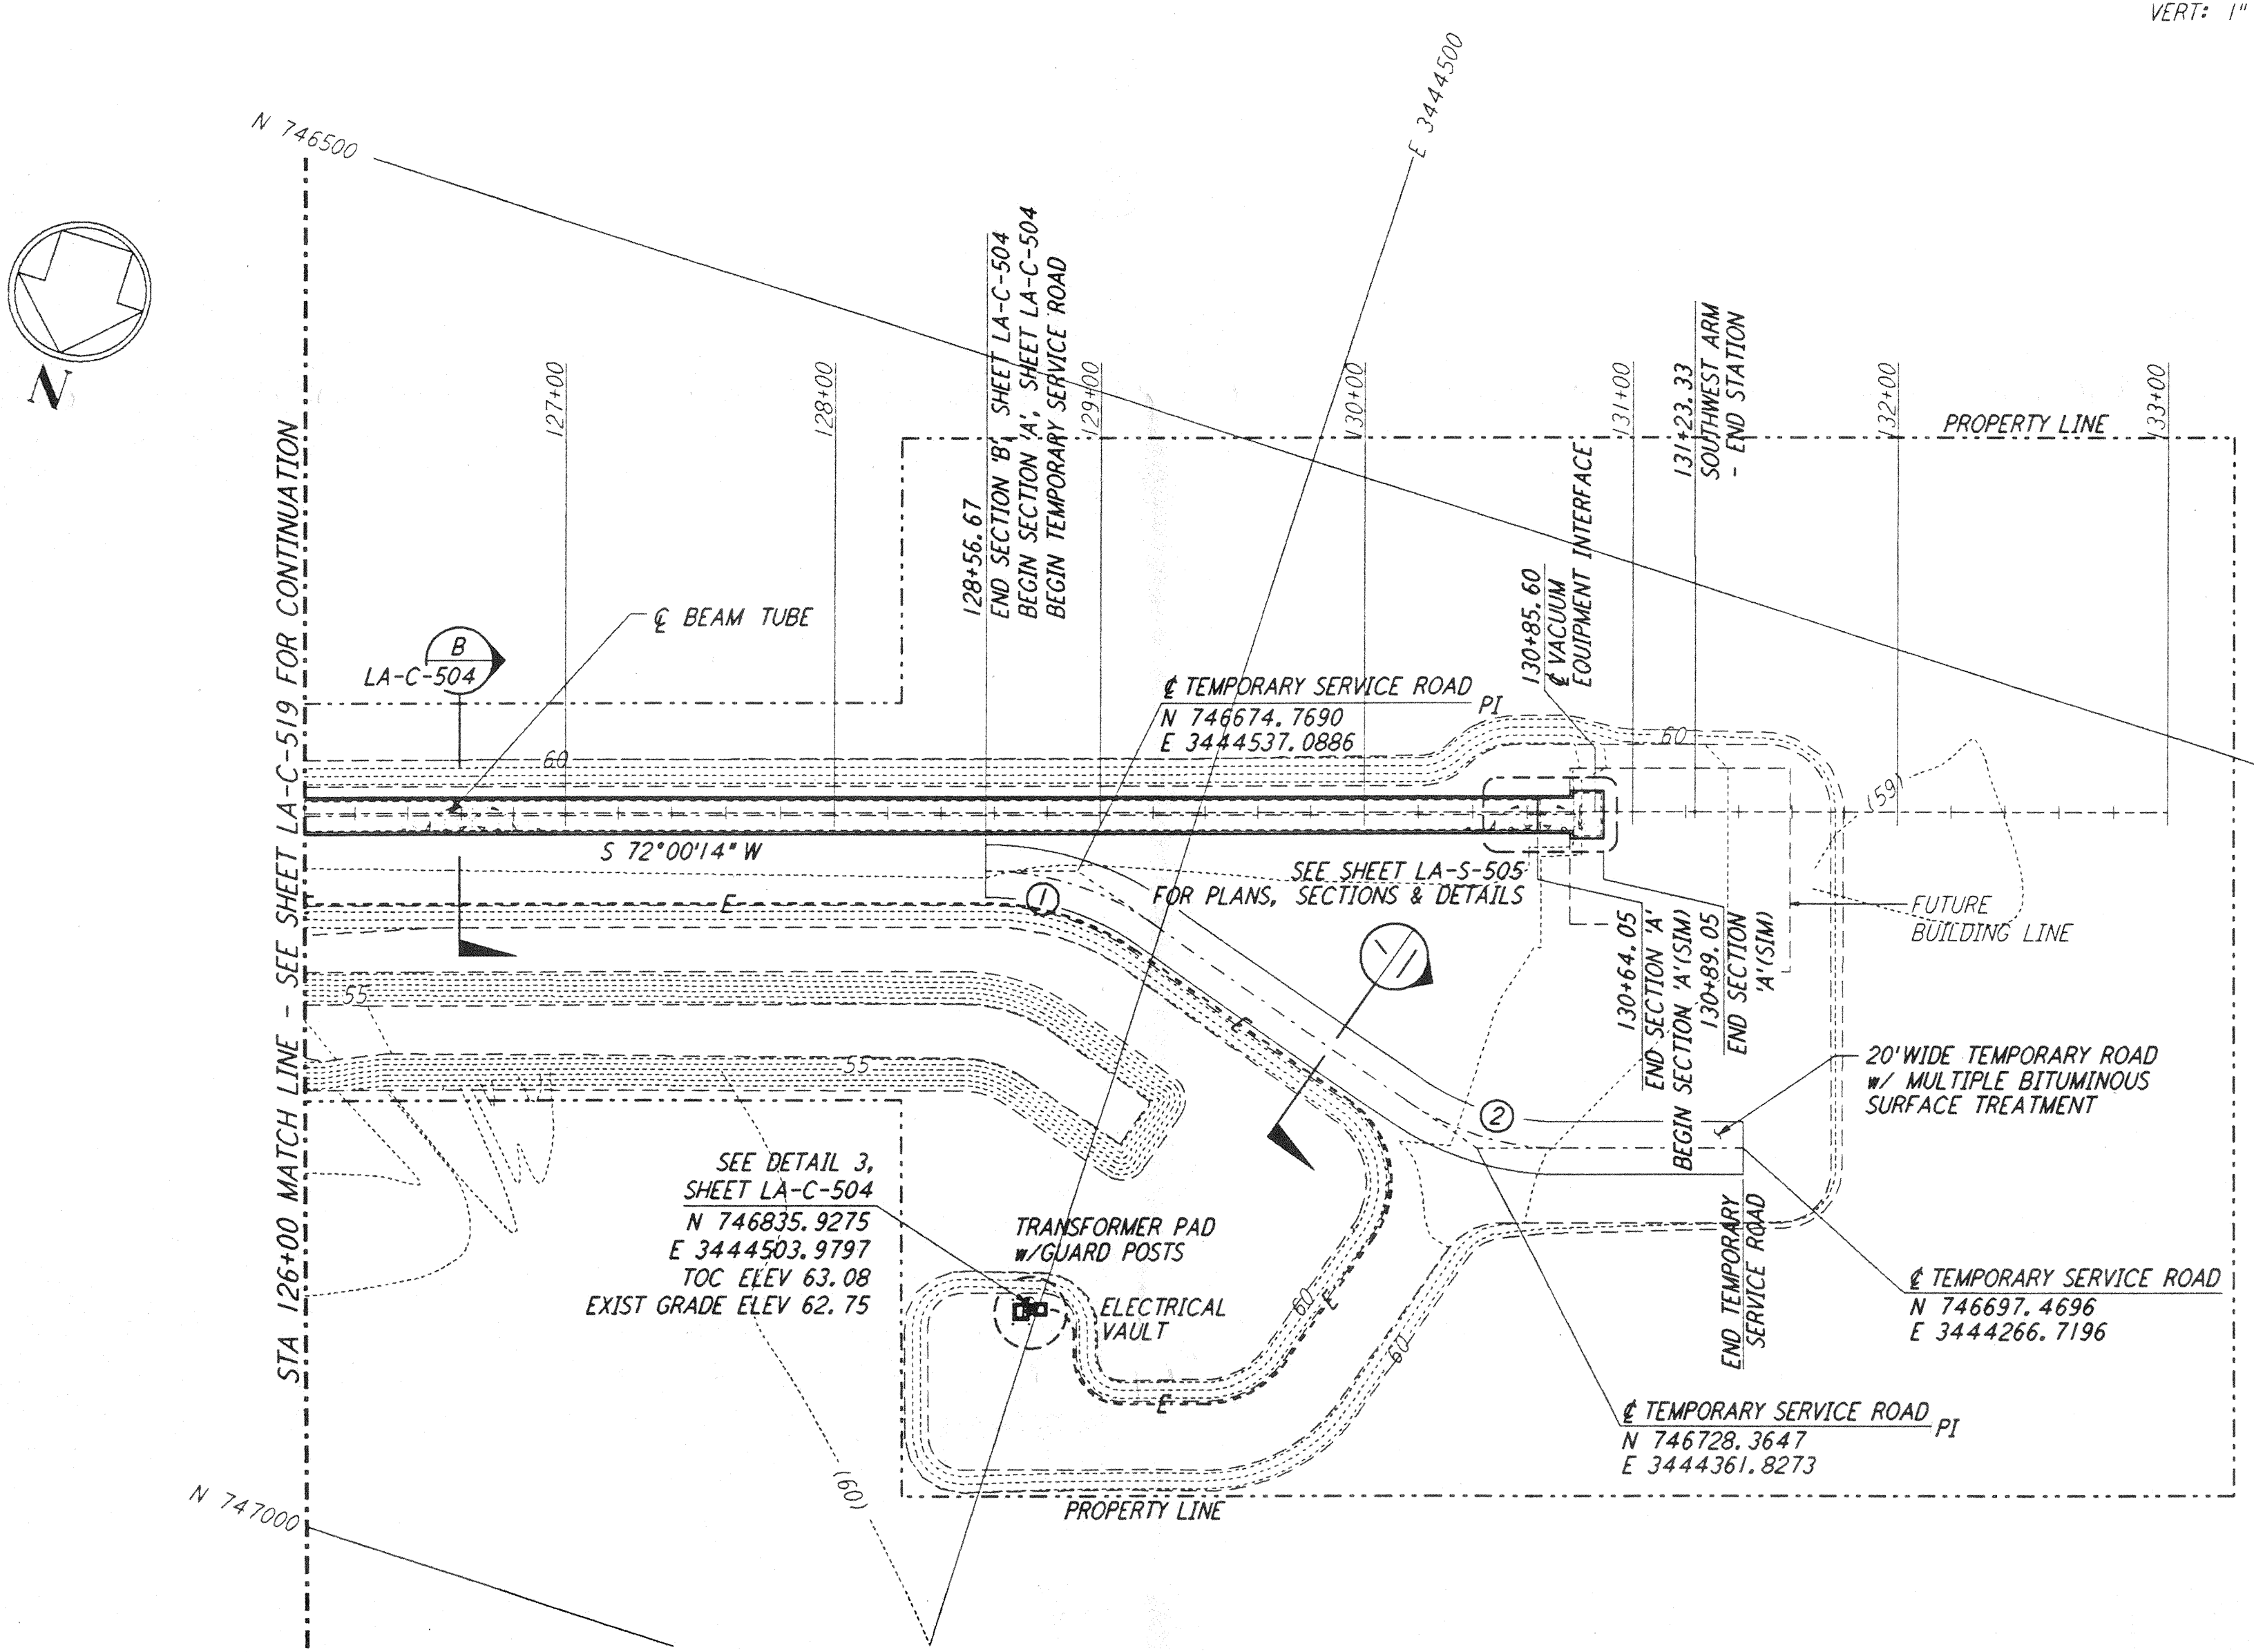
- NOTES:**
- SEE SHEET LA-C-502 FOR GENERAL NOTES, LEGEND AND ABBREVIATIONS.
 - SEE SHEET LA-C-504 FOR TYPICAL SECTIONS AND DETAILS.

| CURVE DATA | | | | | |
|------------|-----------|--------|---------|--------|------|
| Δ | RADIUS | LENGTH | TANGENT | REMARK | |
| 1 | 35°00'00" | 110' | 67.19' | 34.68' | ROAD |
| 2 | 35°00'00" | 100' | 61.07' | 31.53' | ROAD |



PROFILE
 SCALES: HORIZ: 1" = 50'
 VERT: 1" = 5'

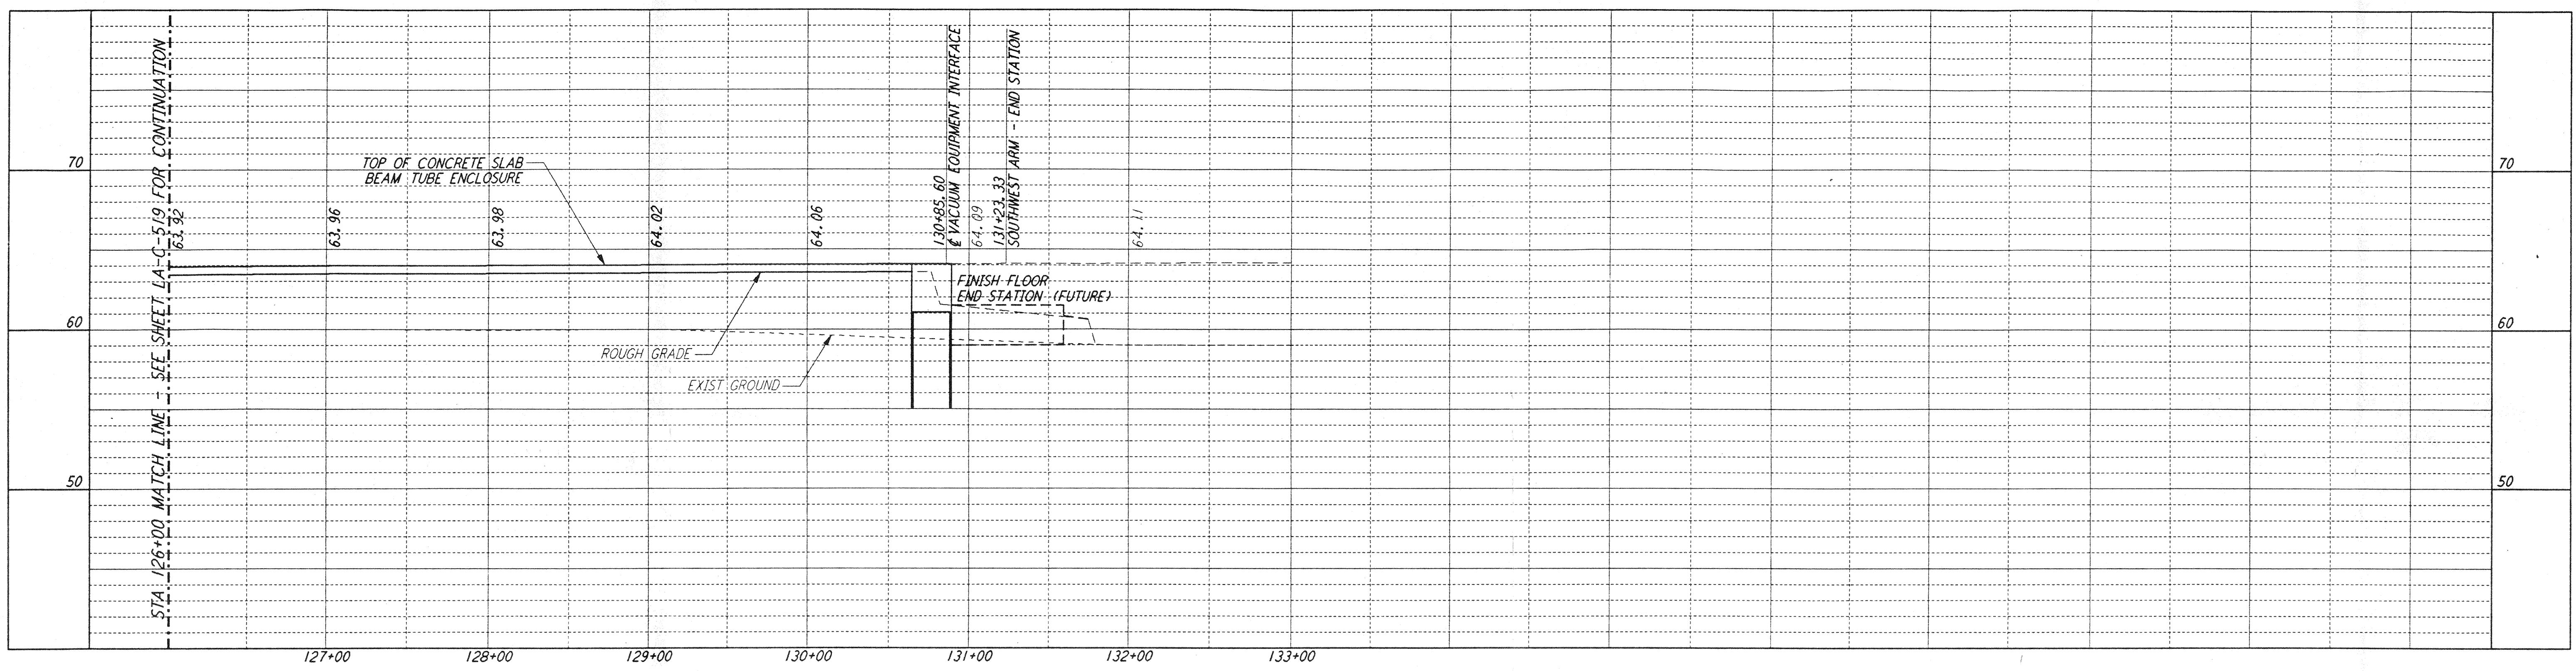

TEMPORARY SERVICE ROAD
 NOT TO SCALE

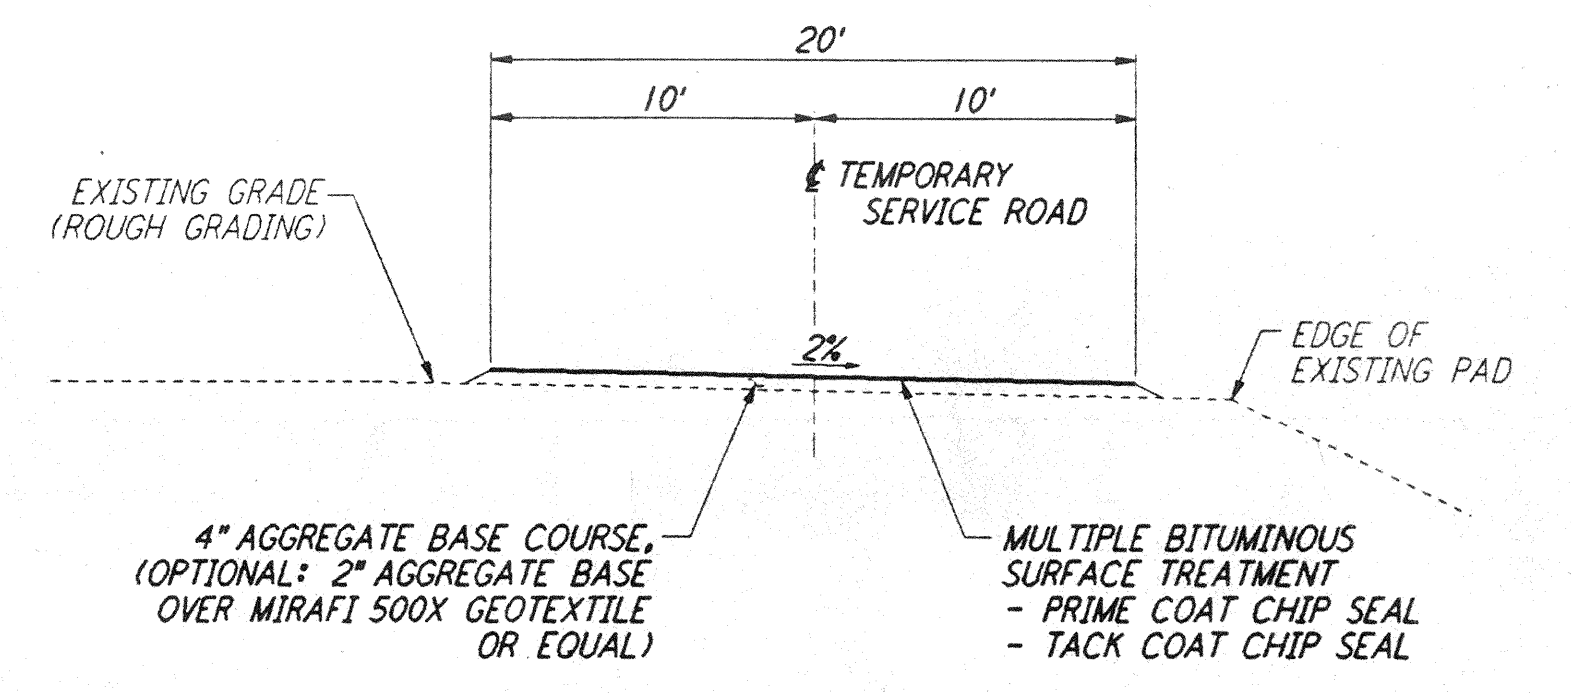

PLAN
 SCALE: 1" = 50'

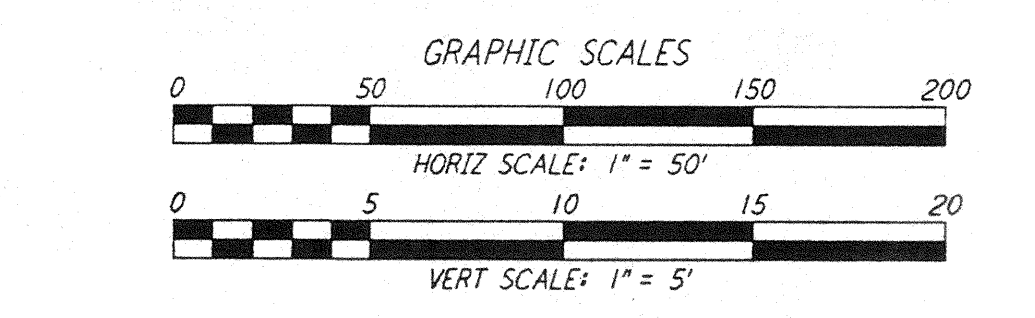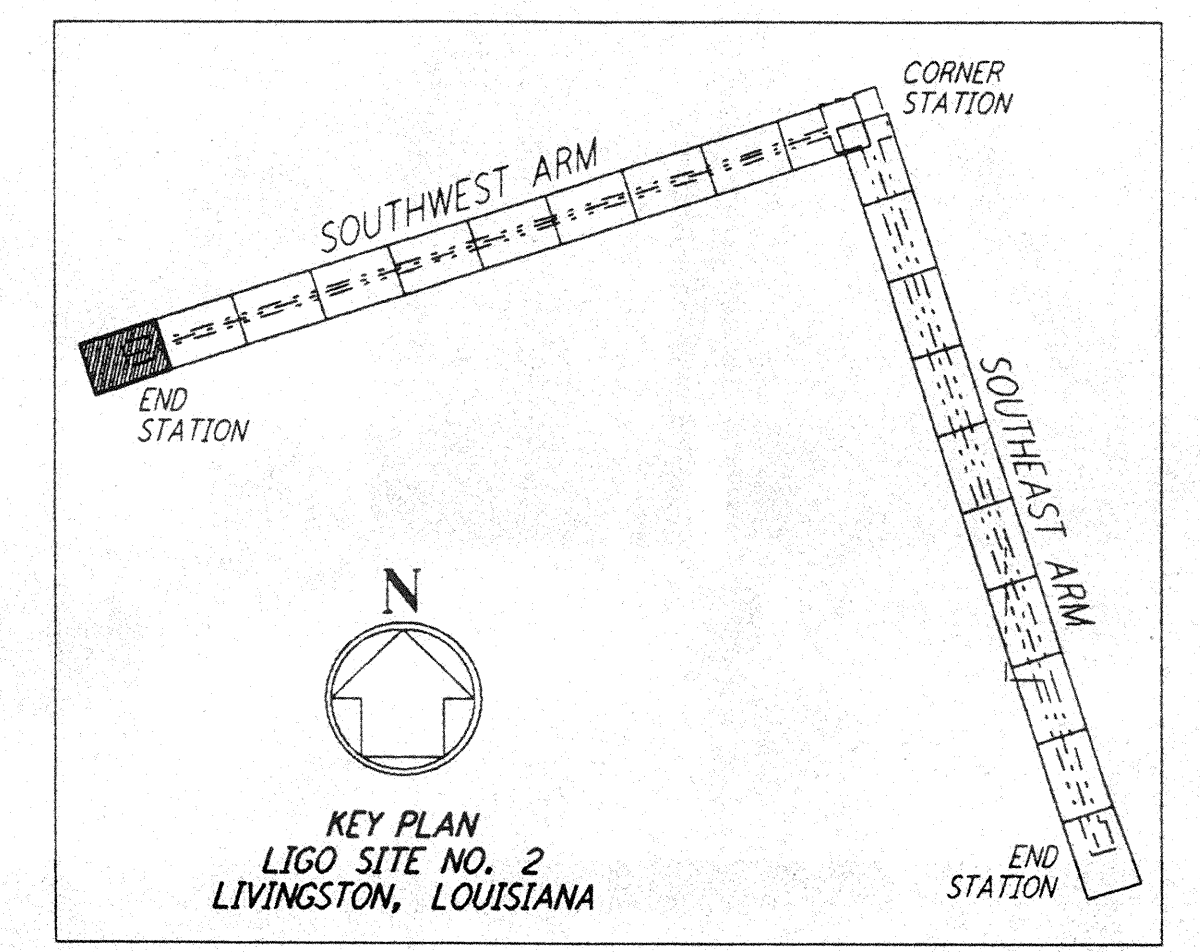

| DRAWING NO. | DESCRIPTION | NO. | DATE | BY | CHKD | ENGR | PROJ | DESCRIPTION |
|-------------|-------------|-----|------|----|------|------|------|-------------|
| | | | | | | | | |

| ISSUED FOR CONSTRUCTION | | |
|-------------------------|-----|----------|
| DRAWN | WRB | 11-15-96 |
| CHECKED | ML | 11-15-96 |
| ENGINEER | JB | 11/15/96 |
| PROJ | | 11/15/96 |

John Blawie
 11/15/96

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LASER INTERFEROMETER
 GRAVITATIONAL-WAVE OBSERVATORY
 BEAM TUBE ENCLOSURE - LIVINGSTON, LA

TITLE: CIVIL
 SOUTHWEST ARM
 PLAN AND PROFILE
 STA 126+00 TO STA 133+00

SCALE: AS NOTED
 CONTRACT NUMBER: PPI50969
 PROJECT NUMBER: 8094

REVISIONS: **LA-C-520**