



**POWER PLAN**  
 1/8" = 1'-0"

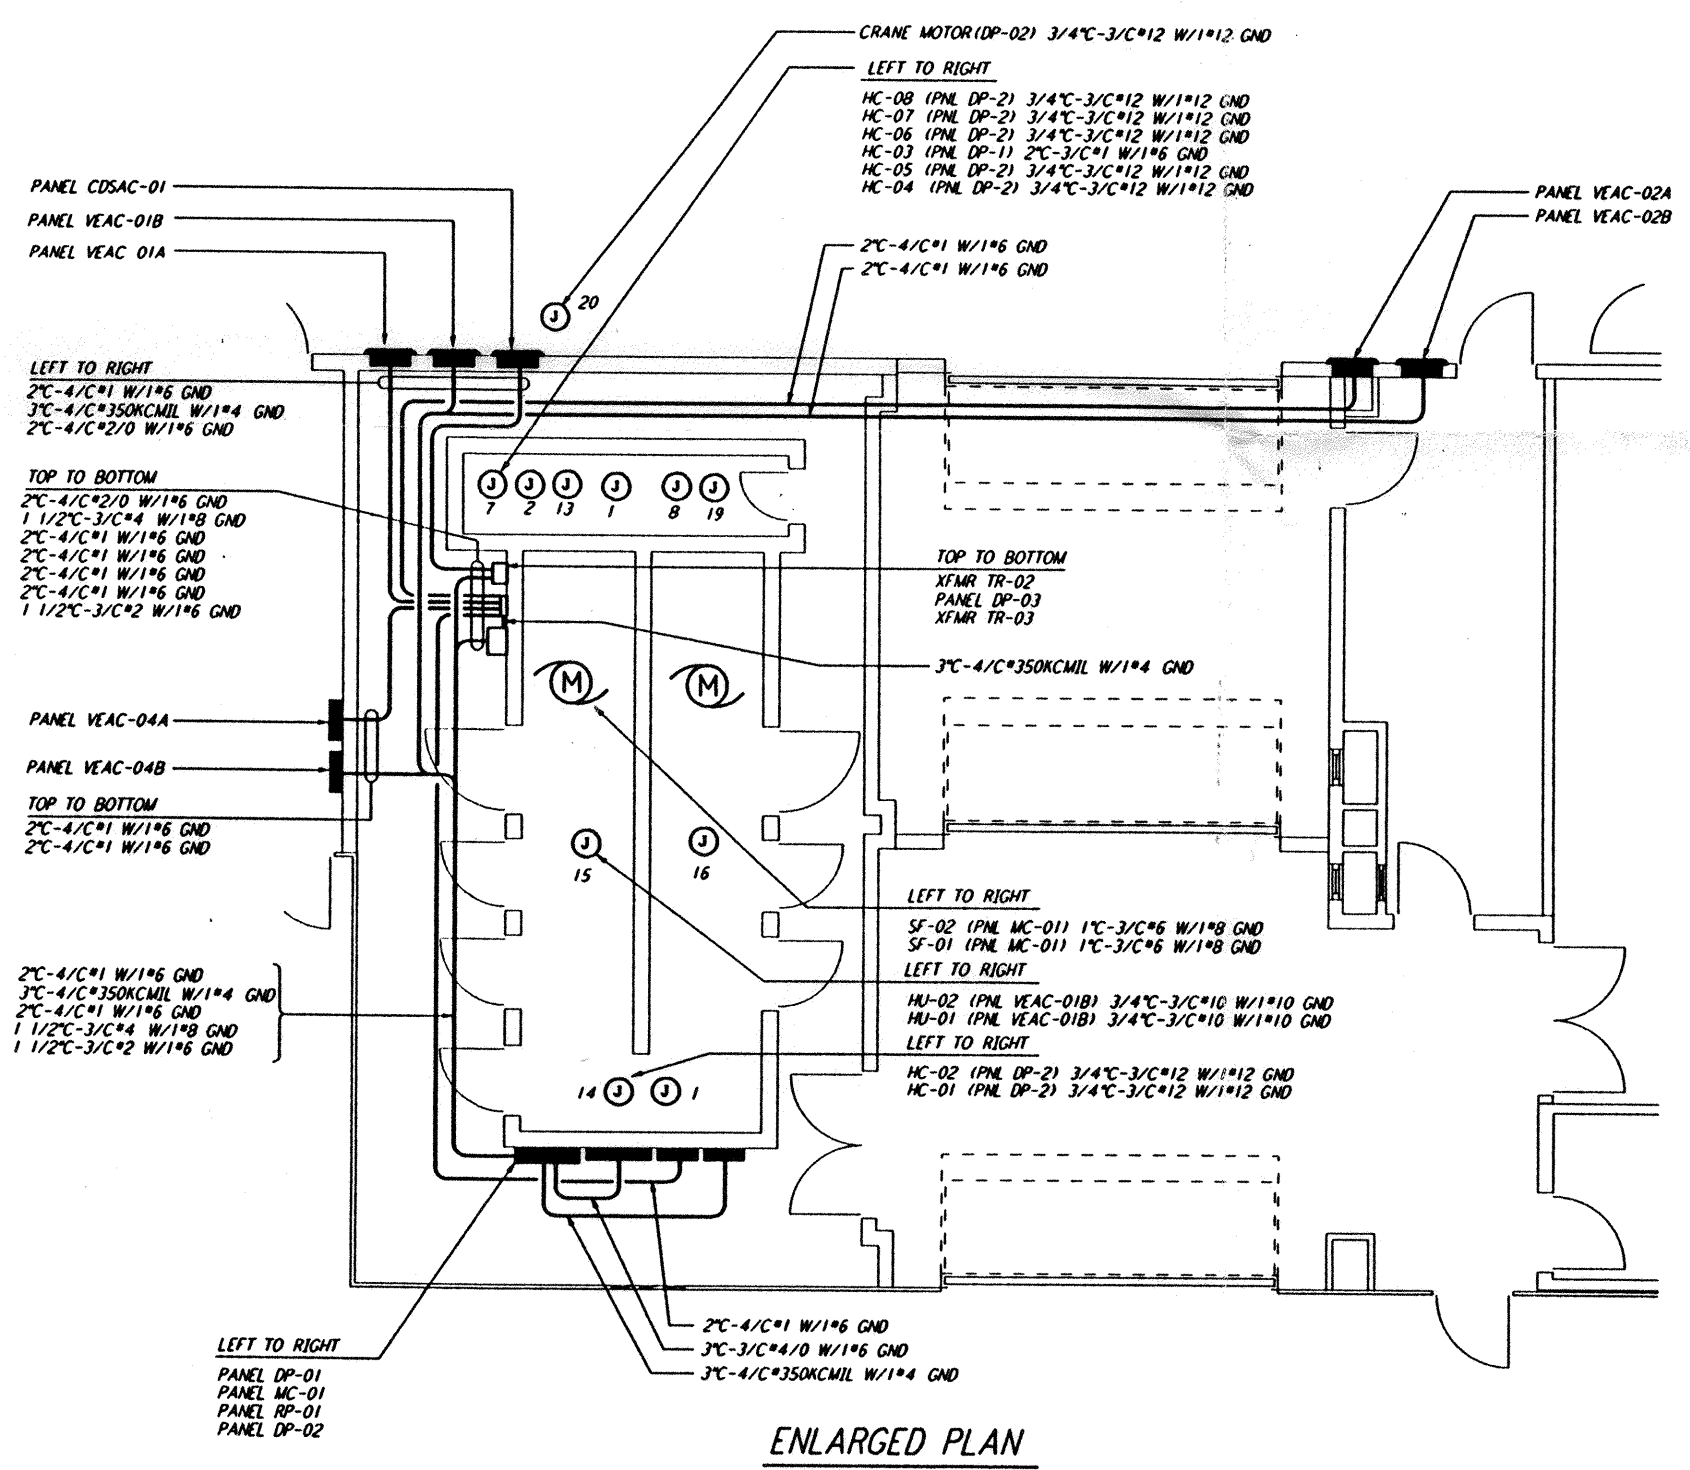


**ENLARGED PLAN**  
 1/4" = 1'-0"

- NOTES:**
- FOR STANDARD SYMBOLS, ABBREVIATIONS AND ACRONYMS SEE DWG. LA-E-001.
  - FOR ELECTRICAL SYMBOLS SEE DWG. LA-E-002.
  - FOR STANDARD INSTALLATION DETAILS SEE DWG. LA-E-404 AND LA-E-409.
  - FOR CABLE TYPE DESCRIPTION SEE DWG. LA-E-007.
  - ALL CONDUIT RUNS ARE SHOWN DIAGRAMMATICALLY ONLY. CONTRACTOR SHALL COORDINATE INSTALLATION WITH OTHER DISCIPLINES.
  - FOR SINGLE LINE DIAGRAM, SEE DWG. LA-E-008.
  - FOR EQUIPMENT LOCATION, SEE HVAC DWG. LA-H-211.
  - ALL CIRCUITS SHOWN ON THIS DRAWING ARE FROM PANEL RPO1 UNLESS OTHERWISE NOTED.
  - CIRCUIT SHOWN FEEDING THESE ITEMS ARE FROM DP-02.
  - PANEL SCHEDULES ARE SHOWN ON DRAWINGS LA-E-205 AND LA-E-206.

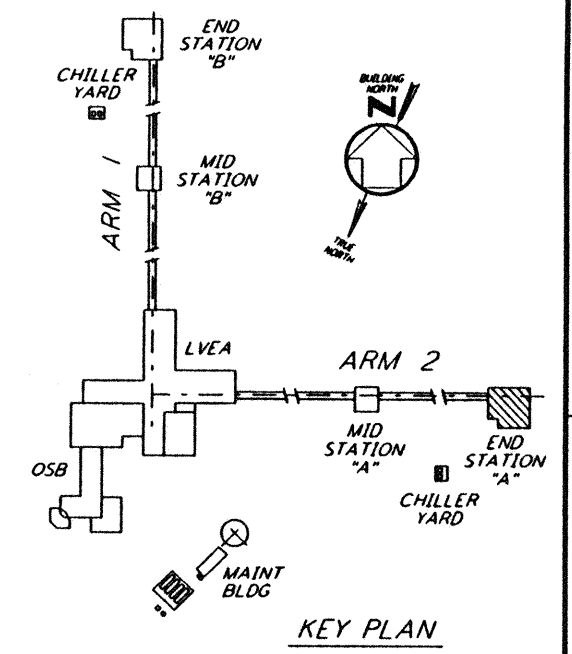

**KEY PLAN**

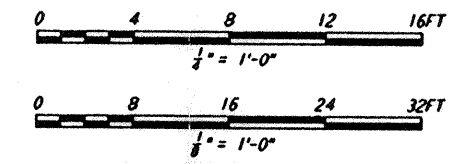

not be reproduced, copied, loaned, exhibited, or used in any other way, except by written consent from PARSONS to the borrower.

This document and the design it covers are the property of PARSONS. They are loaned only with the borrower's expressed written agreement that they will

LA-E-203	END STATION A UNDERGROUND PLAN								
REVISIONS		NO.	DATE	BY	CHKD	ENGR	PROJ	DESCRIPTION	
B	7-24-96	MM	JCL	TDM				ISSUED FOR BID	
A	6-14-96	MM	JCL	KR	TDM			FINAL DESIGN REVIEW	
DRAWING NO.		DESCRIPTION							

DRAWN	M. M.
CHECKED	
ENGINEER	
PROJ	

**PARSONS**  
 100 WEST WALNUT STREET  
 PASADENA, CALIFORNIA

**LIGO**  
 CALIFORNIA INSTITUTE OF TECHNOLOGY  
 MASSACHUSETTS INSTITUTE OF TECHNOLOGY

LASER INTERFEROMETER  
 GRAVITATIONAL-WAVE OBSERVATORY  
 SITE NO. 2 - LIVINGSTON, LOUISIANA

TITLE: ELECTRICAL  
 END STATION A  
 ABOVEGROUND POWER PLAN

AS NOTED PP150969 8094

**LA-E-204**

LIGO-D961028-B-0

Tue Jul 23 18:57:55 1996 S3-V18B2 J:\PLOTS\QUEUES\18B2\EE204.PRF