




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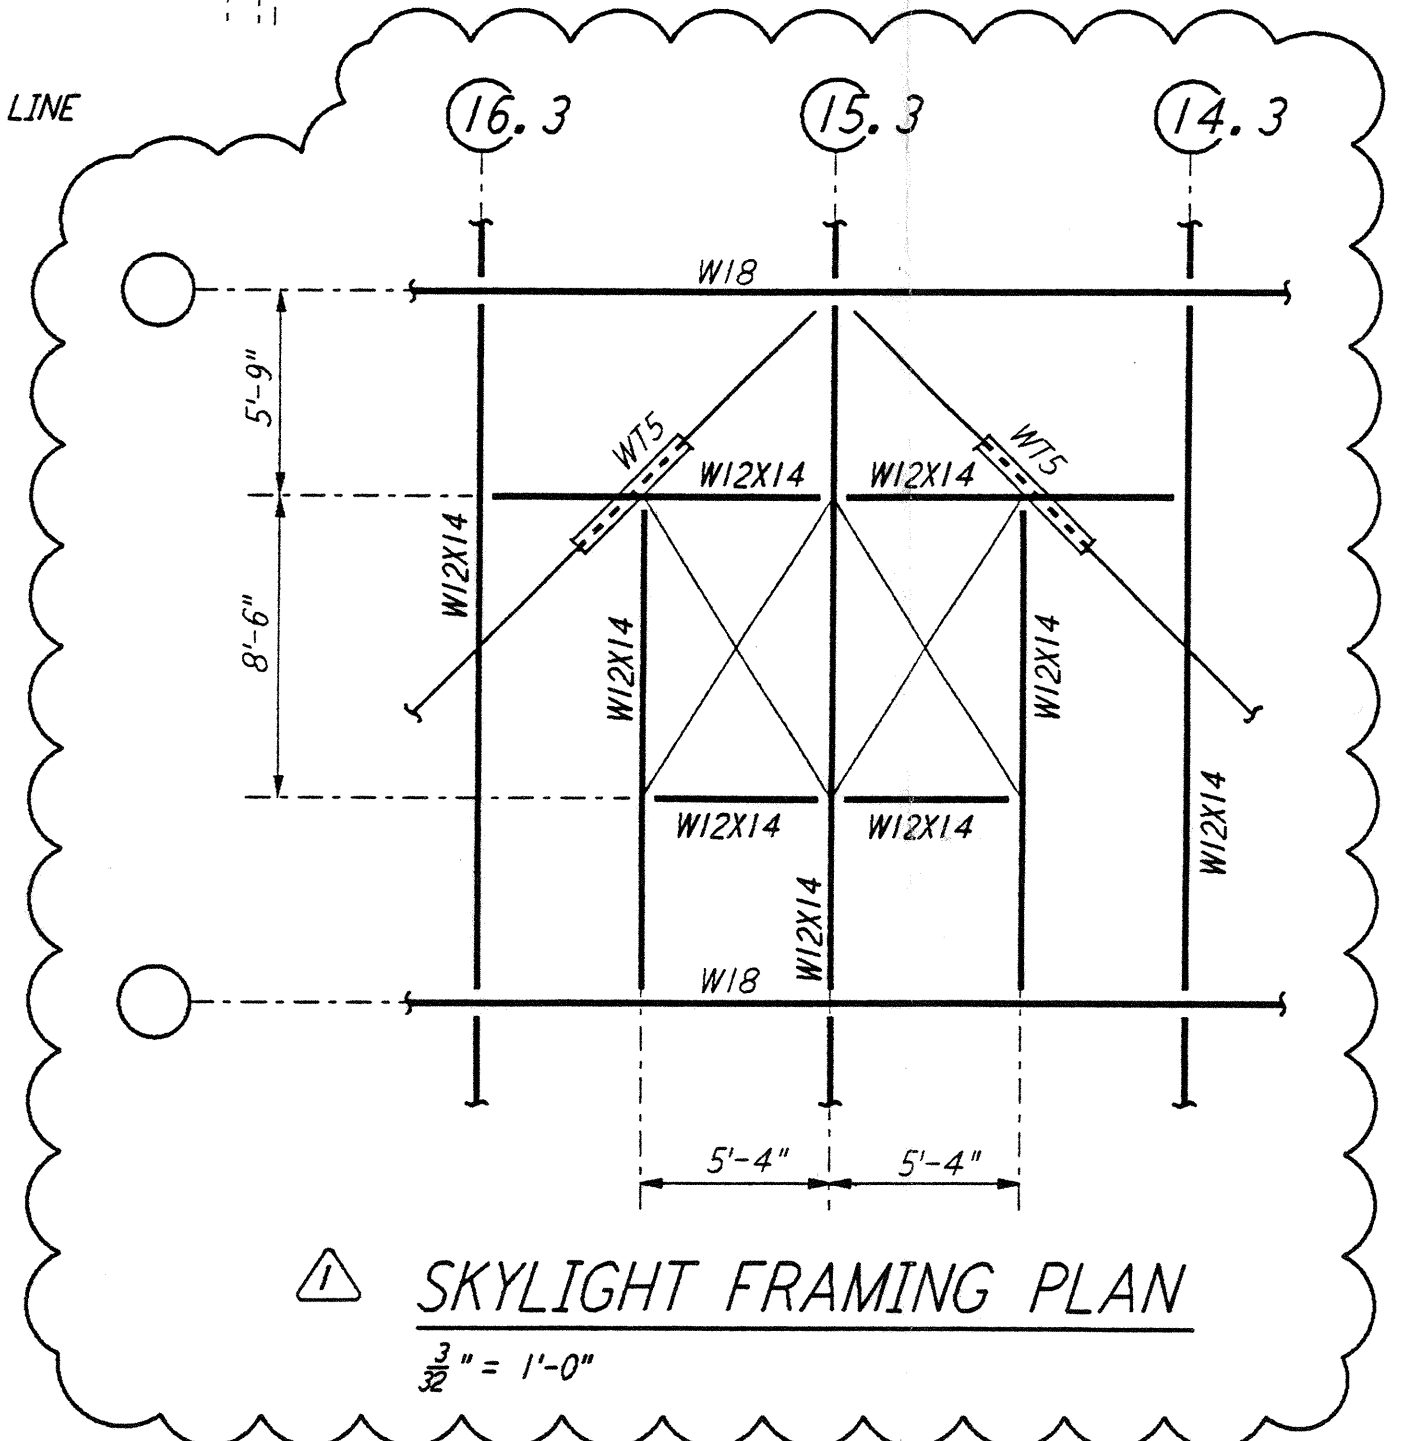
LOW ROOF FRAMING PLAN
 1/8" = 1'-0"

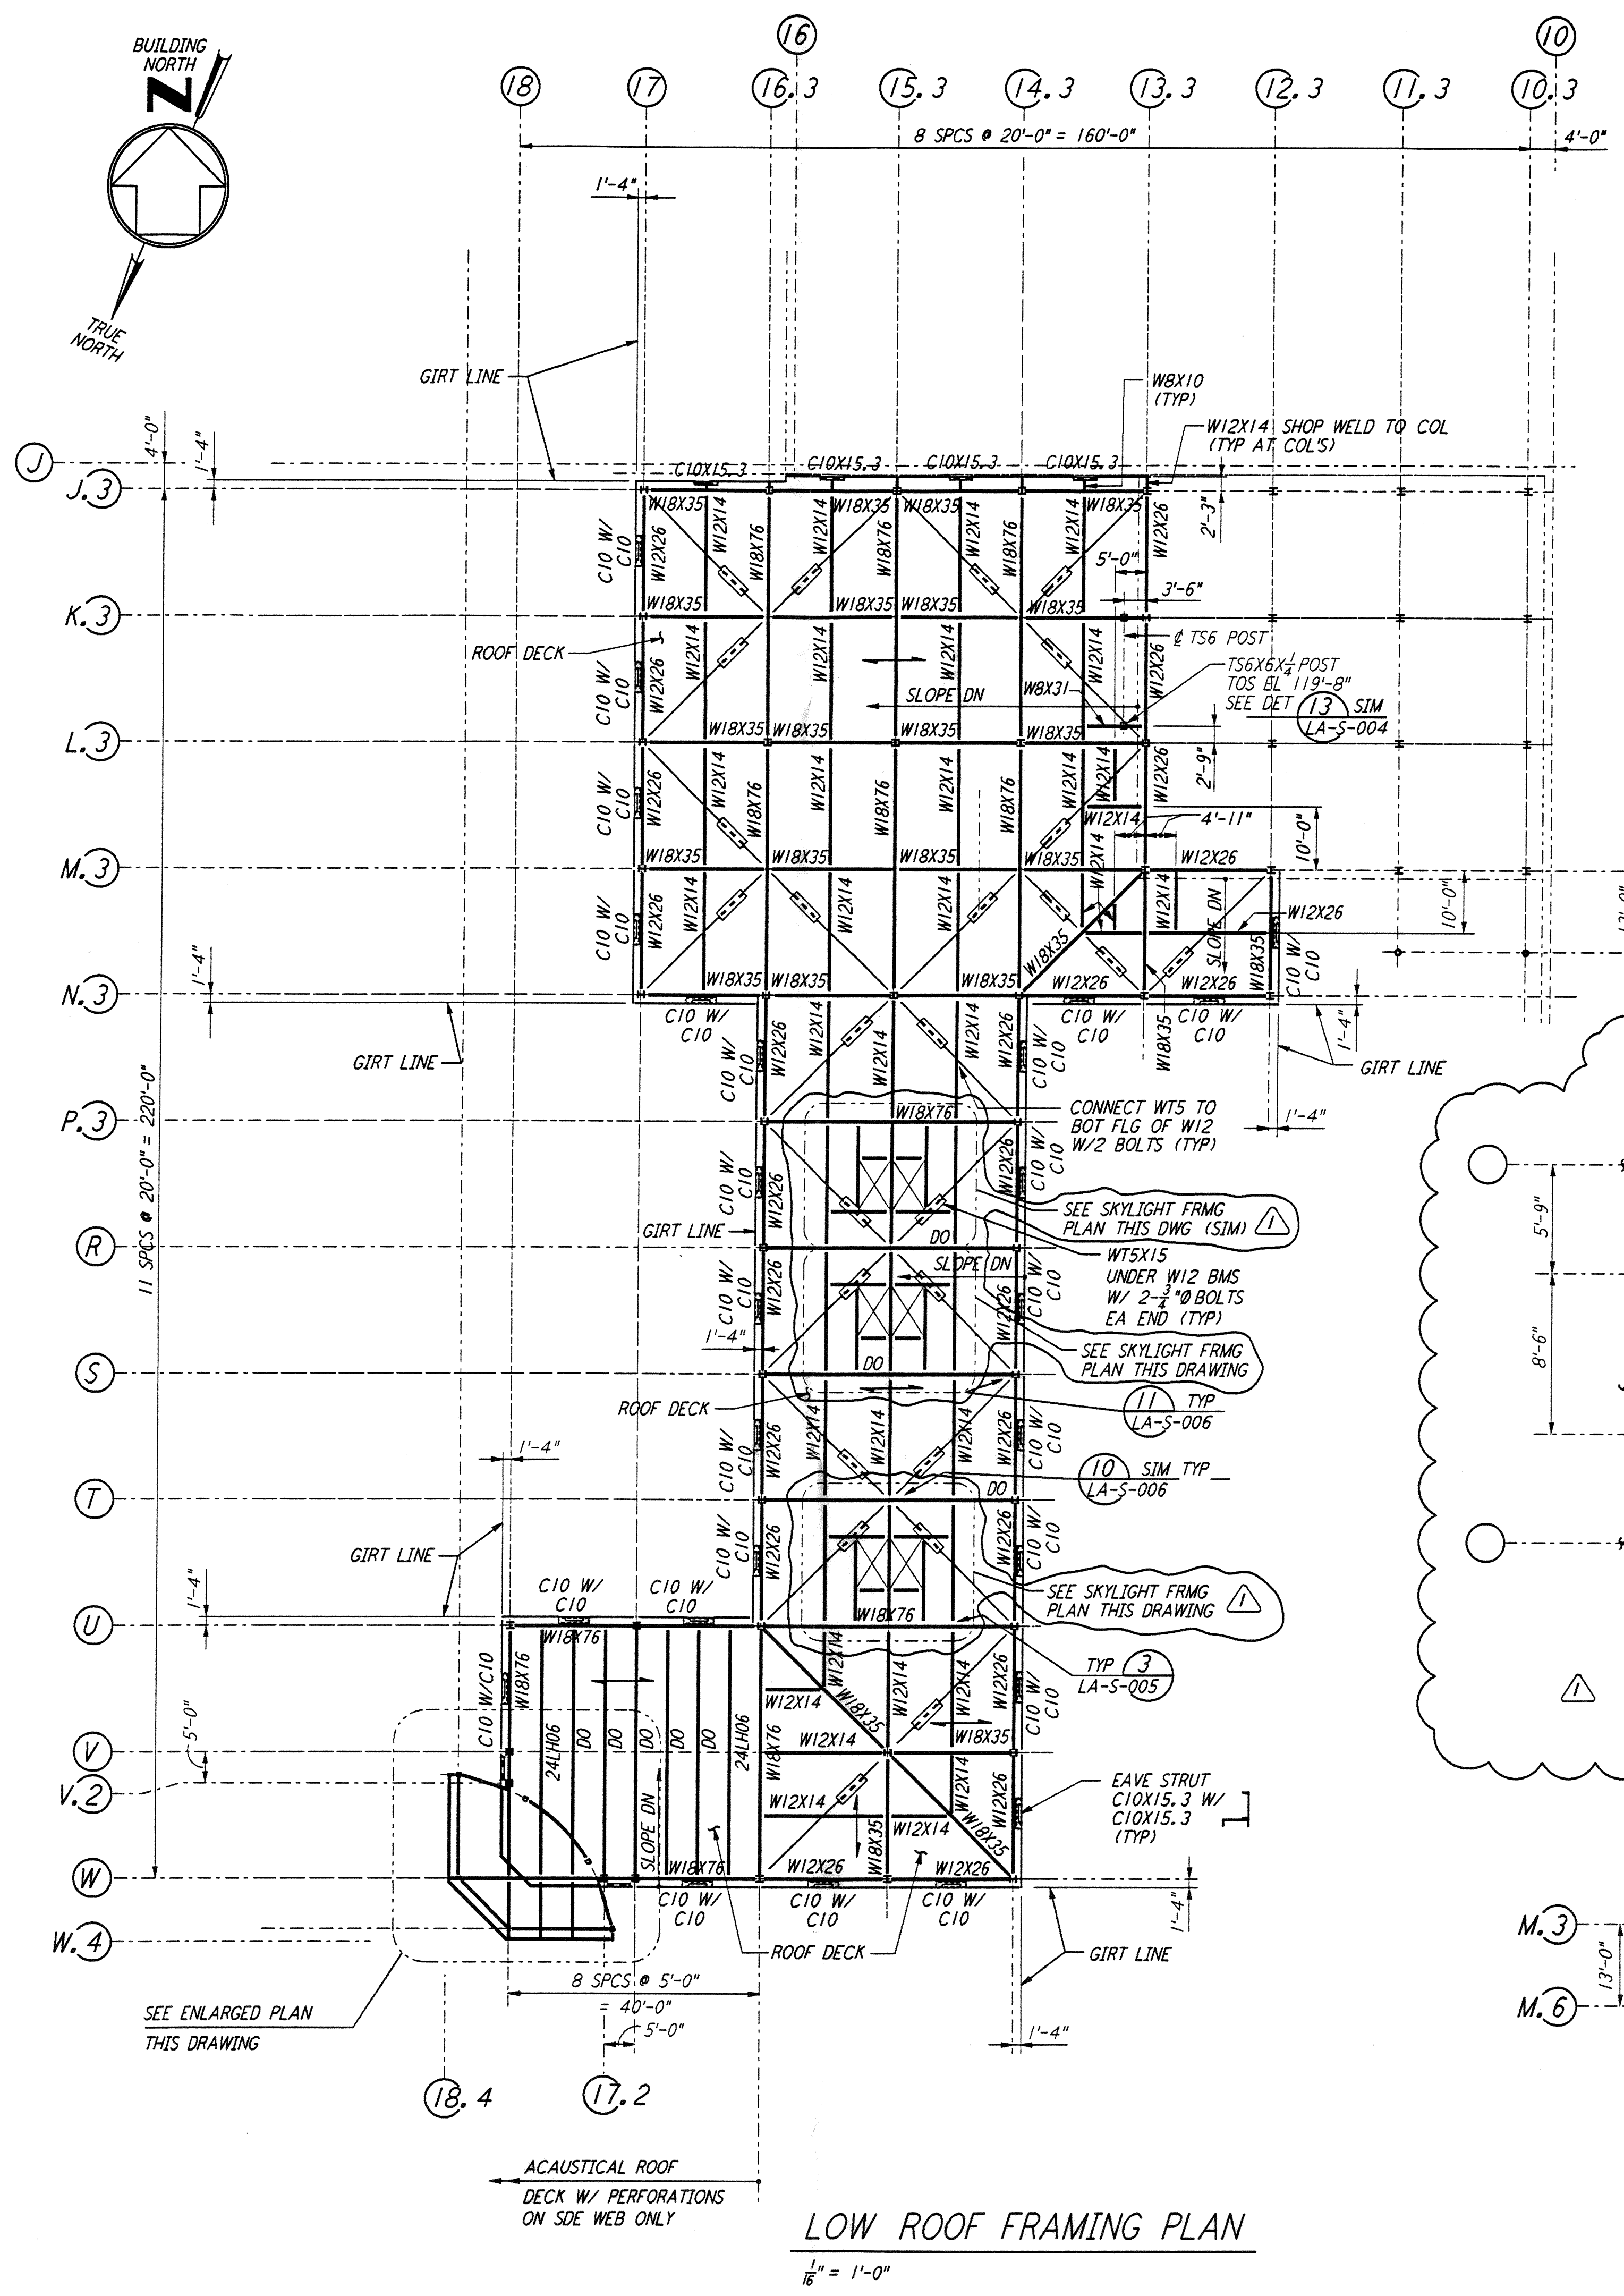


HIGH ROOF FRAMING PLAN
 1/8" = 1'-0"

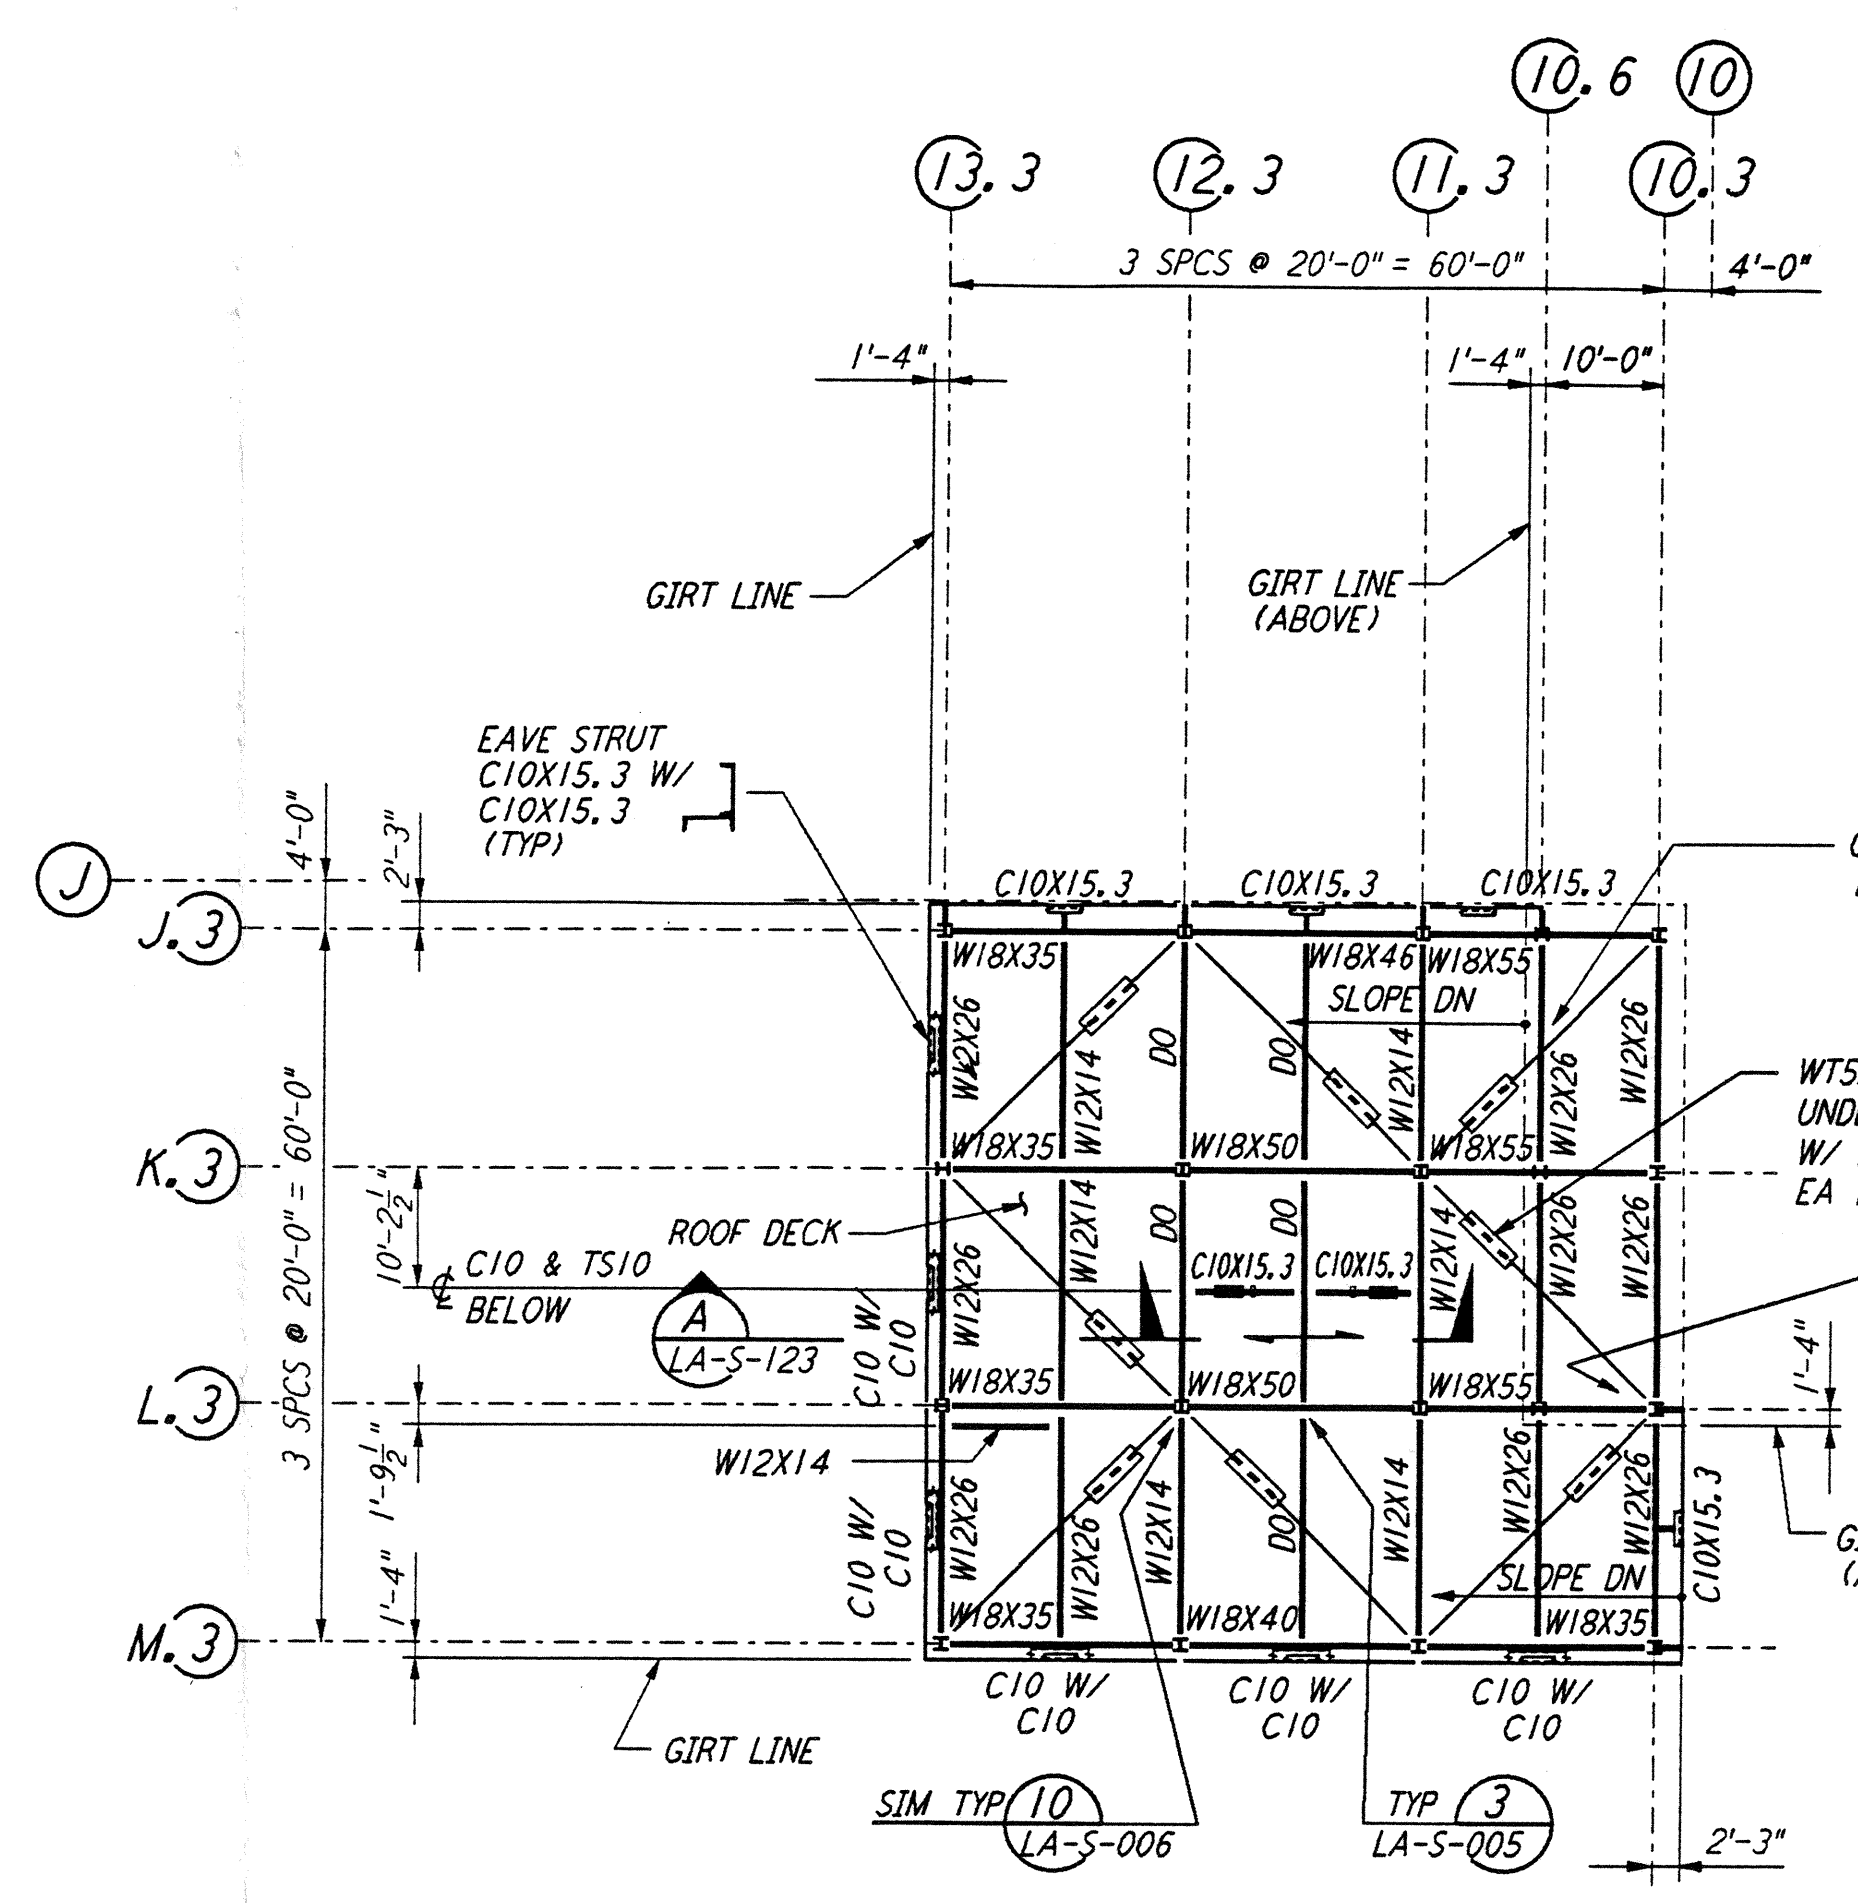


DUCT ENCLOSURE ROOF PLAN
 1/8" = 1'-0"

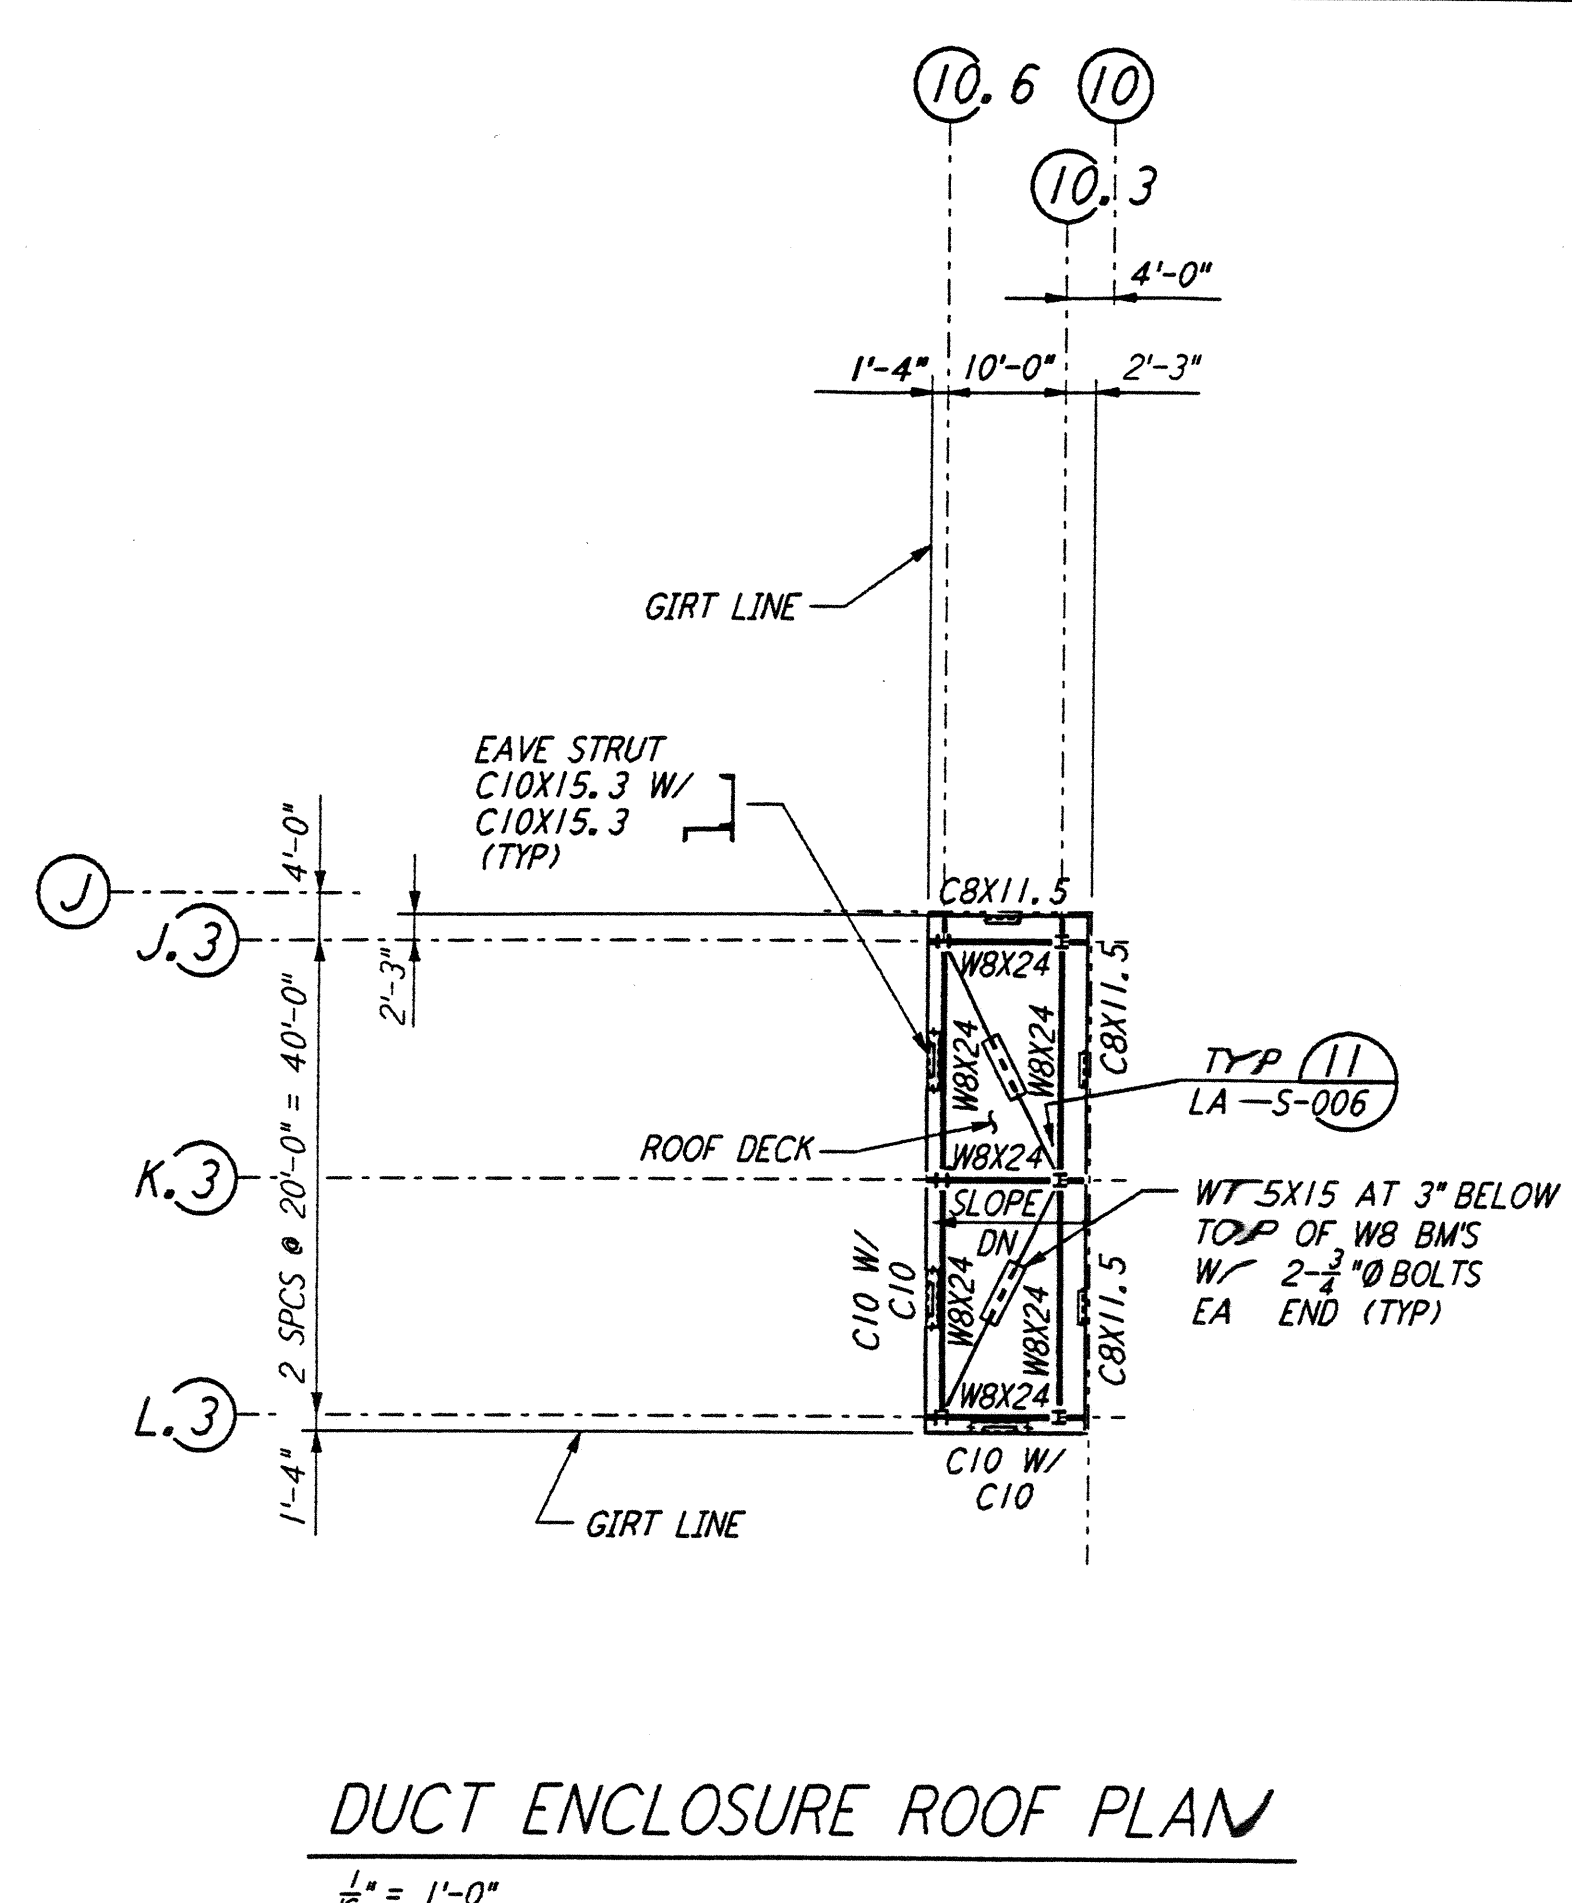

SKYLIGHT FRAMING PLAN
 1/8" = 1'-0"


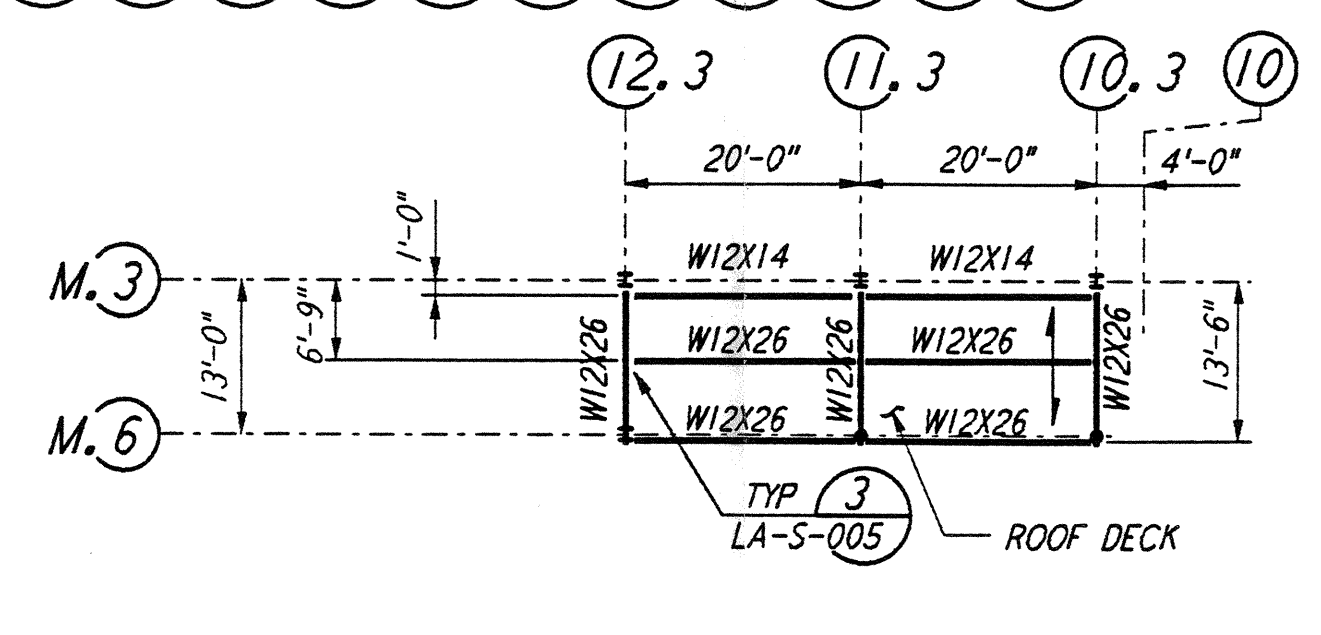


CANOPY FRAMING PLAN
 1/8" = 1'-0"

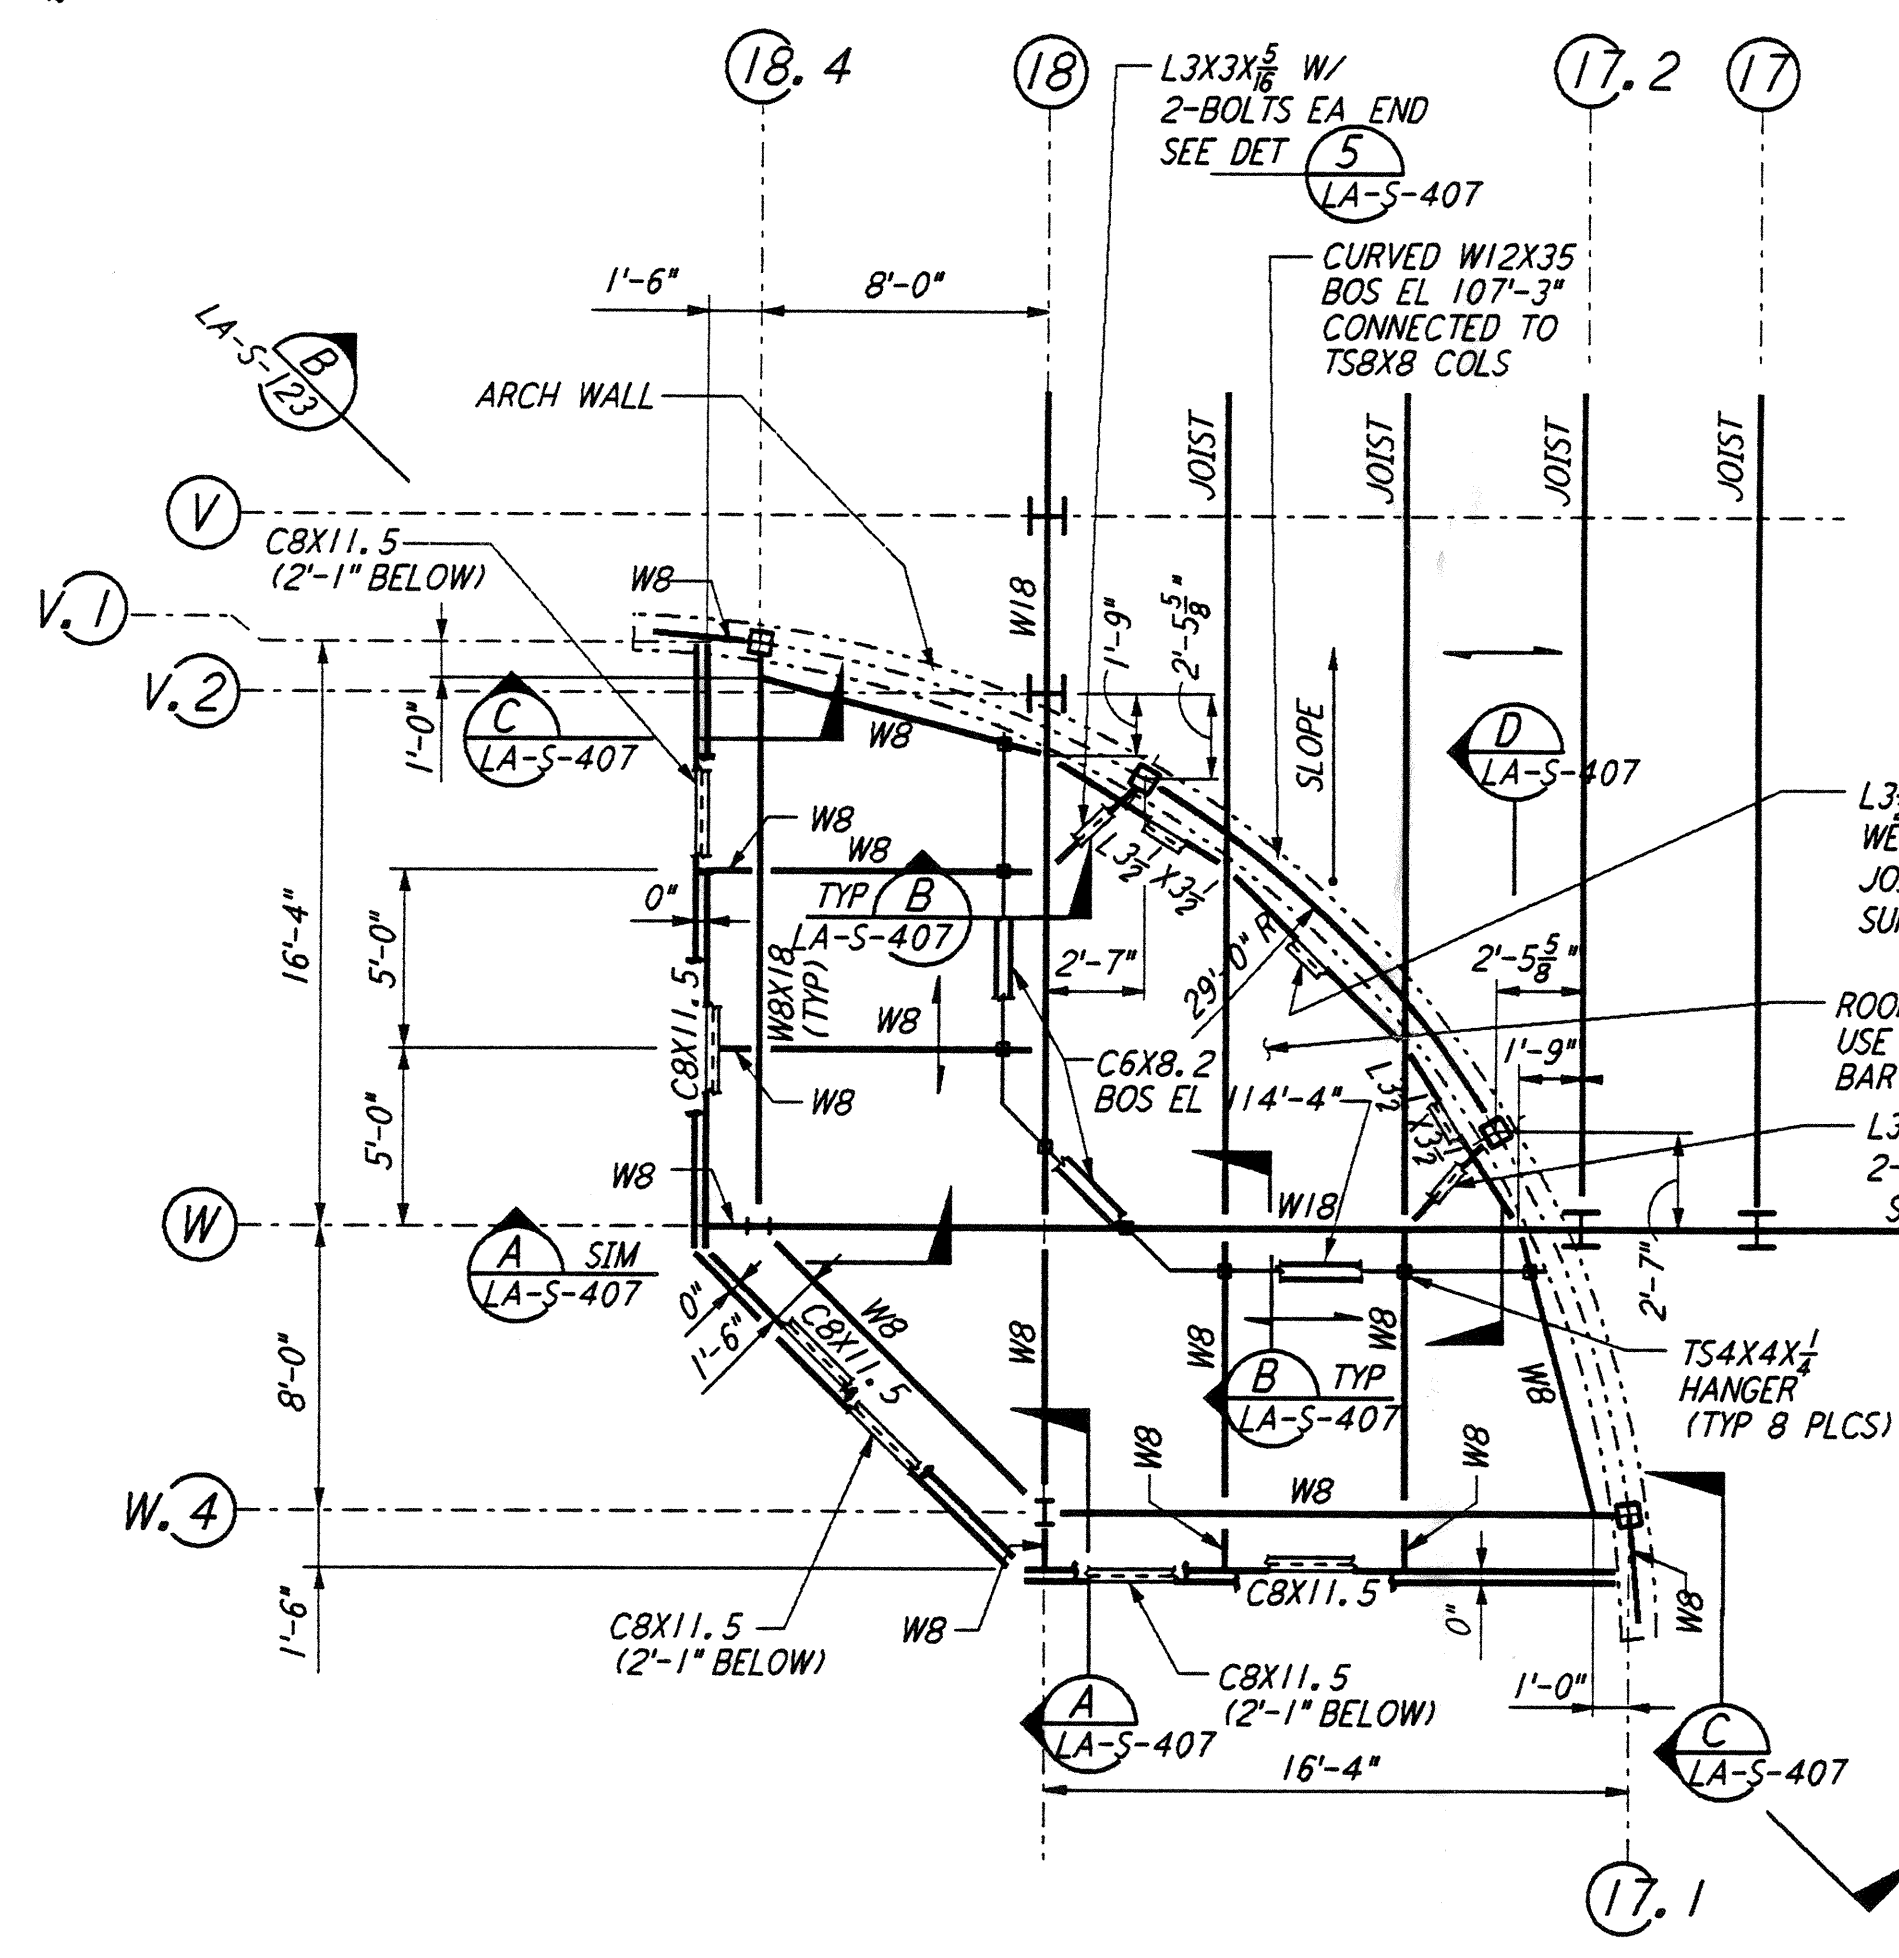

ENLARGED FRAMING PLAN
 3/8" = 1'-0"

NOTE:
 1. FOR STRUCTURAL GENERAL NOTES, ABBREVIATIONS AND LEGEND, SEE DWG LA-S-001.

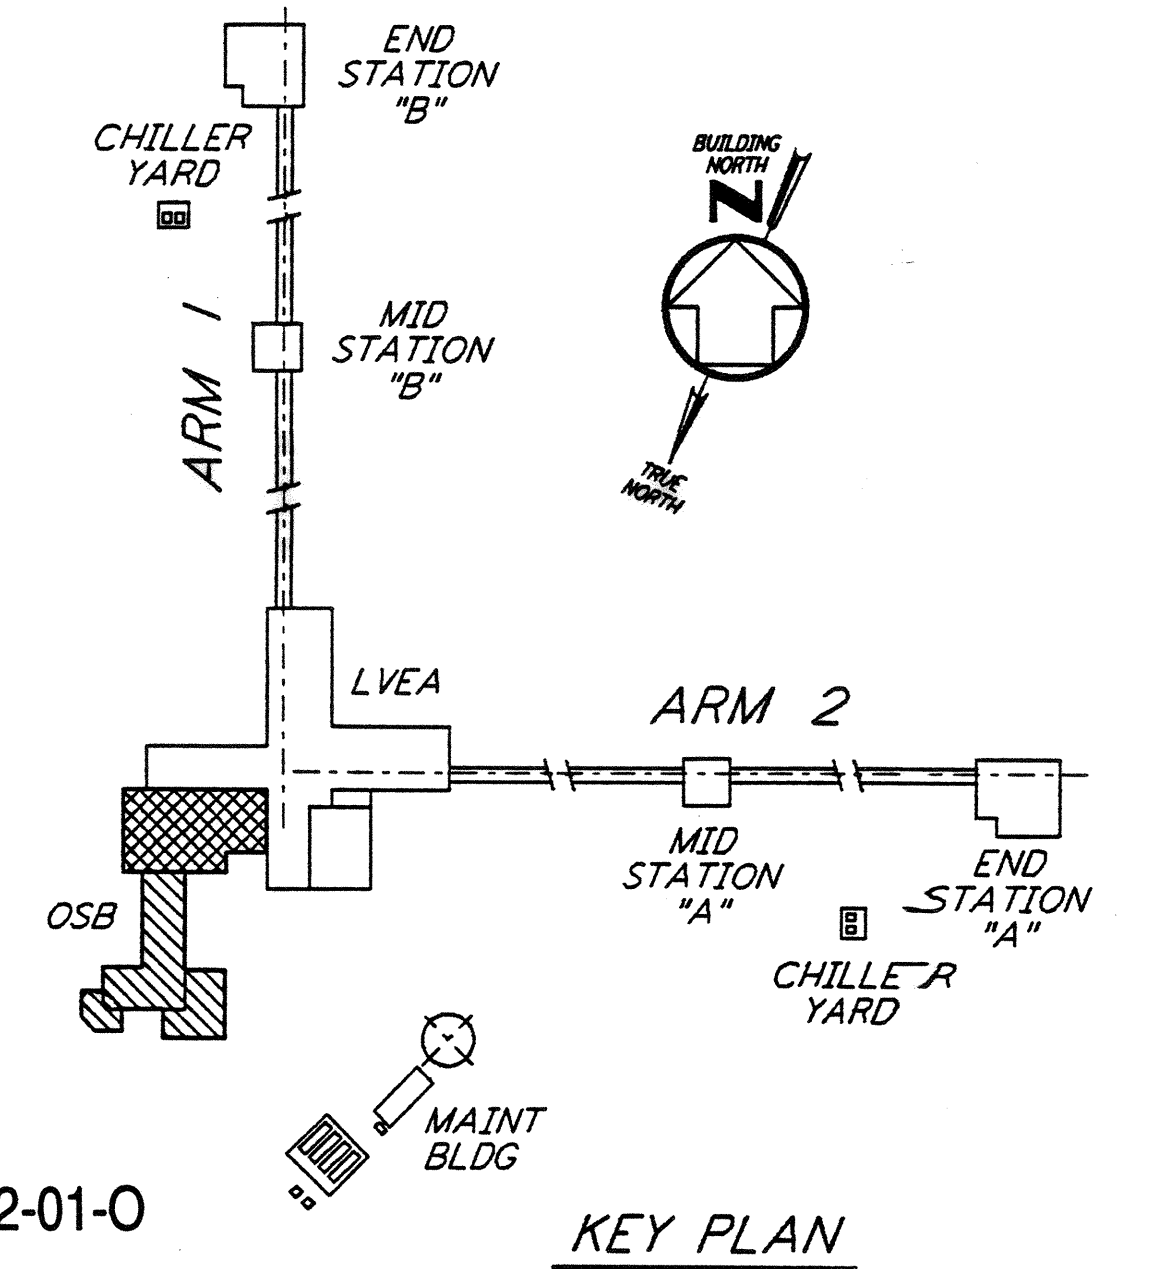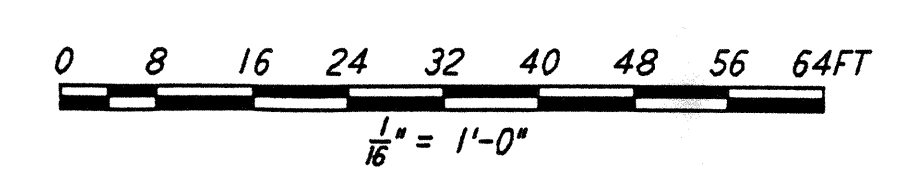


KEY PLAN

LIGO-D960932-01-0

NO.	DATE	BY	CHKD	ENGR	PROJ	DESCRIPTION
1	2-28-97	RM	A.B	HA		ADDED SKYLIGHT FRMG

NO.	DATE	BY	CHKD	ENGR	PROJ	DESCRIPTION
1	2-28-97	RM	A.B	HA		ADDED SKYLIGHT FRMG

ISSUED FOR CONSTRUCTION	DRAWN	CHECKED	ENGINEER	PROJ
MCS	DDM	BP	TDM	

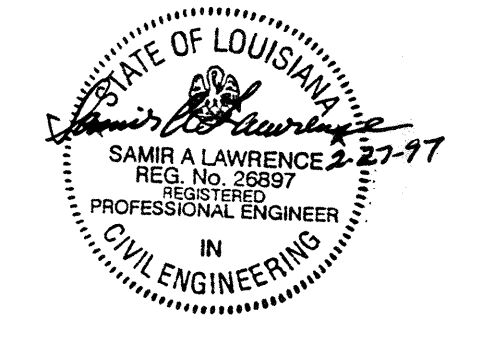

100 WEST WALNUT STREET
 PASADENA, CALIFORNIA



CALIFORNIA INSTITUTE OF TECHNOLOGY
 MASSACHUSETTS INSTITUTE OF TECHNOLOGY

LASER INTERFEROMETER
 GRAVITATIONAL-WAVE OBSERVATORY
 SITE NO. 2 - LIVINGSTON, LOUISIANA

STRUCTURAL CORNER STATION OSB ROOF FRAMING PLANS

SCALE: AS NOTED
 CONTRACT NO: PPI50969
 PROJECT NUMBER: 8094

LA-S-116