




**AIR HANDLING UNIT STRUCTURE  
 FOUNDATION PLAN**  
 $\frac{1}{8}'' = 1'-0''$

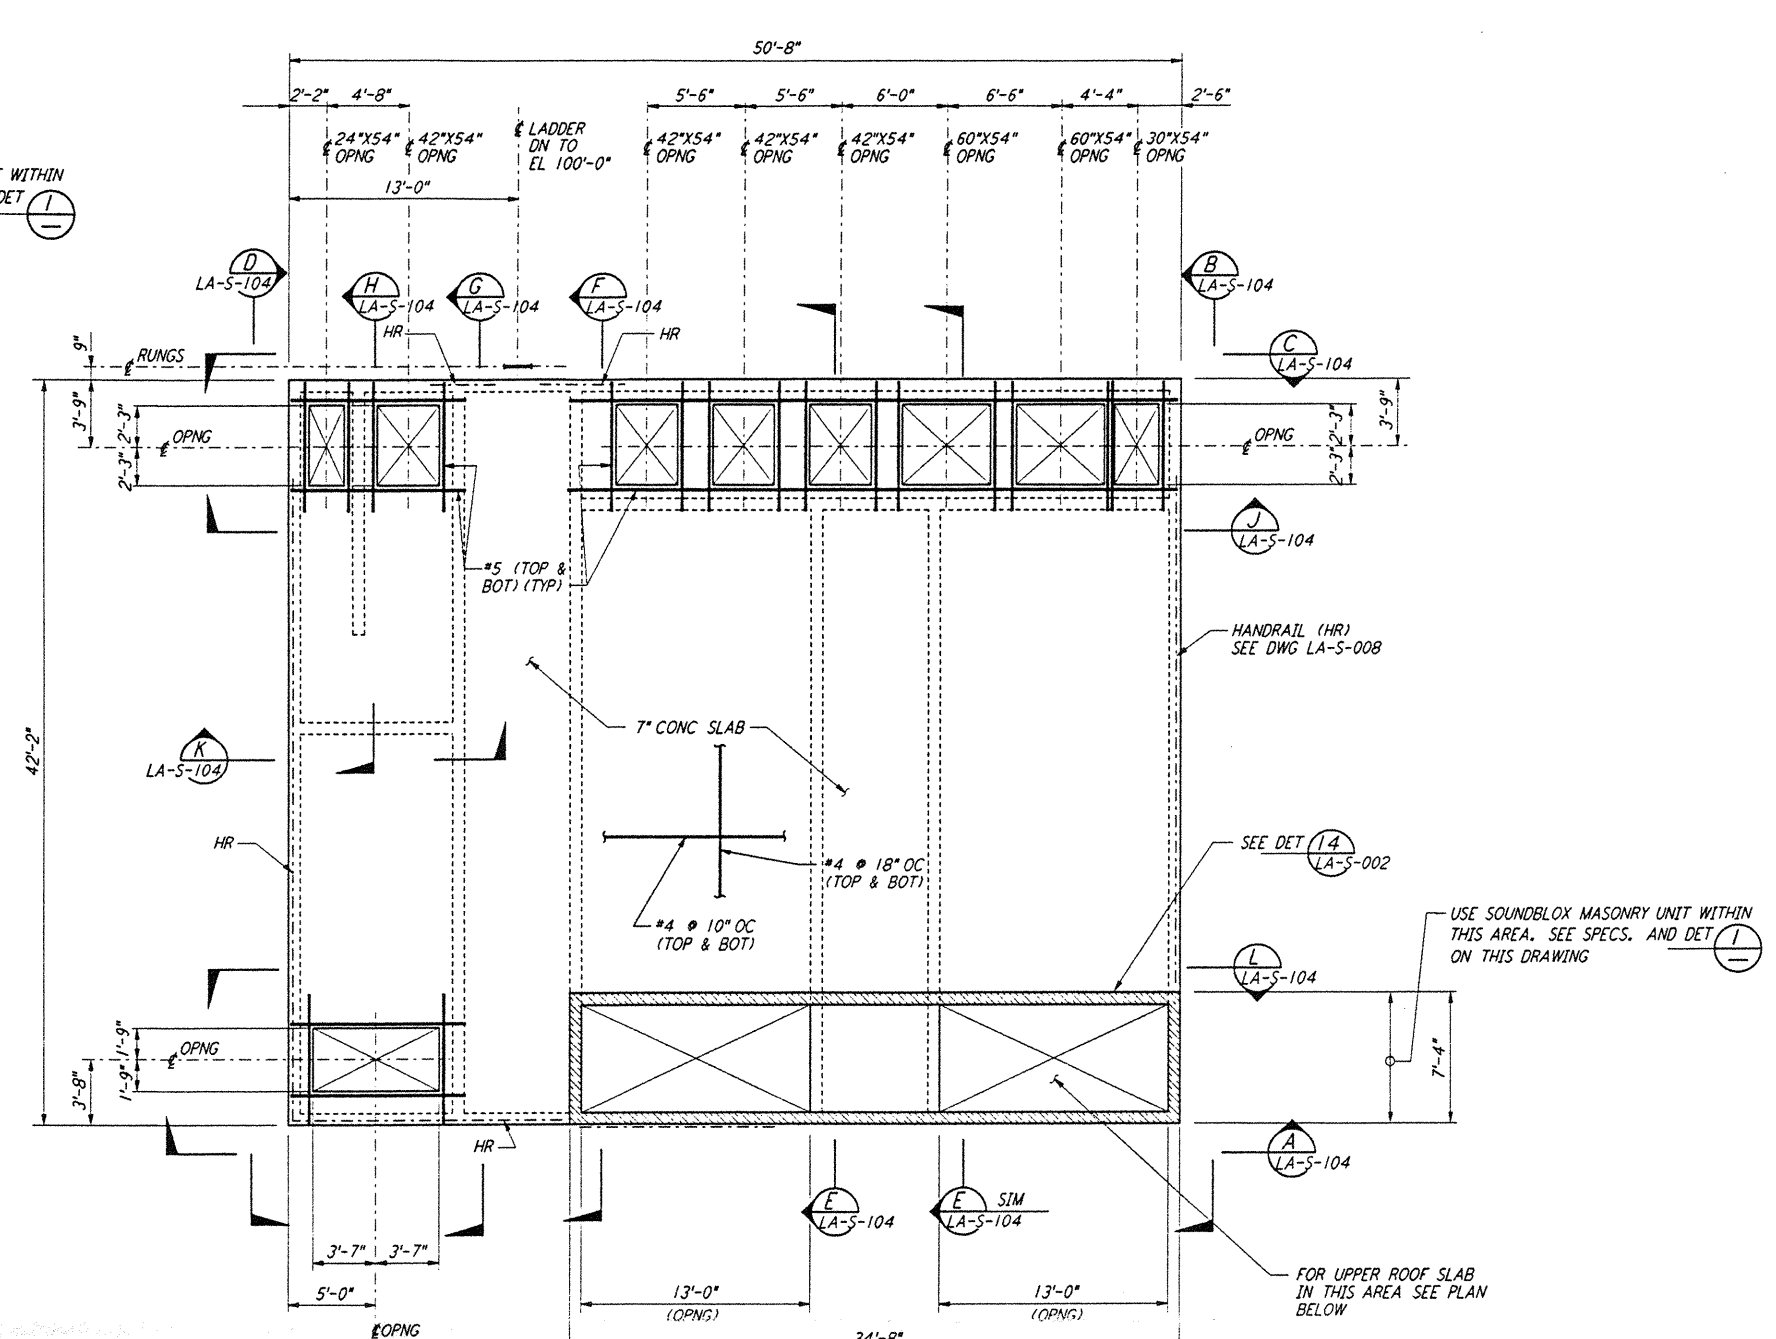

**AIR HANDLING UNIT STRUCTURE  
 LOWER CONCRETE ROOF SLAB PLAN**  
 $\frac{1}{8}'' = 1'-0''$  TOC EL 110'-7"

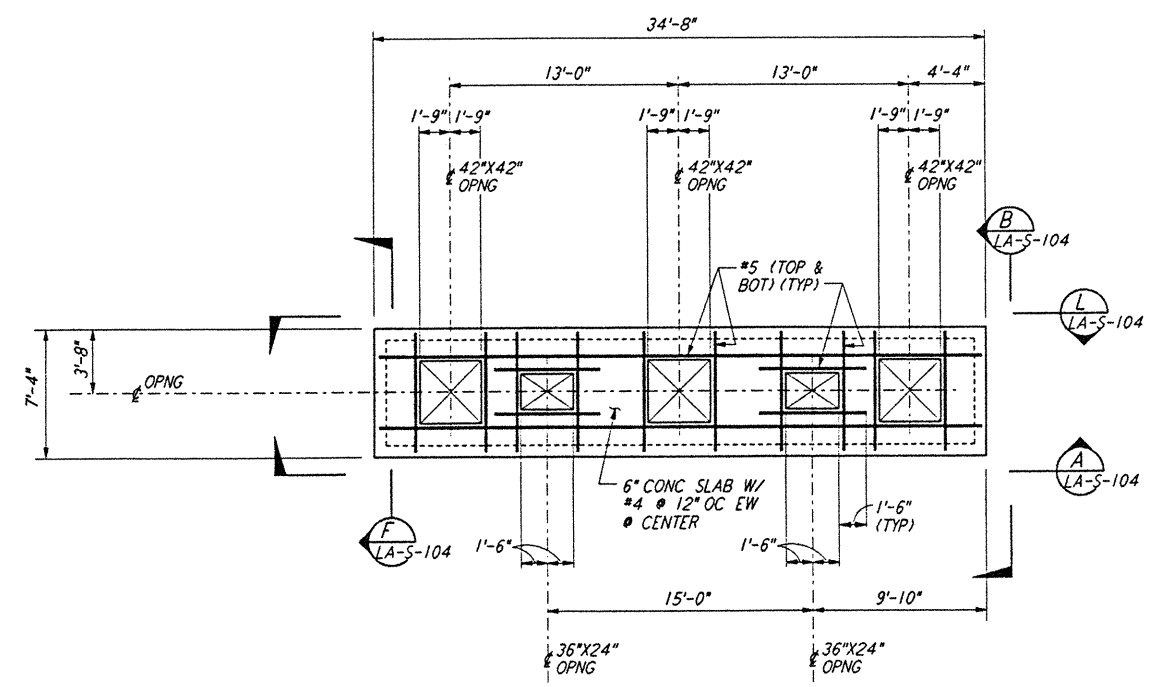


**AIR HANDLING UNIT STRUCTURE  
 UPPER CONCRETE ROOF SLAB PLAN**  
 $\frac{1}{8}'' = 1'-0''$  TOC EL 115'-2"

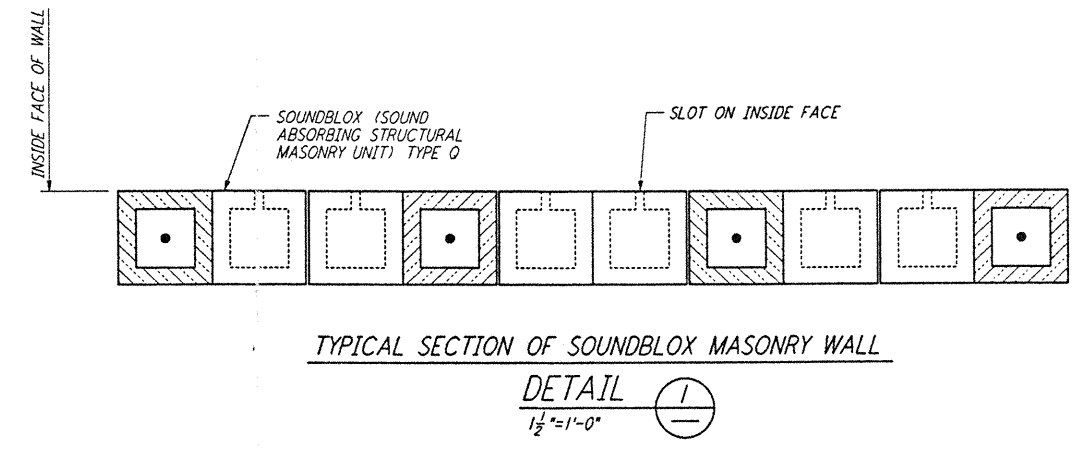

**TYPICAL SECTION OF SOUNDBLOX MASONRY WALL  
 DETAIL**  
 $\frac{1}{2}'' = 1'-0''$

- NOTES:**
- FOR GENERAL NOTES, ABBREVIATIONS & SYMBOLS SEE DRAWING LA-S-001.
  - CONTRACTOR SHALL ADJUST LOCATION AND SIZE OF ALL EQUIPMENT PADS TO SUIT ACTUAL VENDOR EQUIPMENTS.

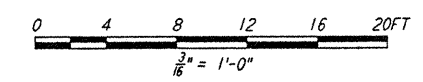


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NO.	DATE	BY	CHKD	ENGR	PROJ	DESCRIPTION

ISSUED FOR CONSTRUCTION	MCS	11-15-96
DRAWN		
CHECKED		
ENGINEER		
PROJ		



**PARSONS**  
 100 WEST WALNUT STREET  
 PASADENA, CALIFORNIA

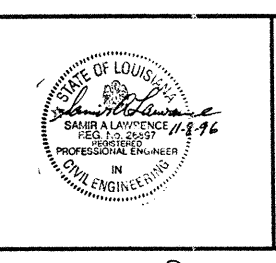**LIGO**  
 CALIFORNIA INSTITUTE OF TECHNOLOGY  
 MASSACHUSETTS INSTITUTE OF TECHNOLOGY

LASER INTERFEROMETER  
 GRAVITATIONAL-WAVE OBSERVATORY  
 SITE NO. 2 - LIVINGSTON, LOUISIANA

TITLE: STRUCTURAL CORNER STATION AIR HANDLING UNIT ENCLOSURE PLAN  
 SHEET NUMBER: LA-S-103

SCALE: AS NOTED  
 CONTRACT NUMBER: PPI50969  
 PROJECT NUMBER: 8094