



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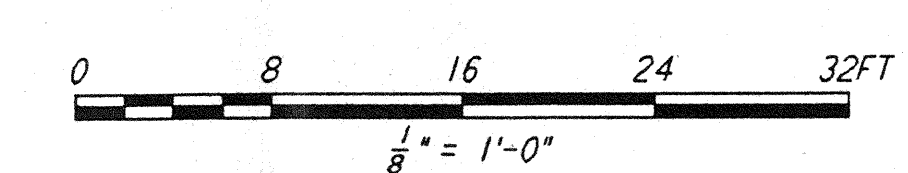
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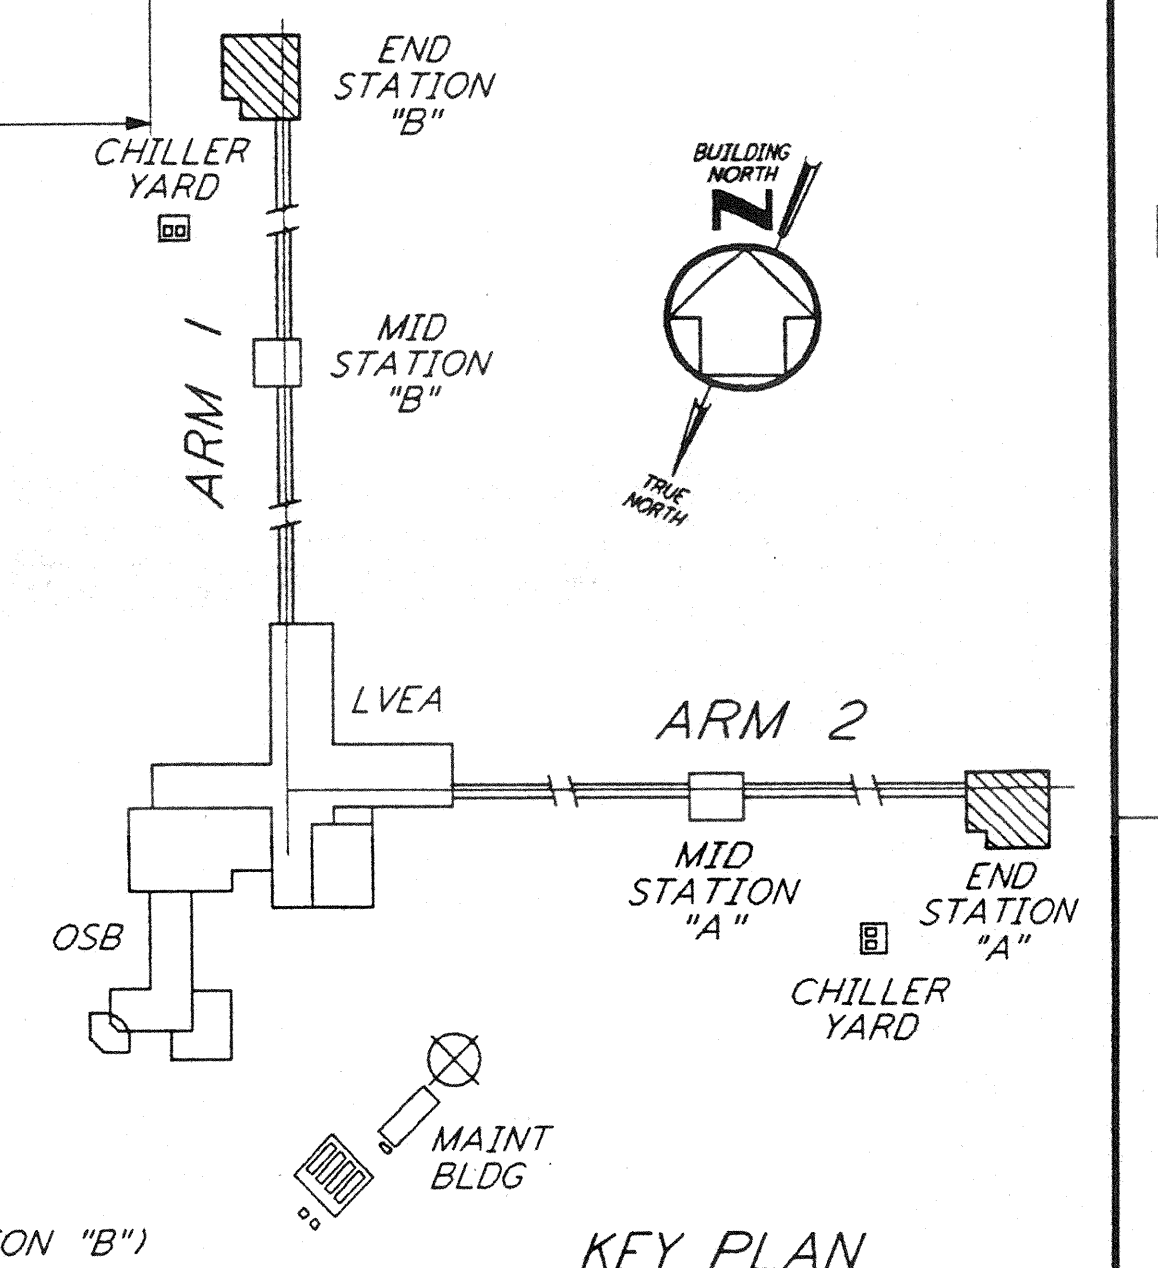
END STATIONS ROOF PLAN
 1/8" = 1'-0" (LA-A-221)

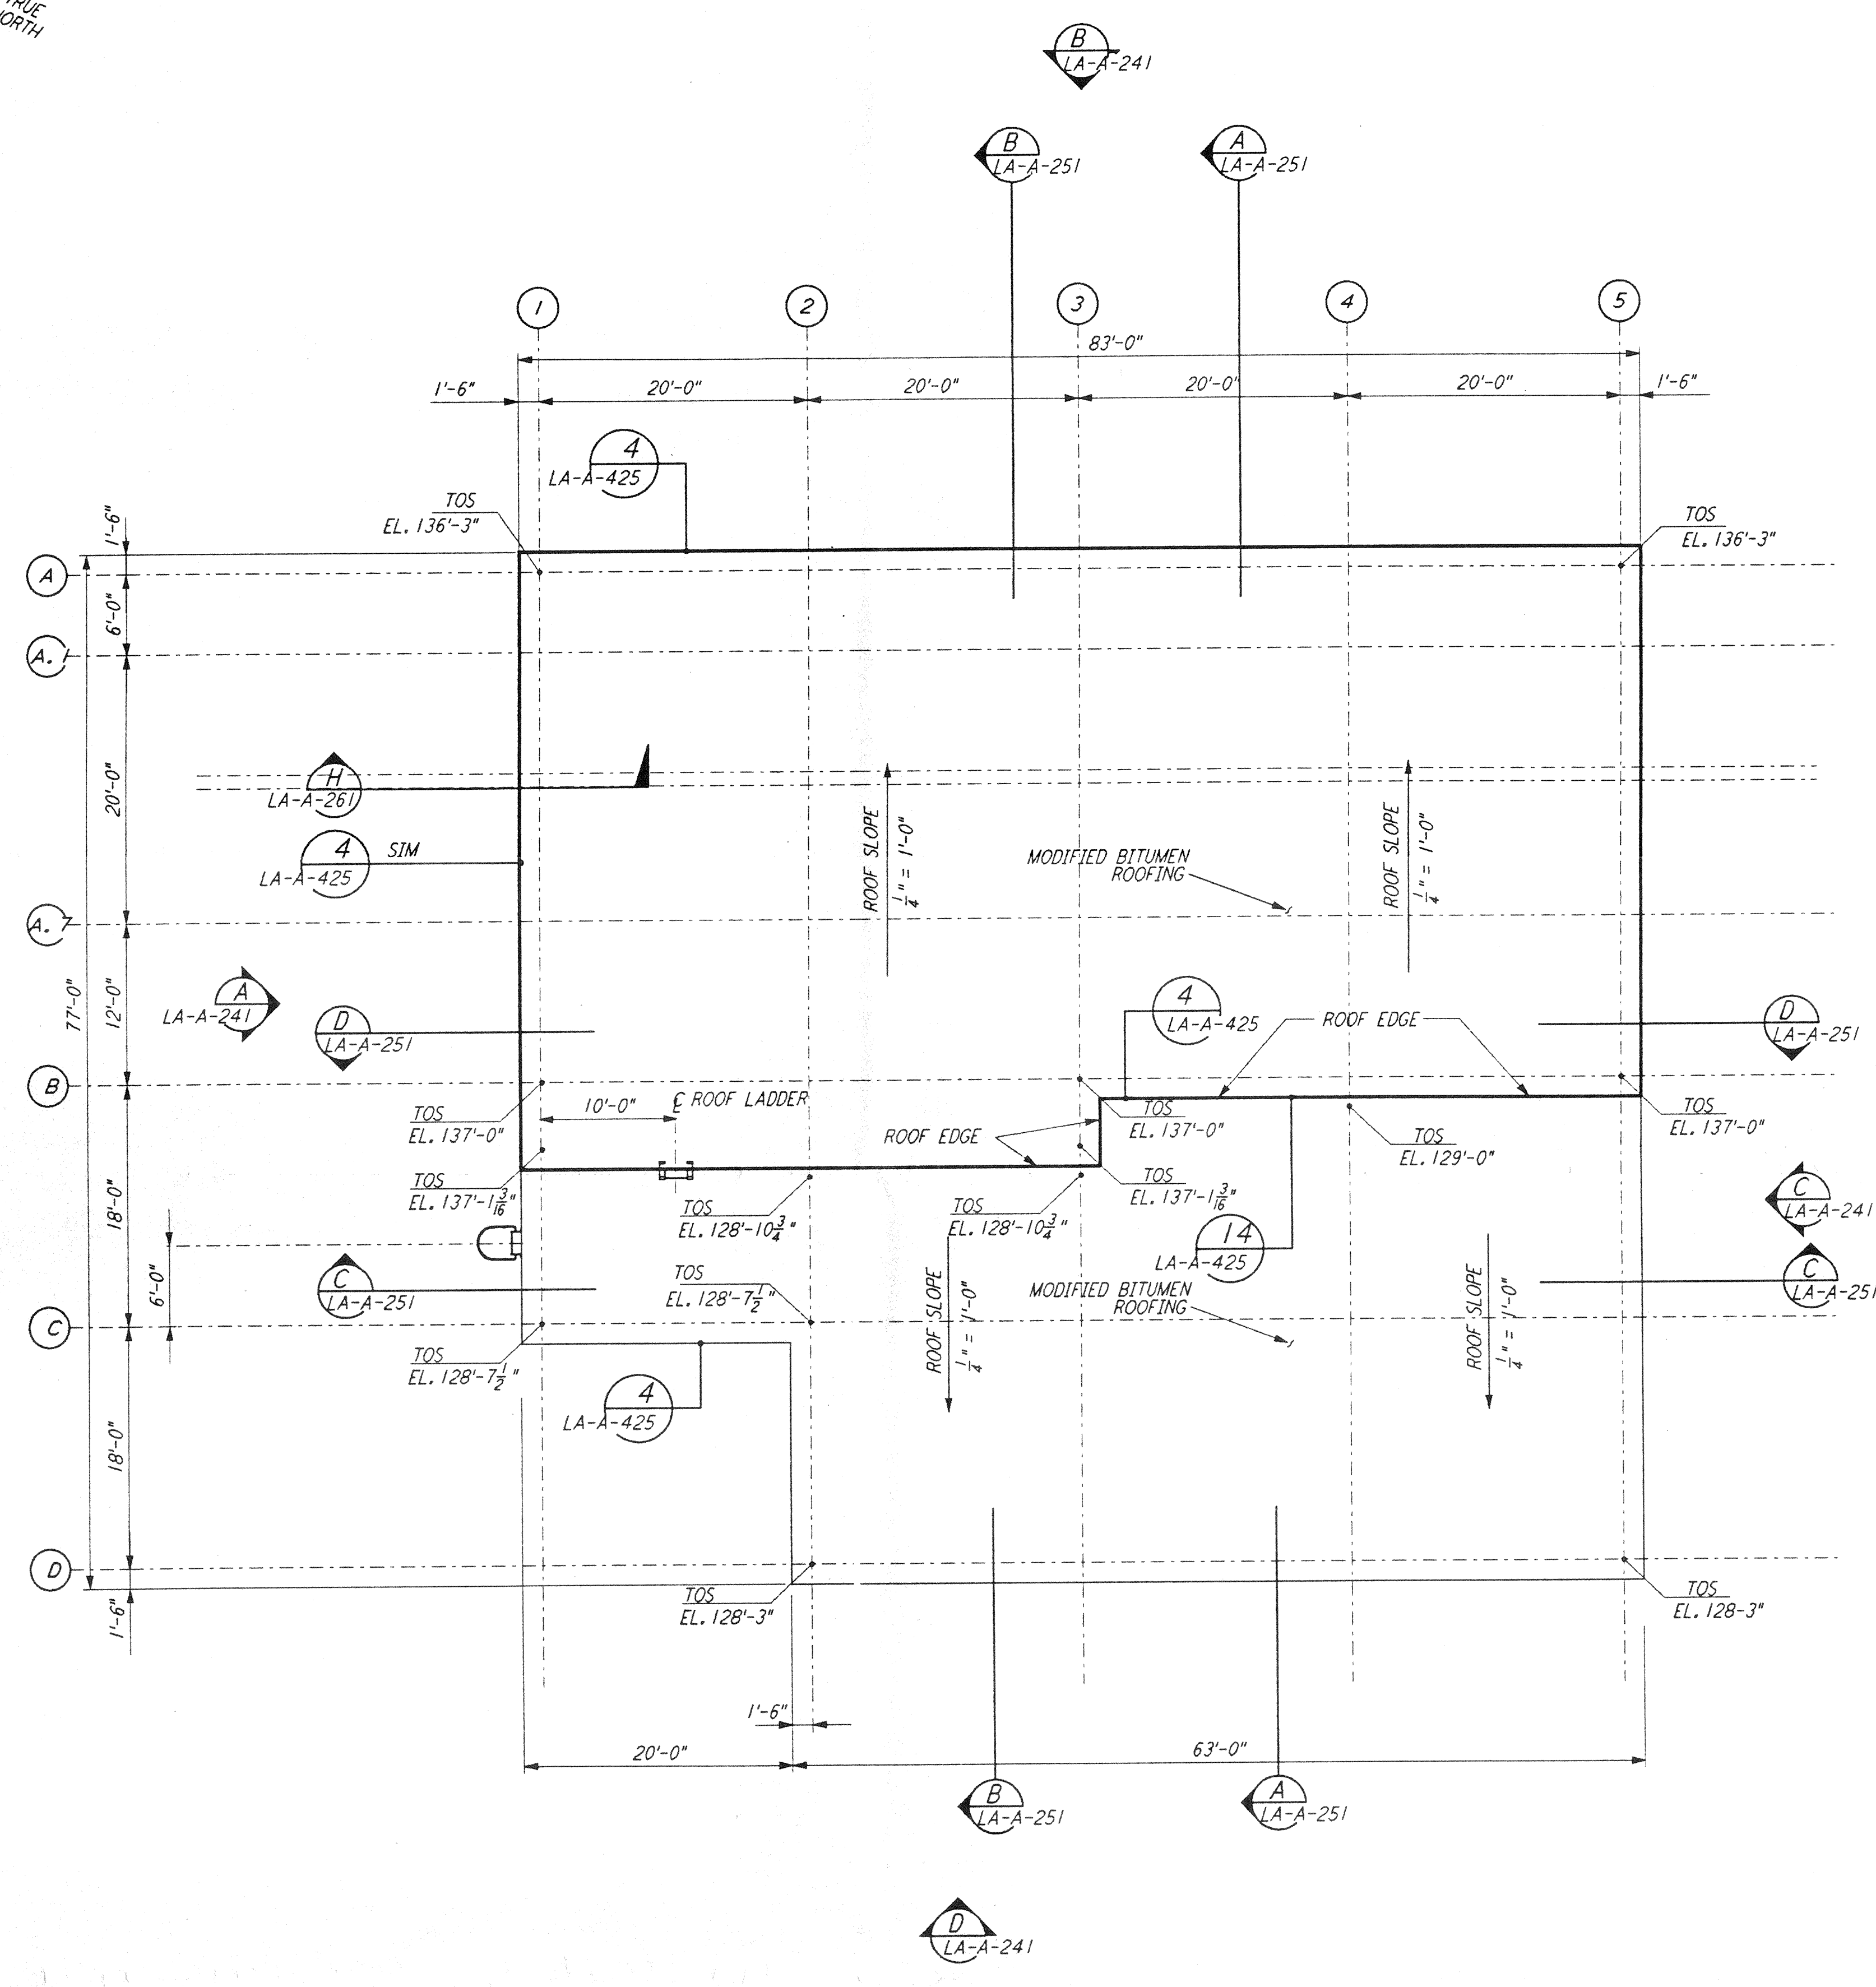

END STATIONS REFLECTED CEILING PLAN
 1/8" = 1'-0" (LA-A-221)

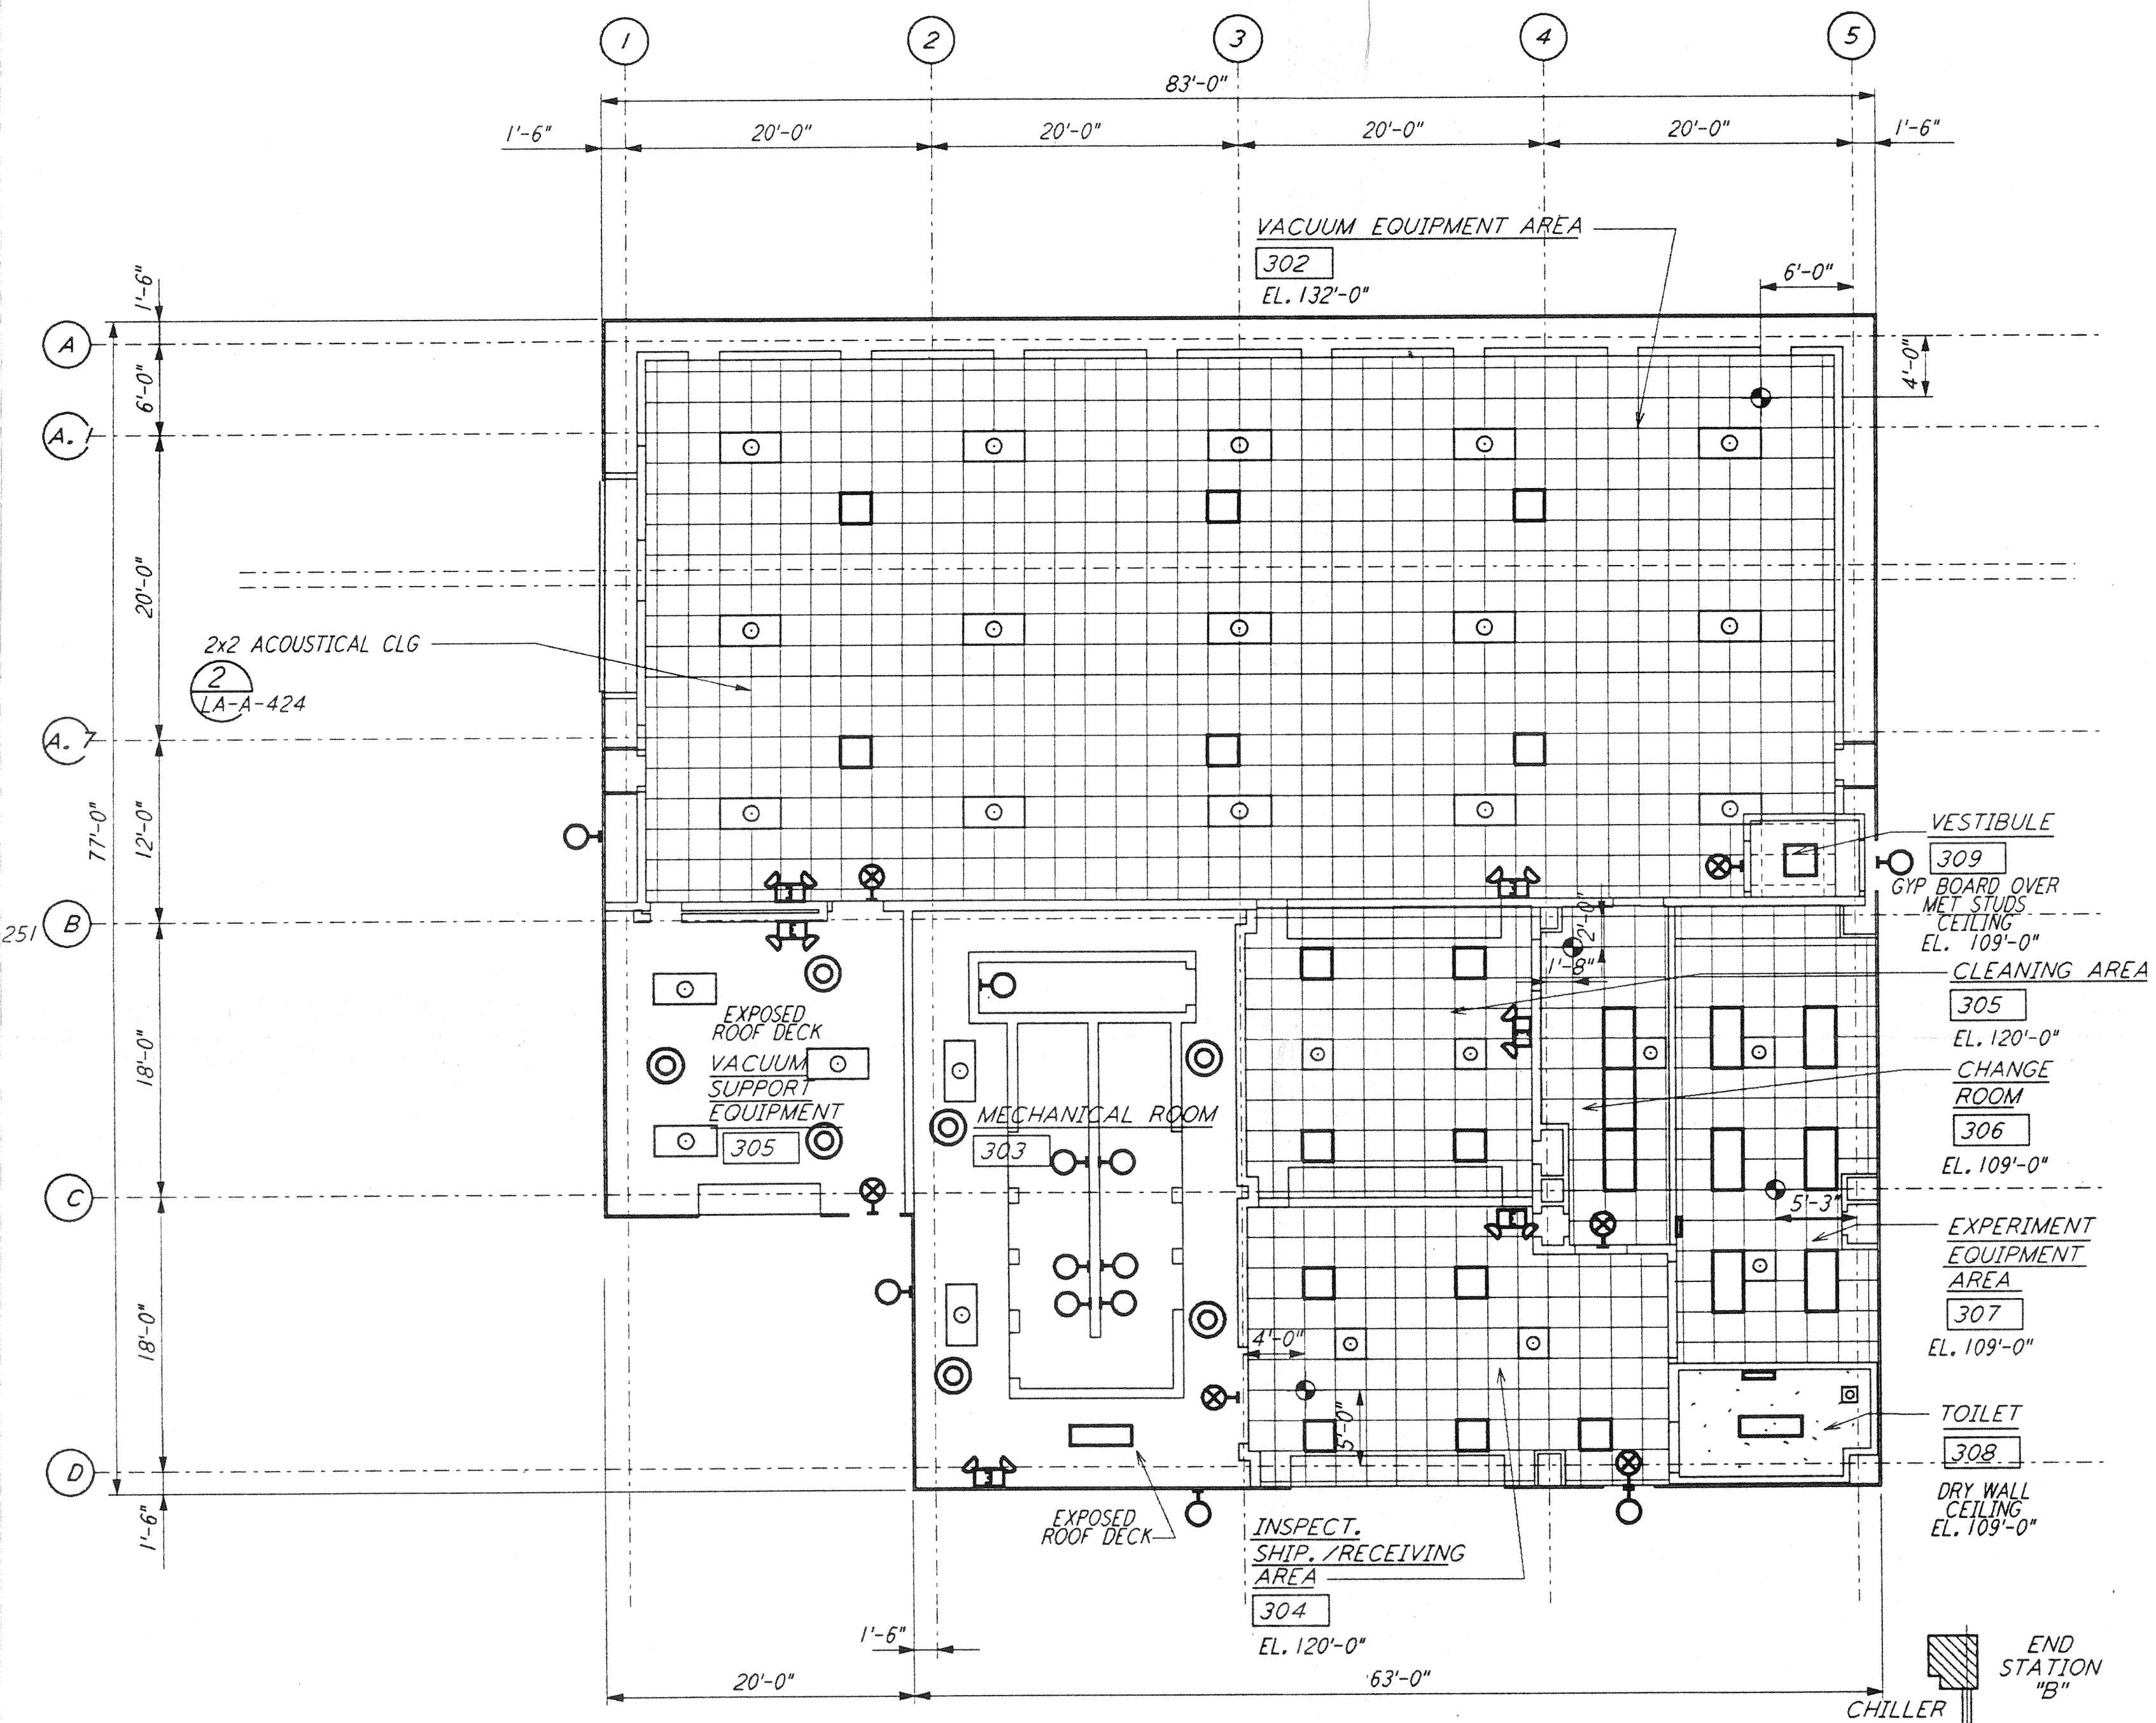

DATUM POINT EL +100, 00 = 57.46' (END STATION "B")
 DATUM POINT EL +100, 00 = 61.49' (END STATION "A")



KEY PLAN

DRAWING NO.	DESCRIPTION	NO.	DATE	BY	CHKD	ENGR	PROJ	DESCRIPTION

ISSUED FOR CONSTRUCTION		
DRAWN	CKT	11-15-96
CHECKED	TD	11-15-96
ENGINEER	SF	11-15-96
PROJ	ES	11/12/96



PARSONS
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 PASADENA, CALIFORNIA

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 MASSACHUSETTS INSTITUTE OF TECHNOLOGY

LASER INTERFEROMETER
 GRAVITATIONAL-WAVE OBSERVATORY
 SITE NO. 2 - LIVINGSTON, LOUISIANA

TITLE	SCALE	CONTRACT NUMBER	PROJECT NUMBER
ARCHITECTURAL END STATIONS REFLECTED CEILING PLAN & ROOF PLAN	AS NOTED	PP150969	8094
SHEET NUMBER		REVISIONS	
LA-A-221			