




MID STATION "A" / "B" REFLECTED CEILING PLAN
 1/8" = 1'-0" (4) LA-A-201

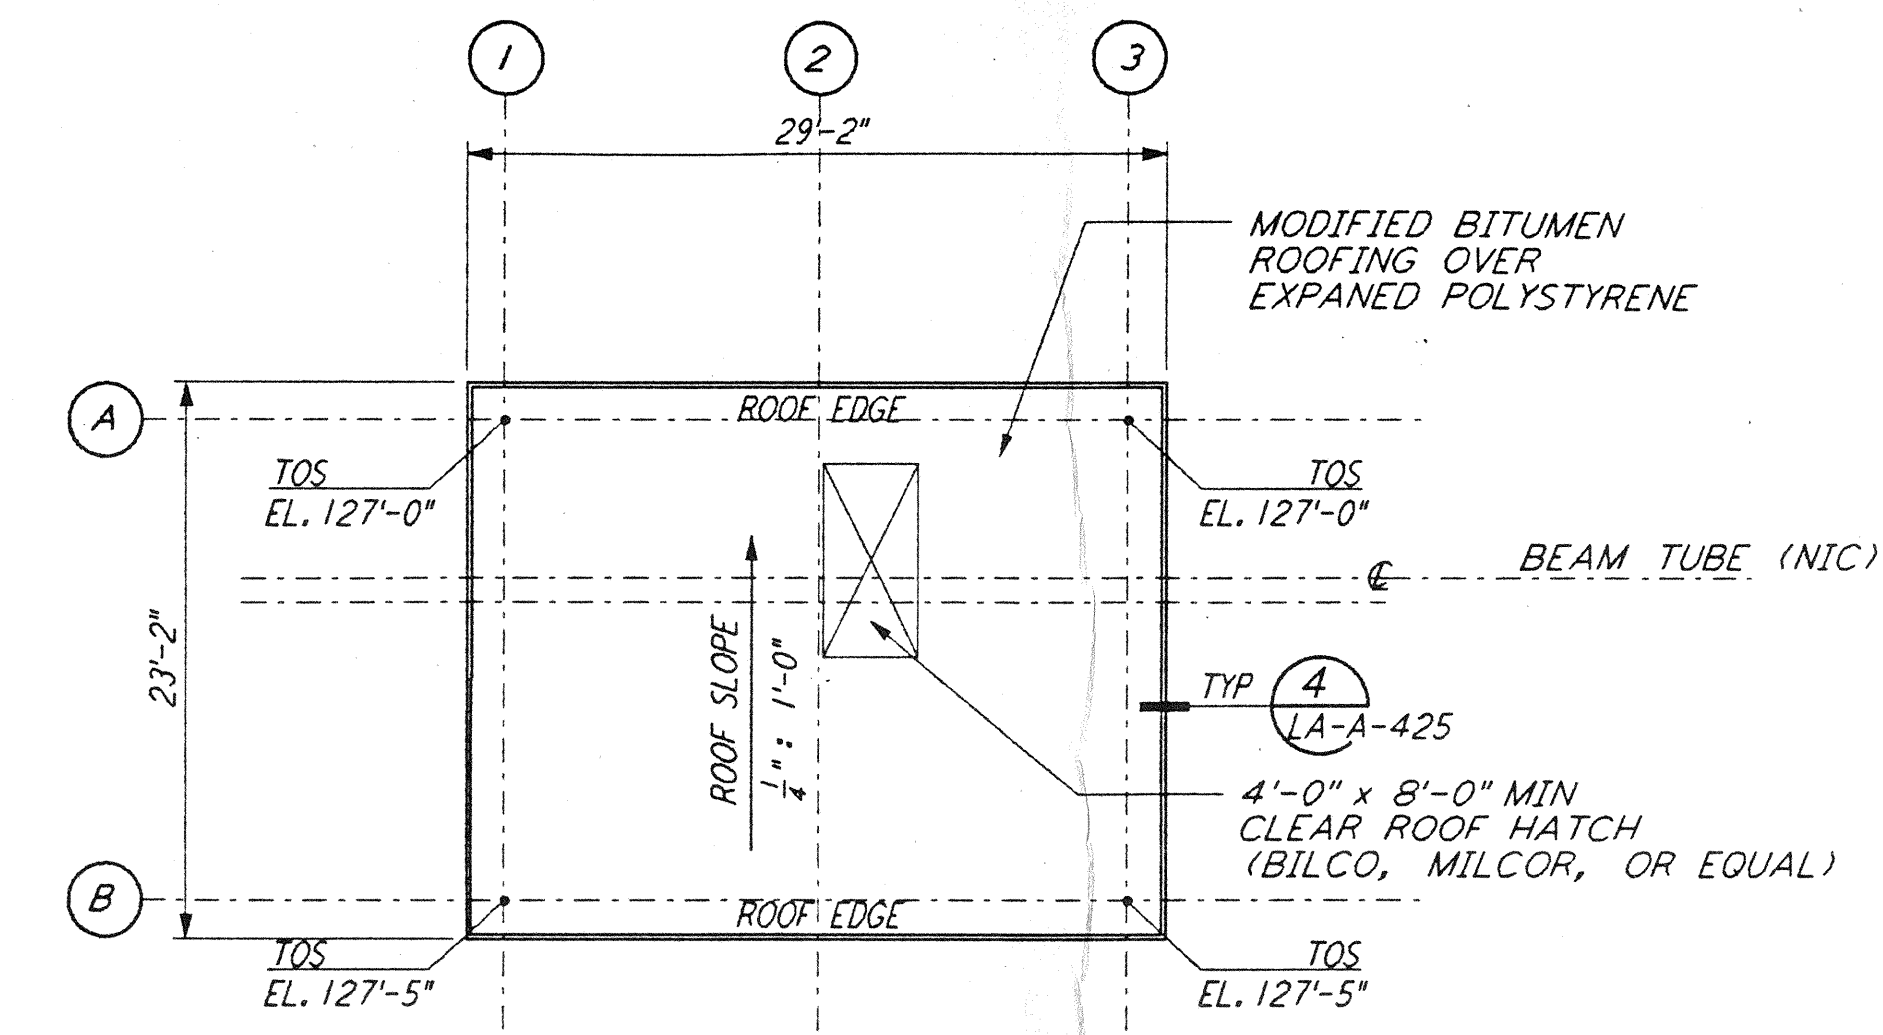


MID STATION "A" / "B" ROOF PLAN
 1/8" = 1'-0" (1) LA-A-201

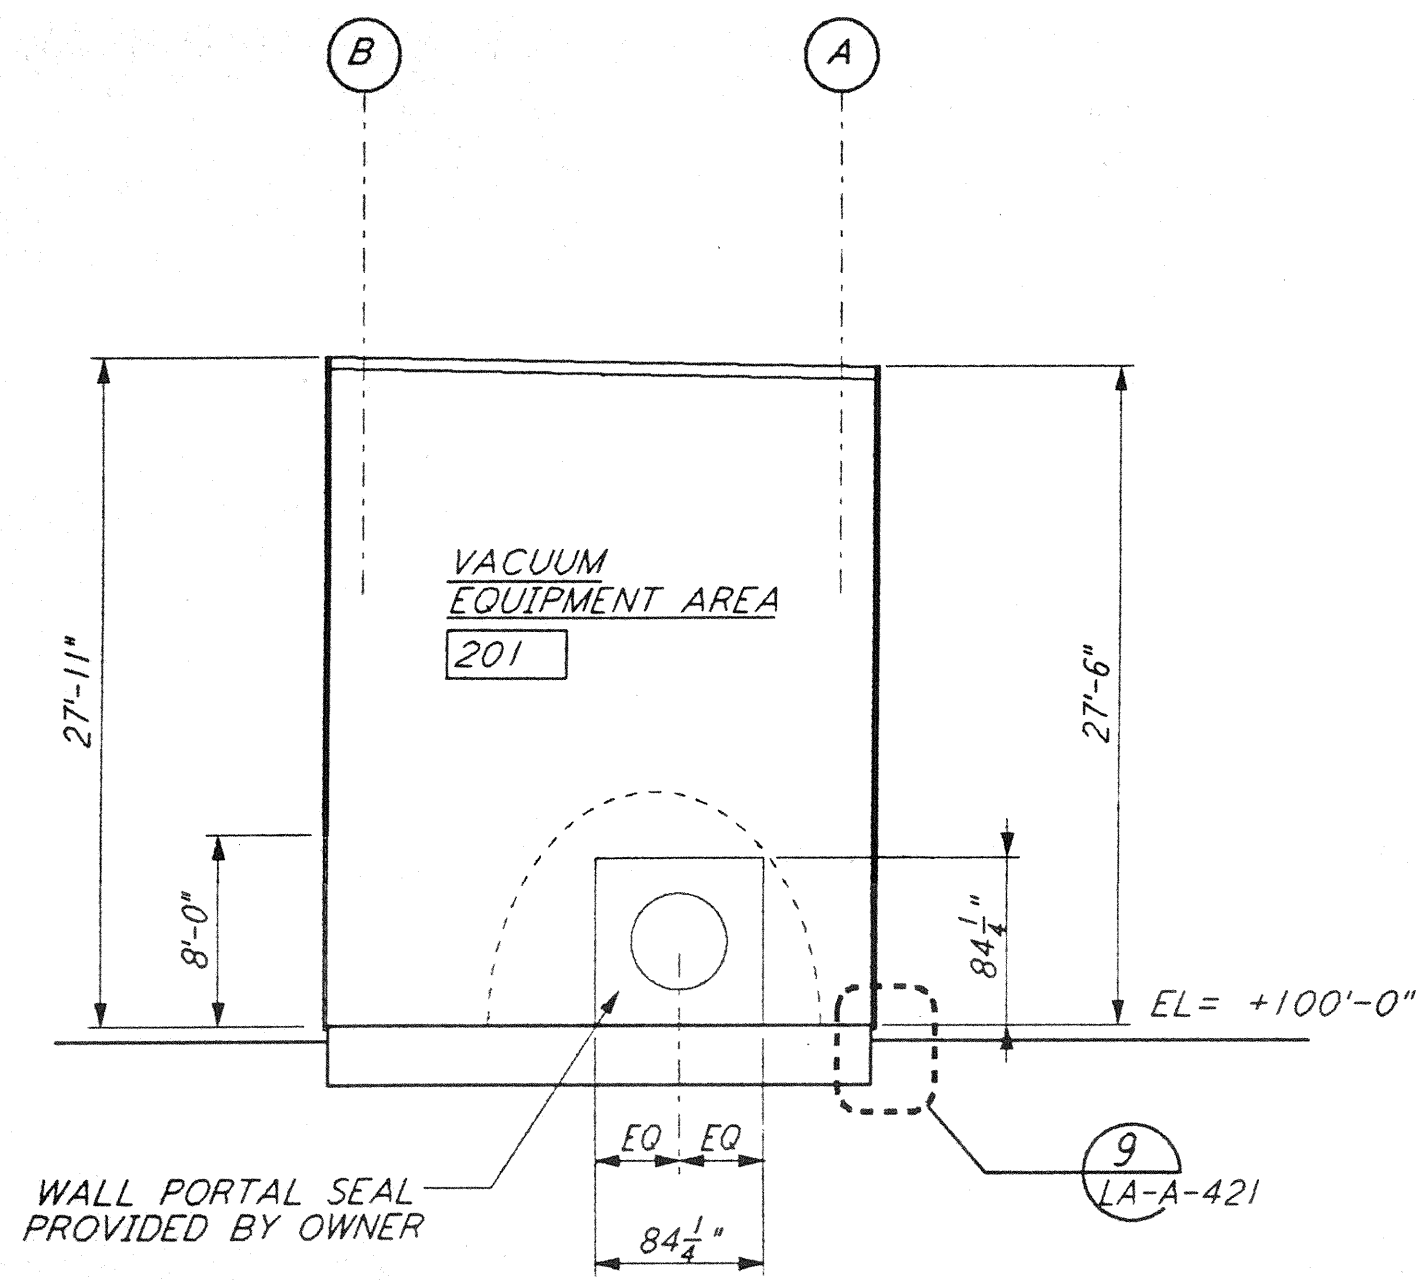


SECTION A-A
 1/8" = 1'-0" (9) LA-A-201

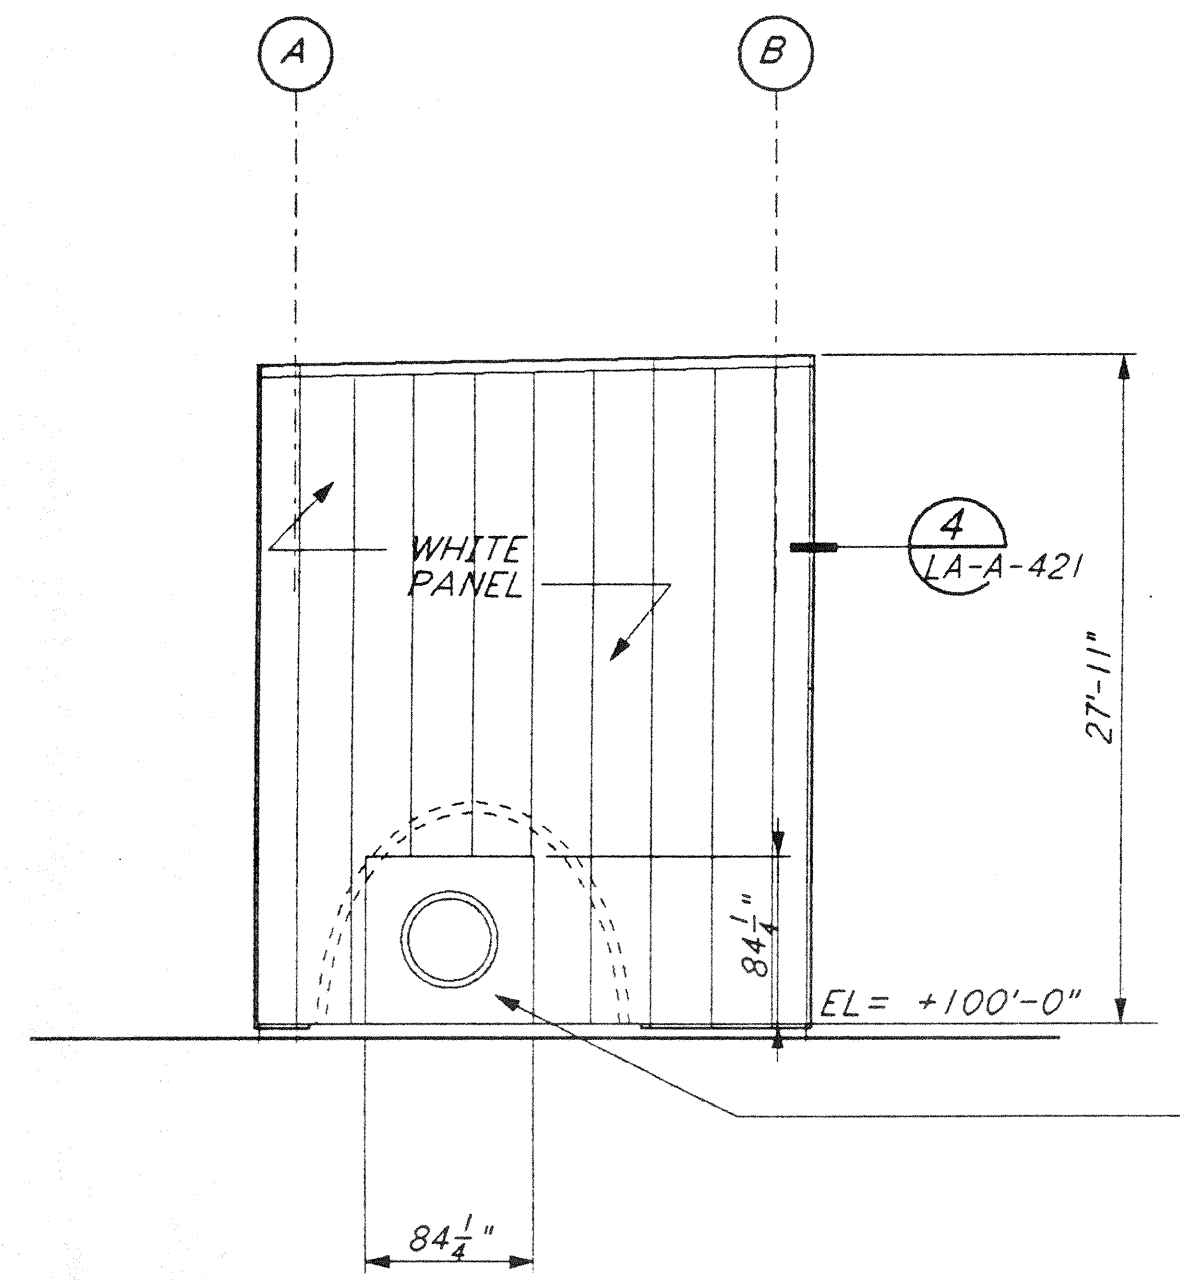


ELEVATION A-A
 1/8" = 1'-0" (4) LA-A-201

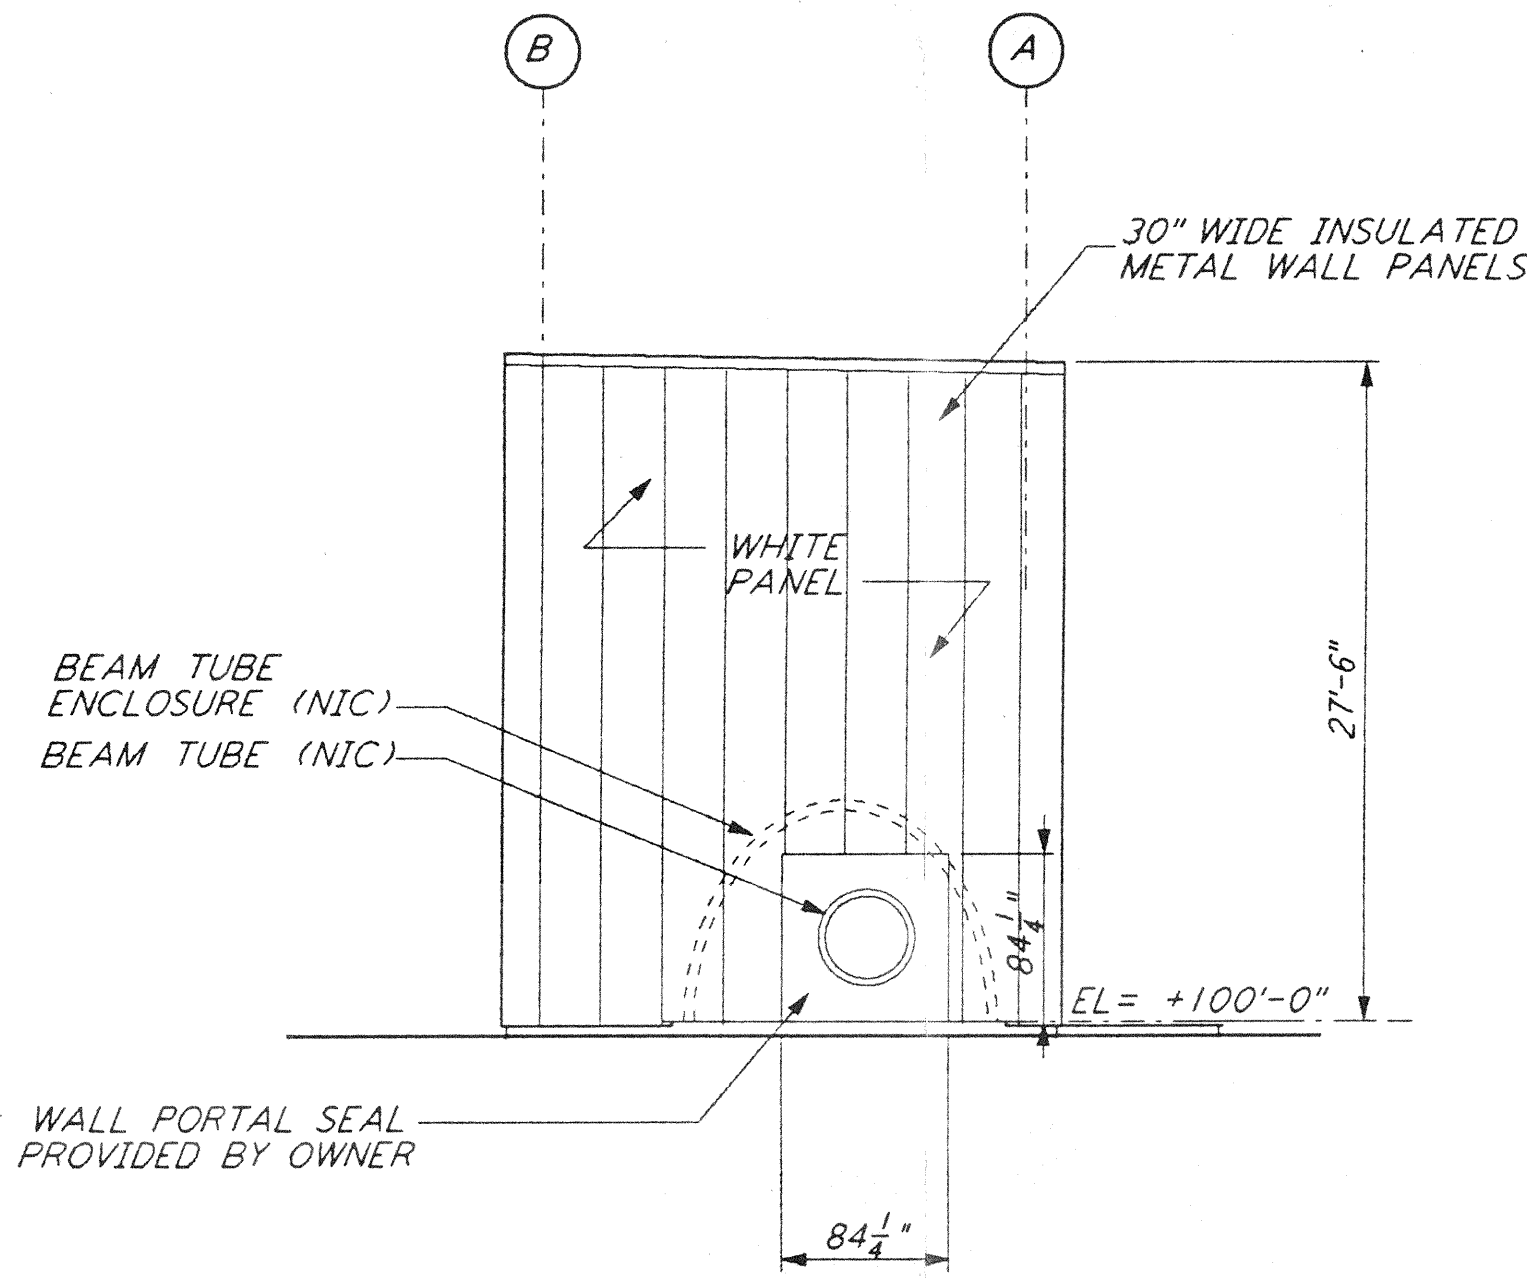


ELEVATION C-C
 1/8" = 1'-0" (3) LA-A-201

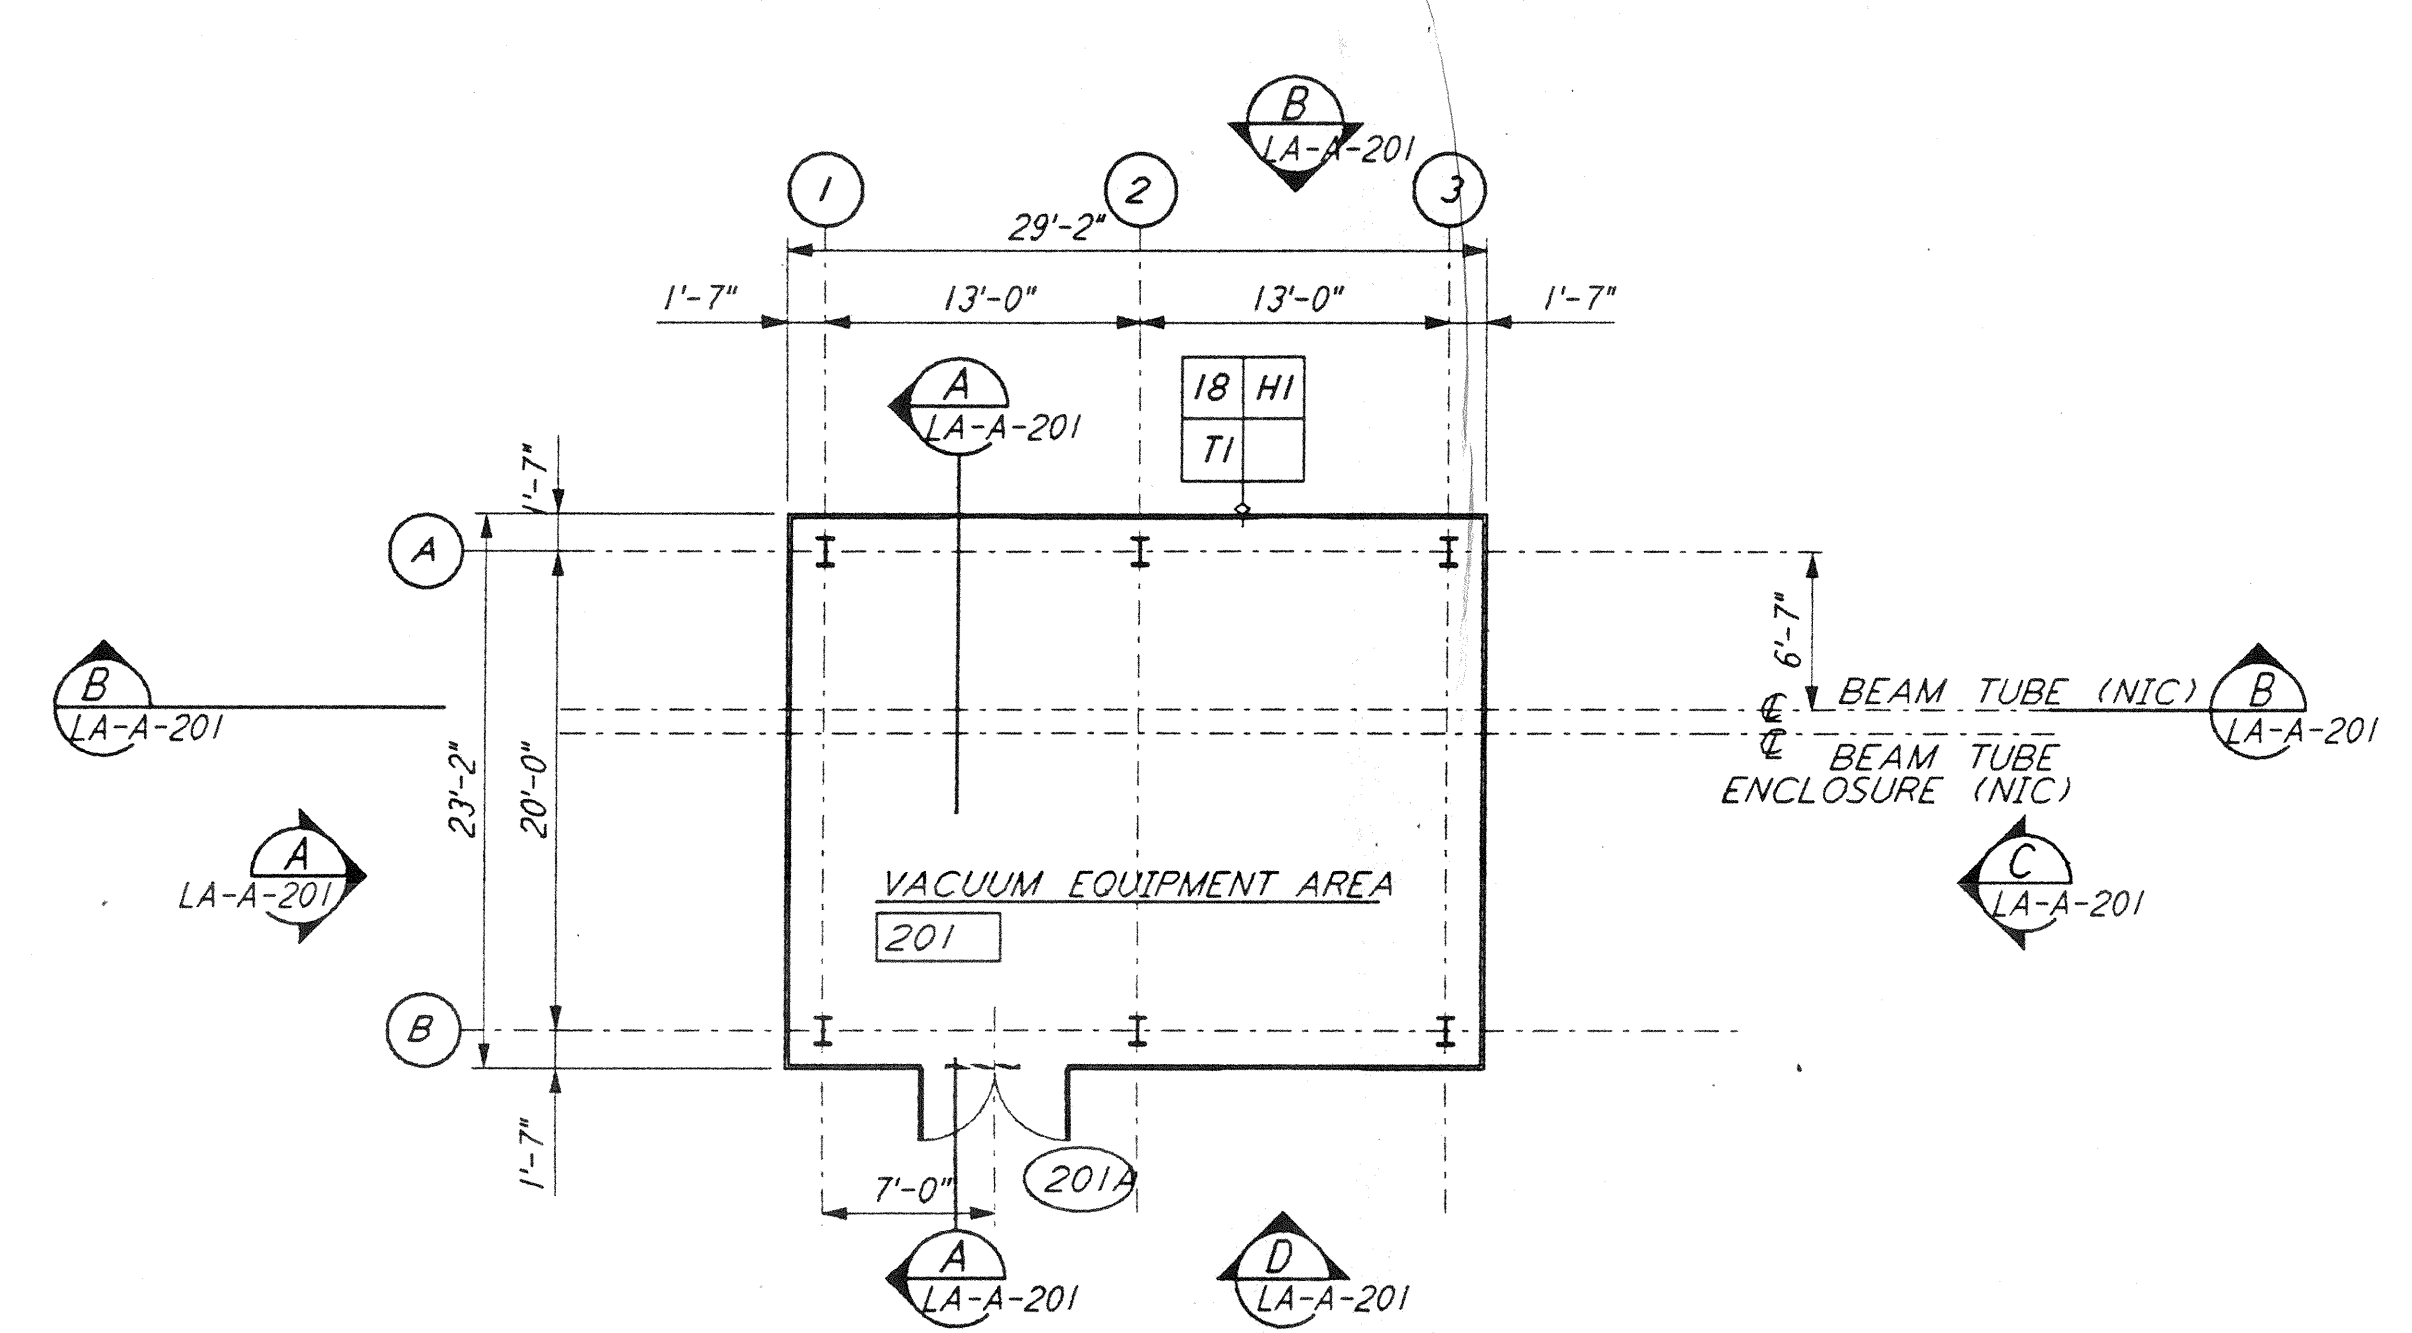


MID STATION "A" FLOOR PLAN
 1/8" = 1'-0" (2) LA-A-201

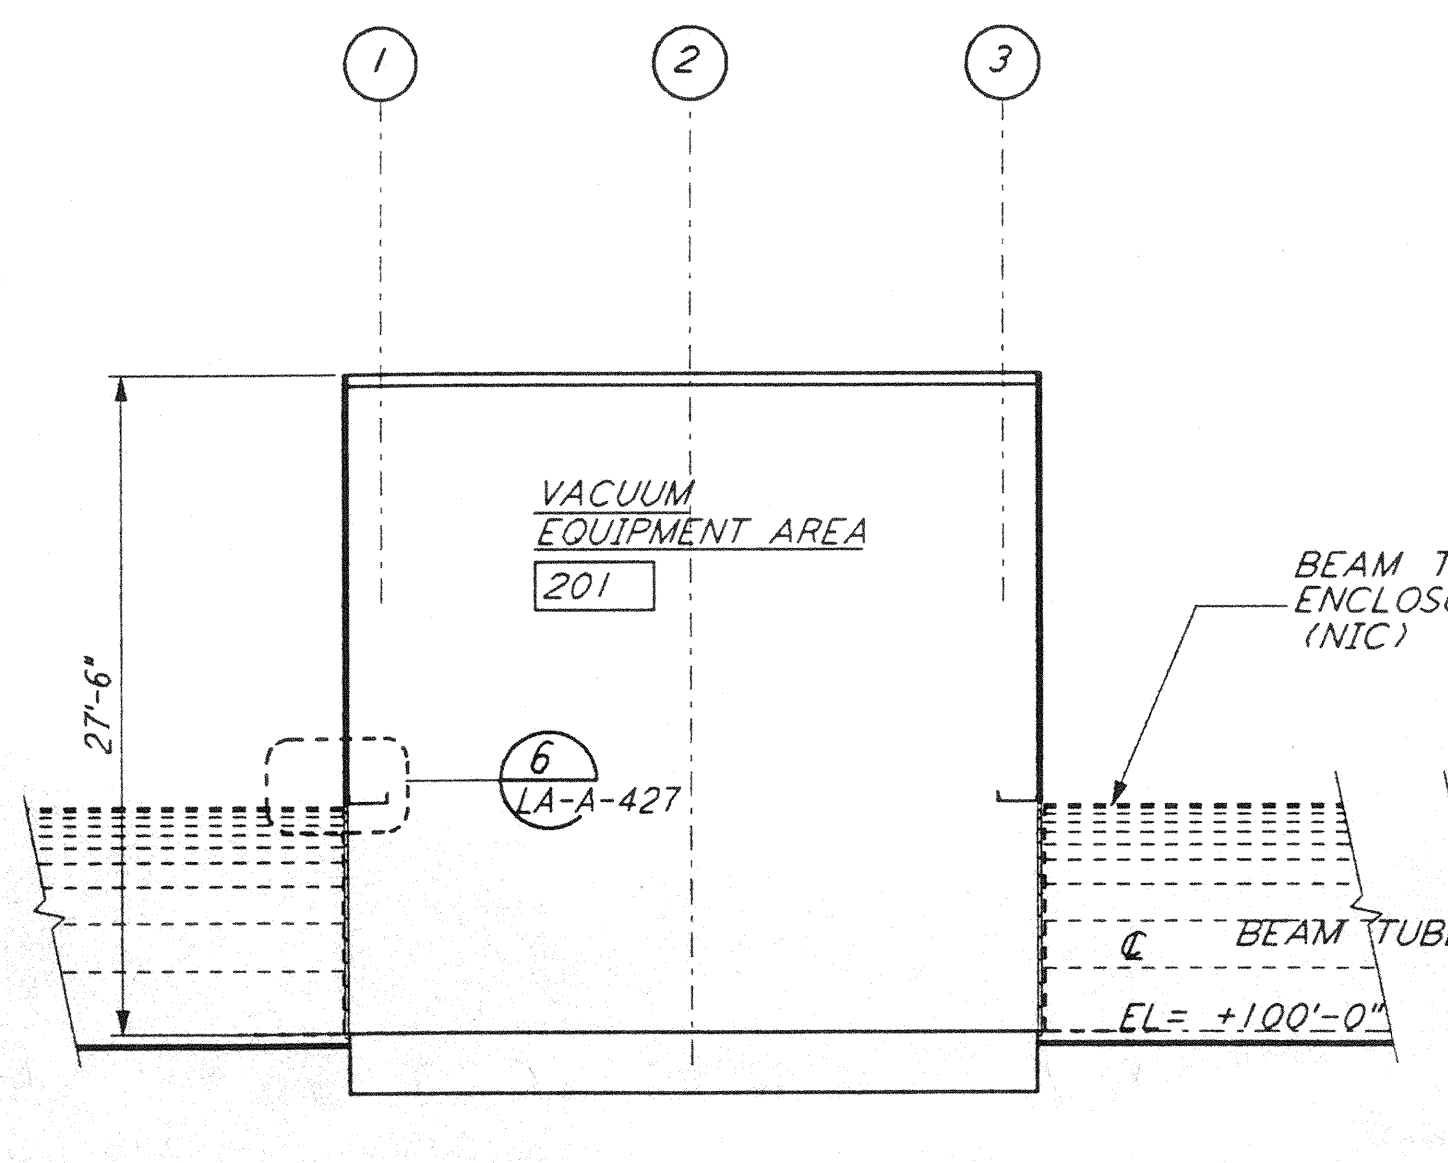


SECTION B-B
 1/8" = 1'-0" (6) LA-A-201

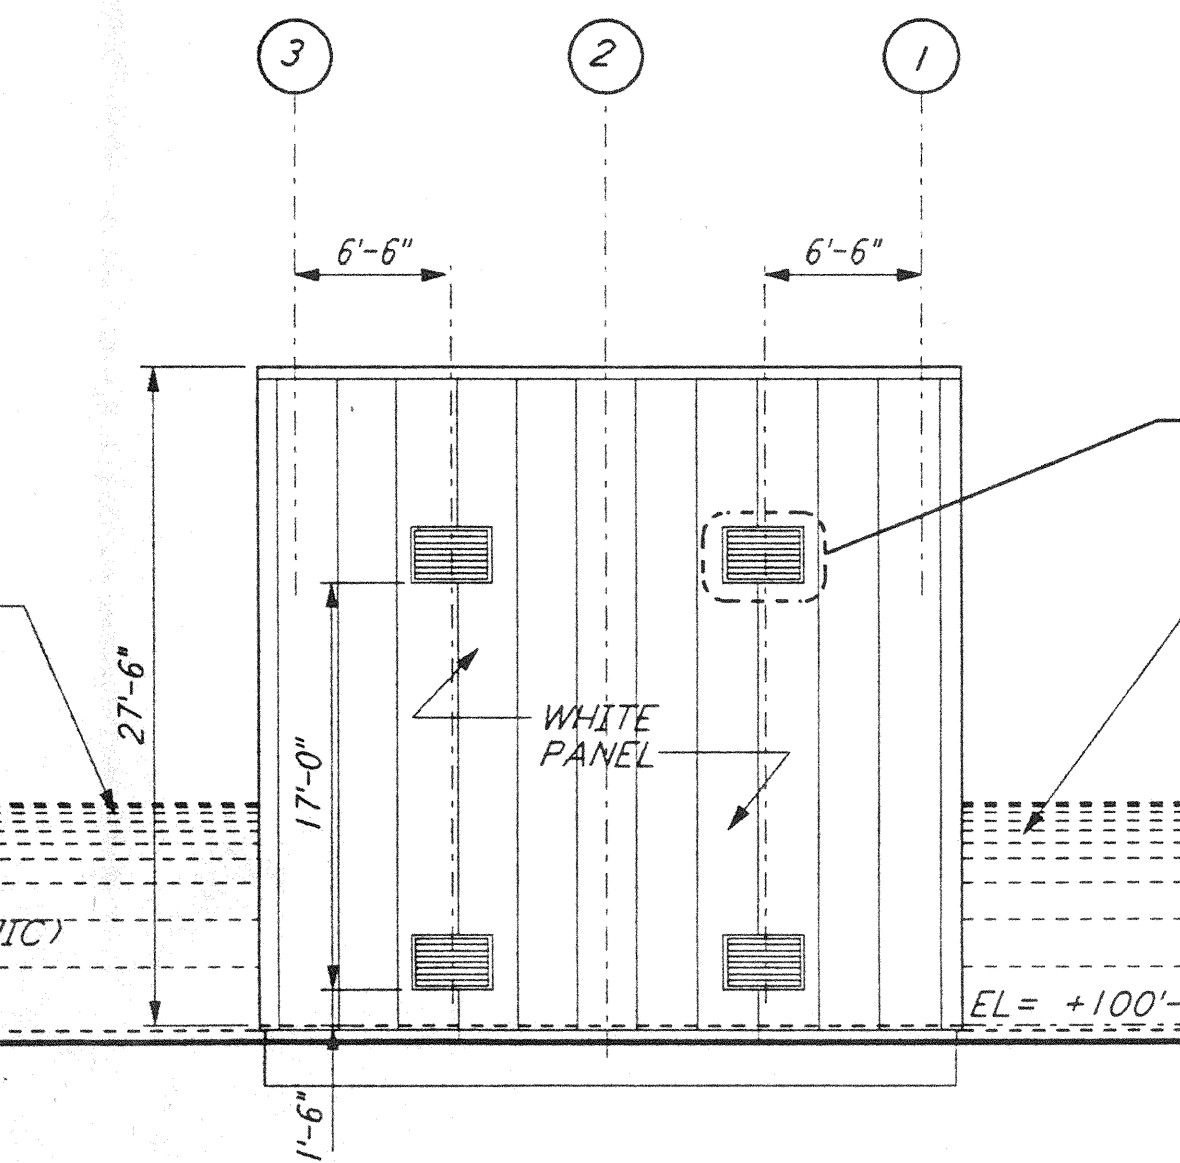


ELEVATION B-B
 1/8" = 1'-0" (5) LA-A-201

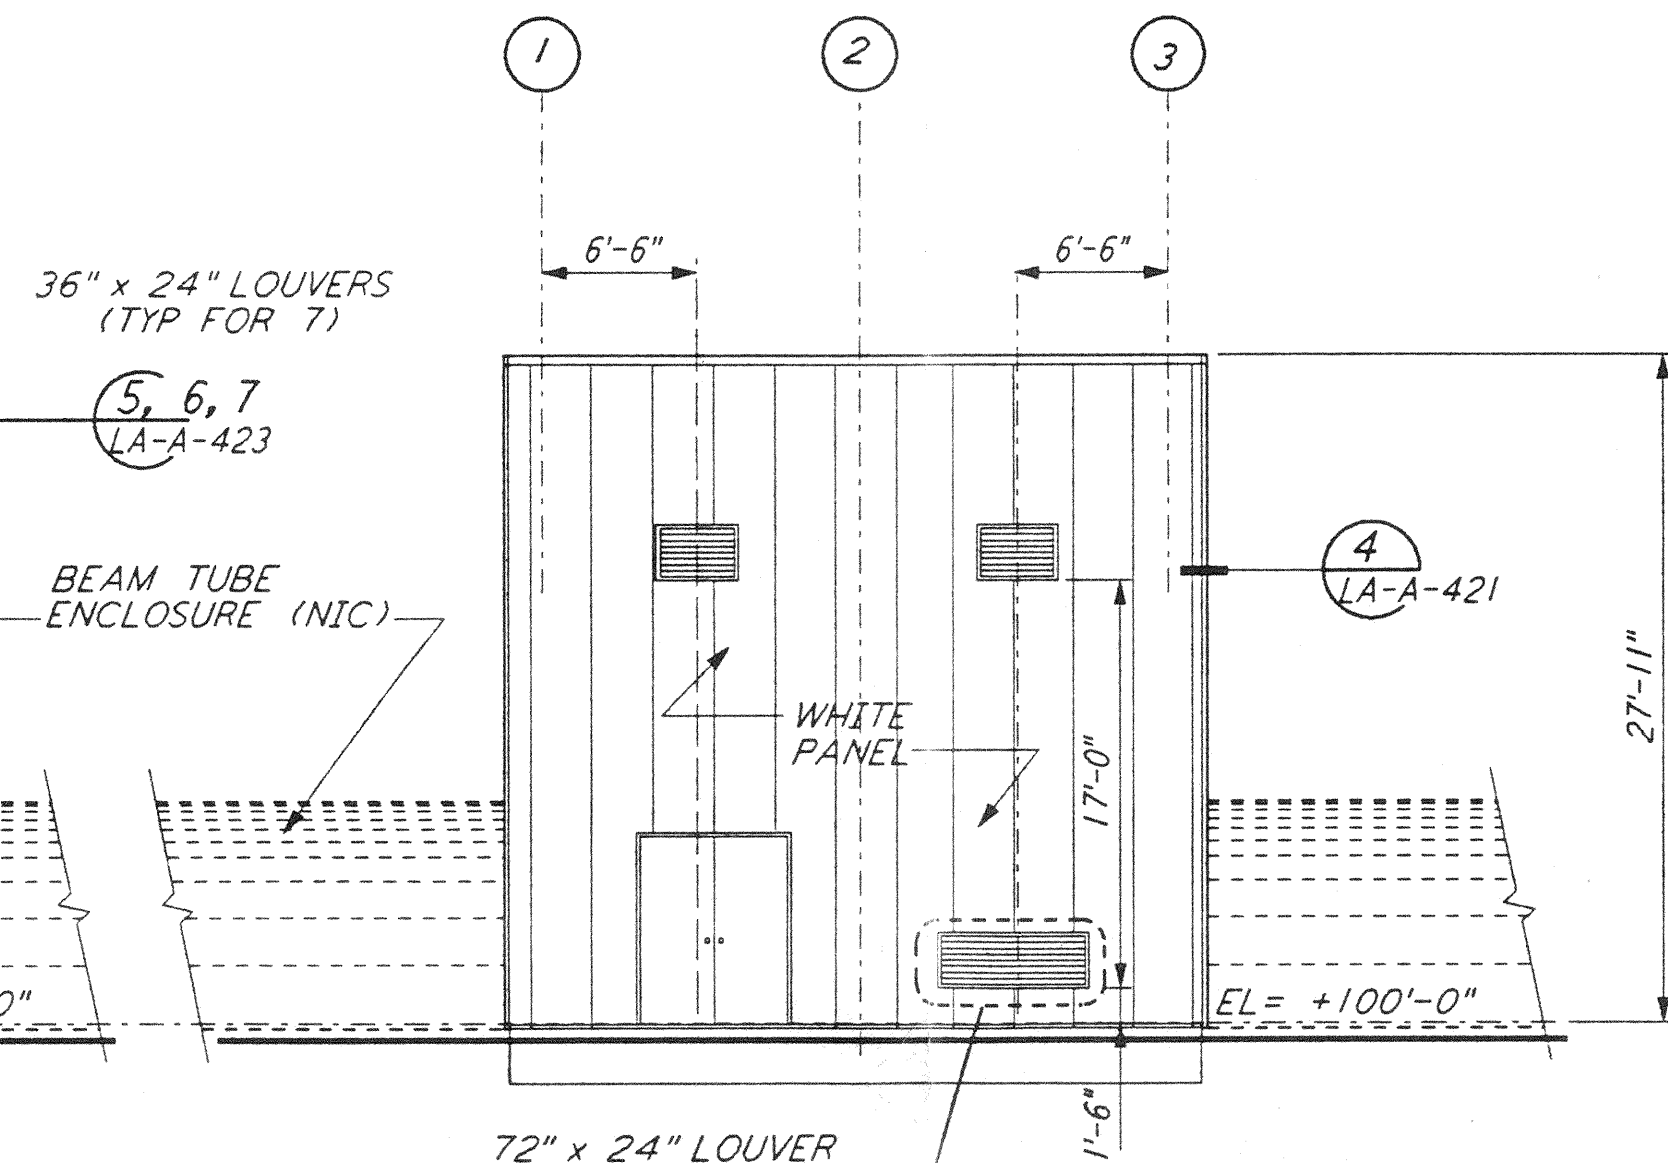


ELEVATION D-D
 1/8" = 1'-0" (4) LA-A-201

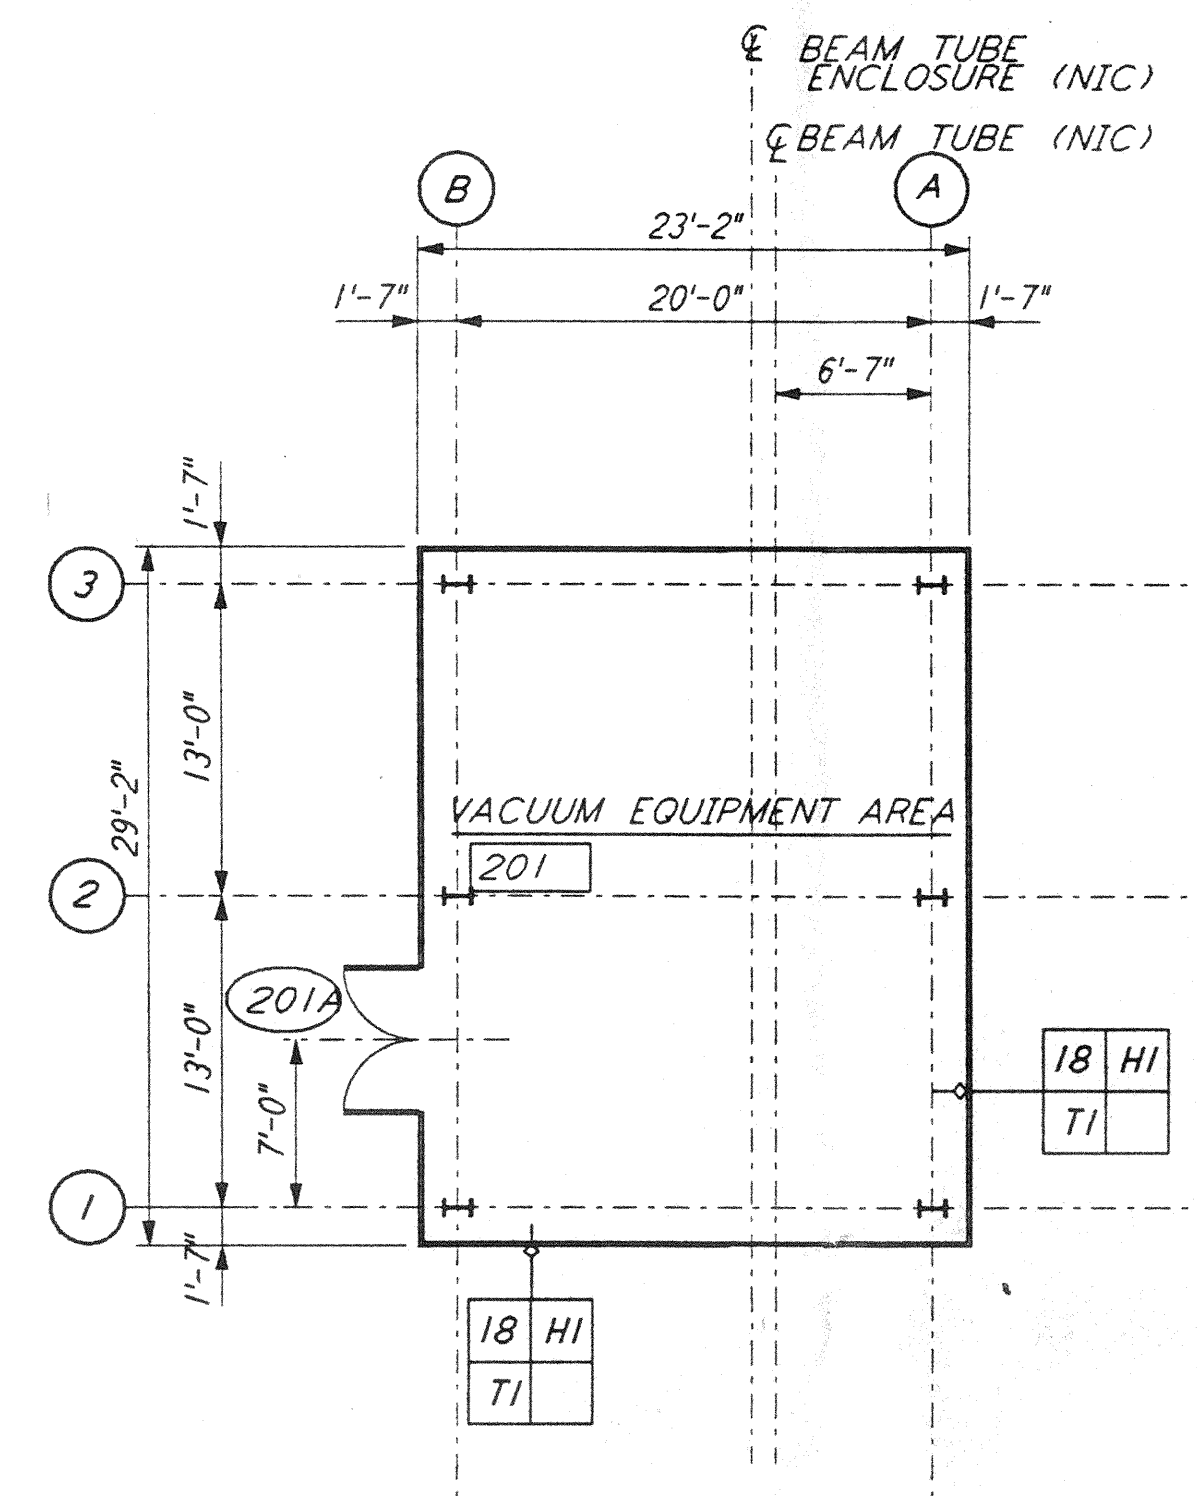

MID STATION "B" FLOOR PLAN
 1/8" = 1'-0" (3) LA-A-201

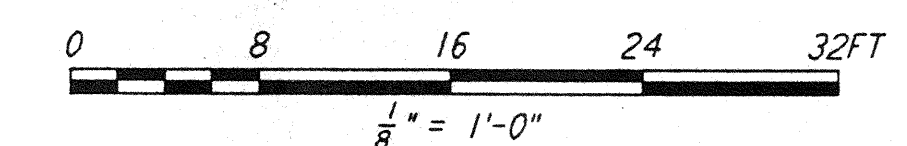

DATUM POINT EL +100.00 = 61.00' (MID STATION "B")
 DATUM POINT EL +100.00 = 63.00' (MID STATION "A")

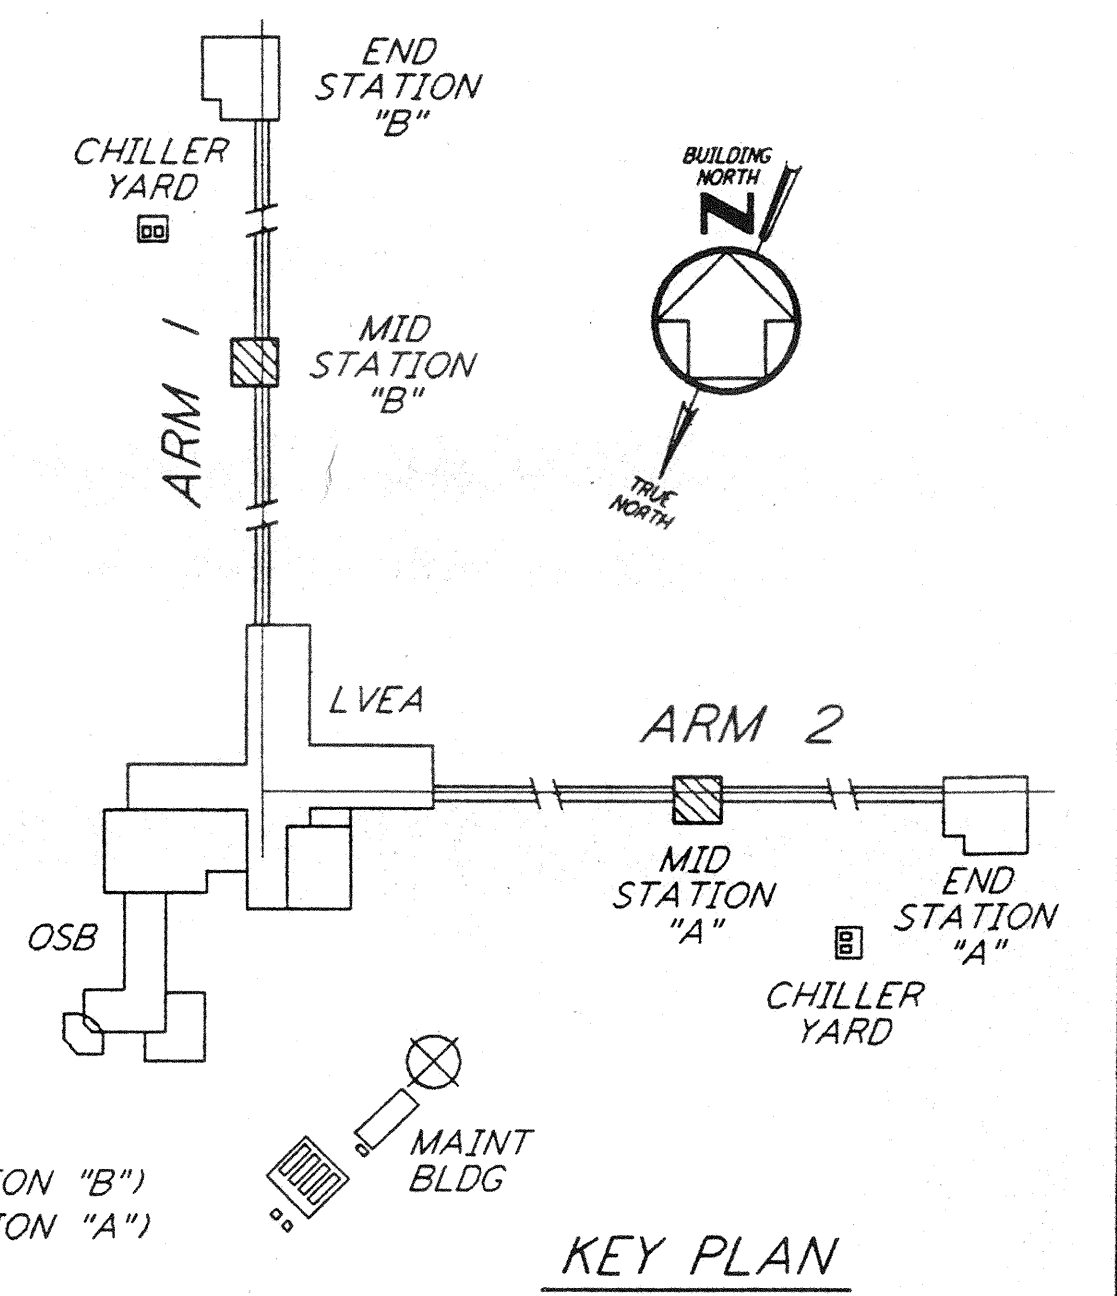


KEY PLAN

not be reproduced, copied, loaned, exhibited, or used in any other way, except by written consent from PARSONS to the borrower.

This document and the design it covers are the property of PARSONS. They are loaned only with the borrower's expressed written agreement that they will

NO.	DATE	BY	CHKD	ENGR	PROJ	DESCRIPTION

ISSUED FOR CONSTRUCTION	
DRAWN	CKT 11-15-96
CHECKED	TB 1-15-96
ENGINEER	SP 11-15-96
PROJ	SP 11-15-96

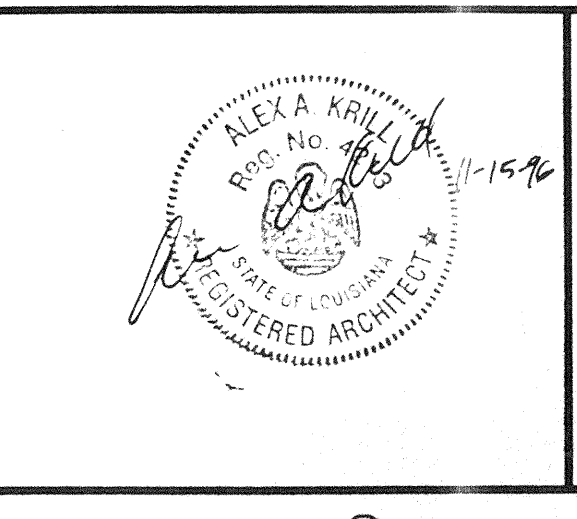

PARSONS
 100 WEST WALNUT STREET
 PASADENA, CALIFORNIA

LIGO
 CALIFORNIA INSTITUTE OF TECHNOLOGY
 MASSACHUSETTS INSTITUTE OF TECHNOLOGY

LASER INTERFEROMETER
 GRAVITATIONAL-WAVE OBSERVATORY
 SITE NO. 2 - LIVINGSTON, LOUISIANA

ARCHITECTURAL
 MID STATIONS
 PLANS/SECTIONS/ELEVATIONS

SCALE: AS NOTED
 CONTRACT NUMBER: PP150969
 PROJECT NUMBER: 8094
 SHEET NUMBER: **LA-A-201**