
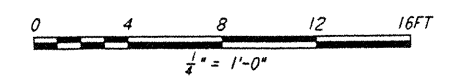
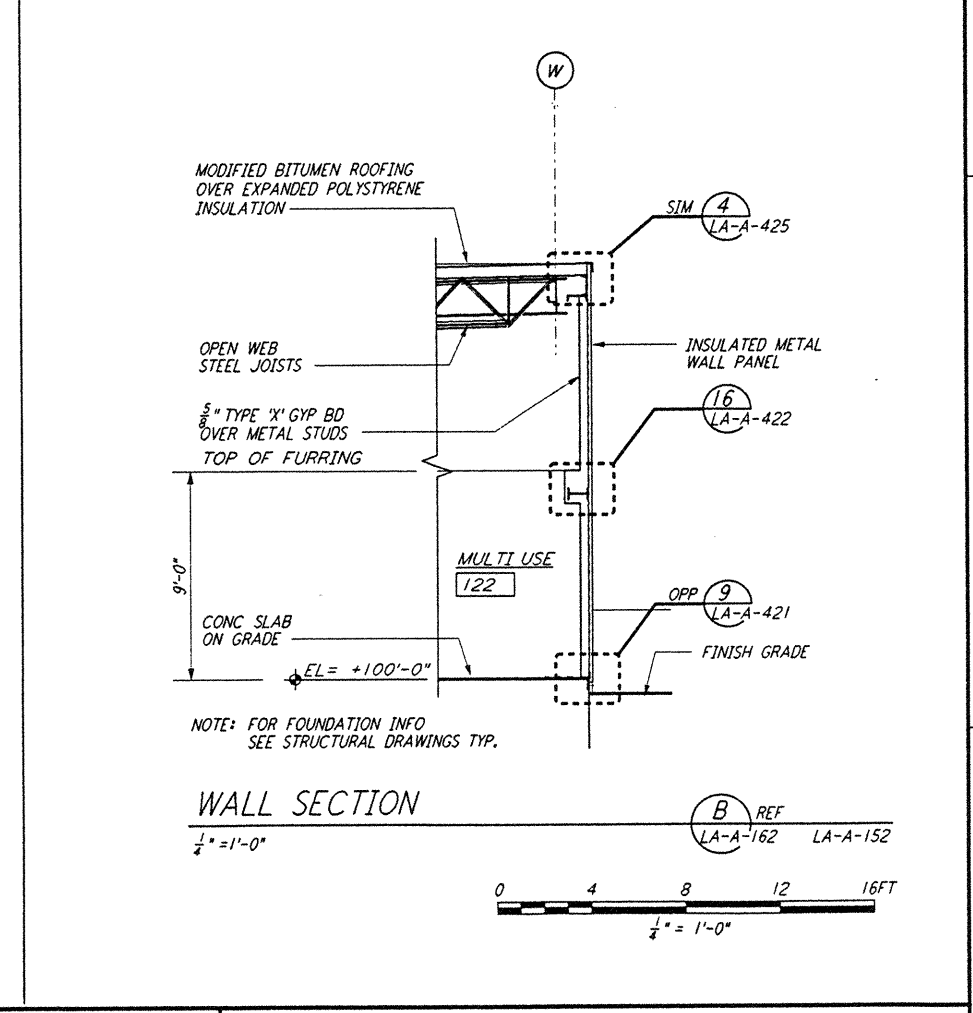
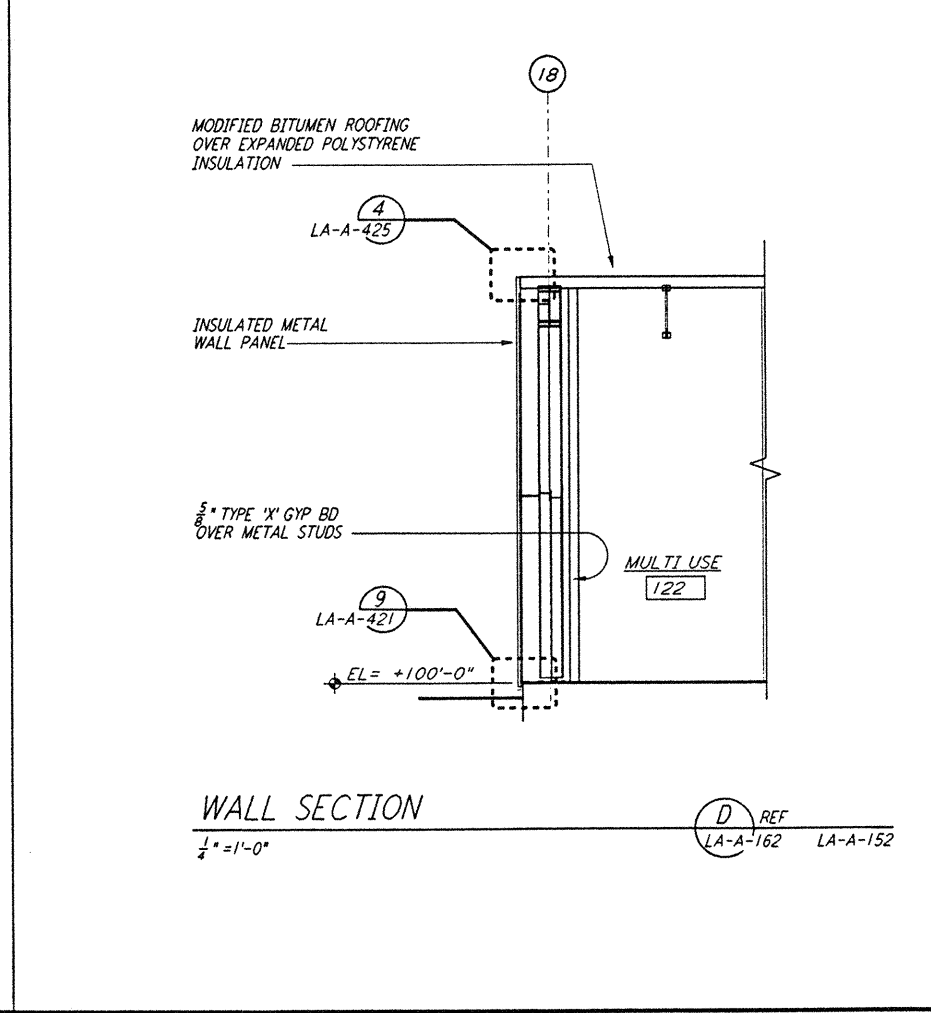
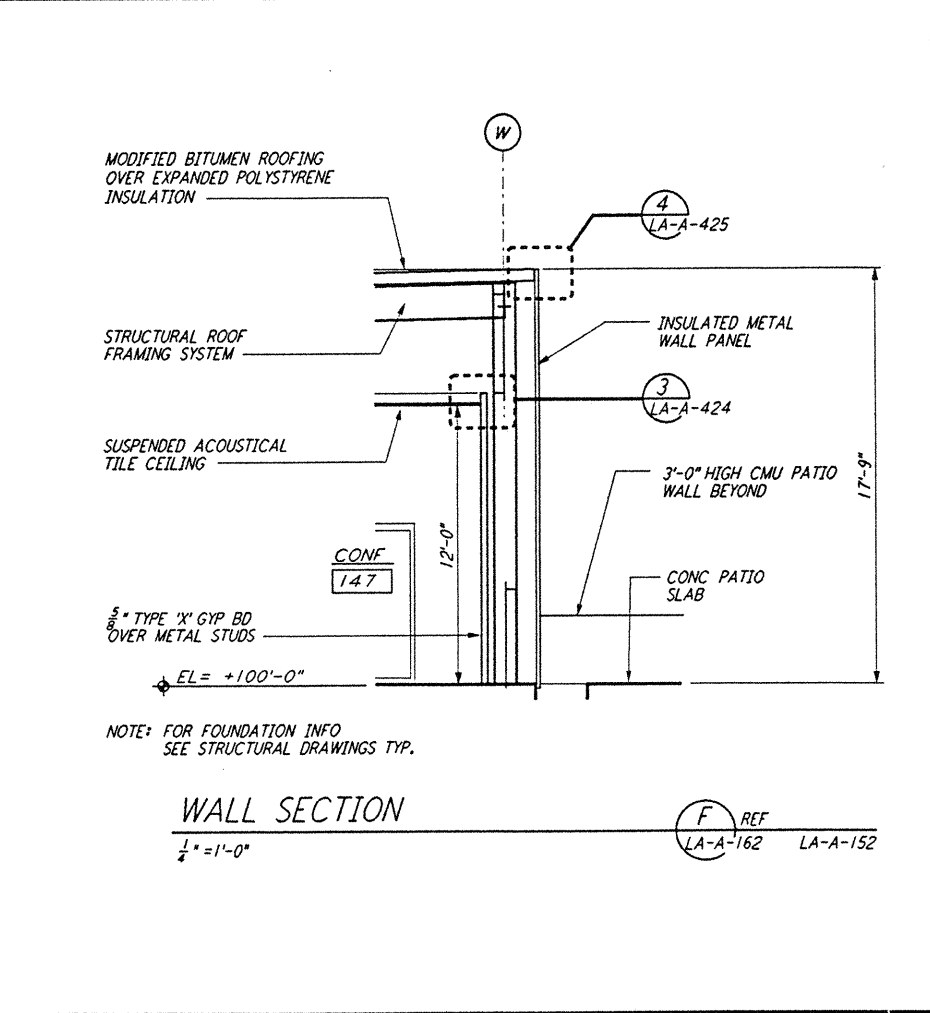
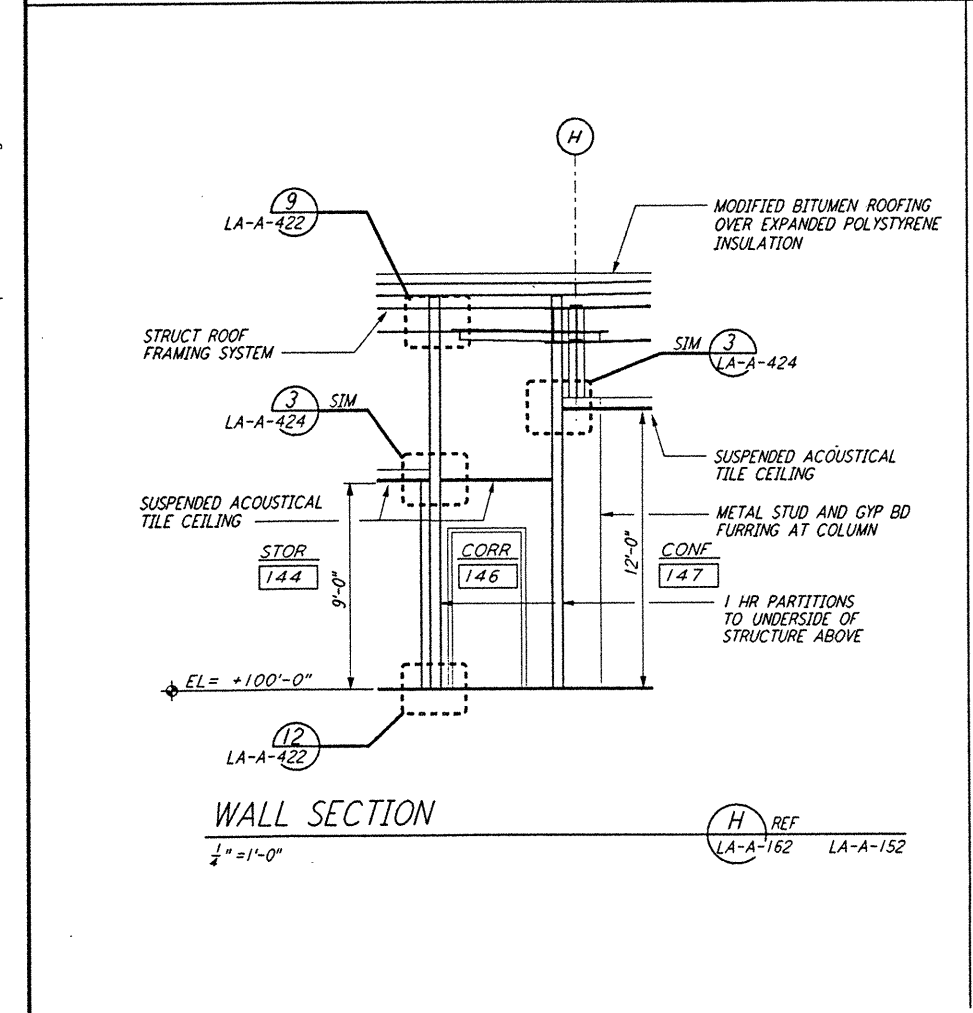
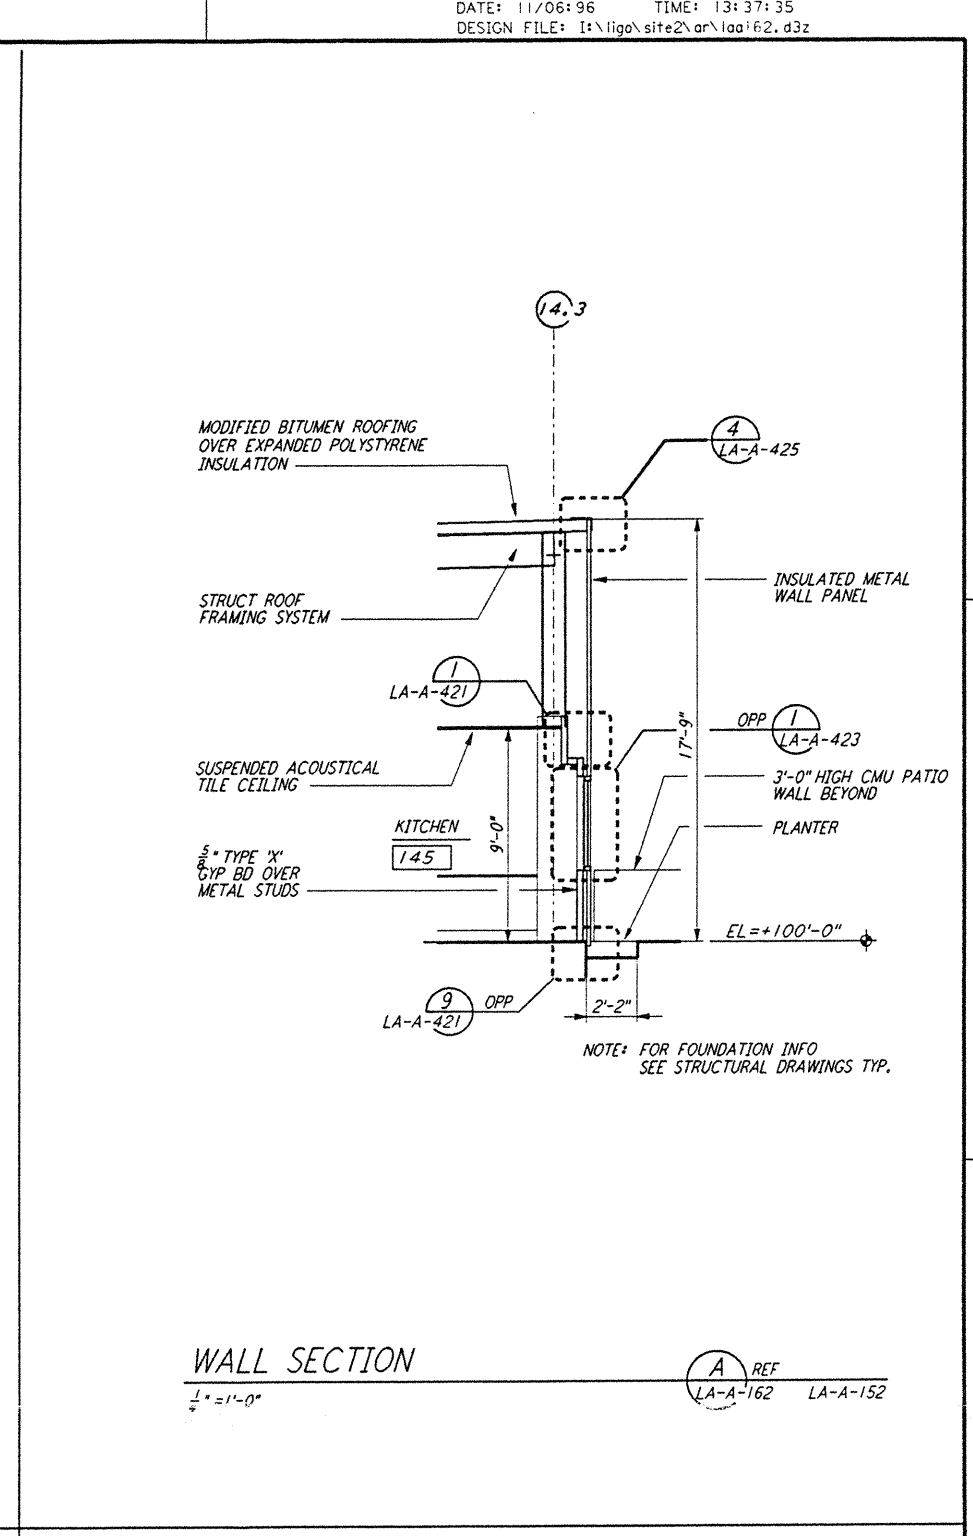
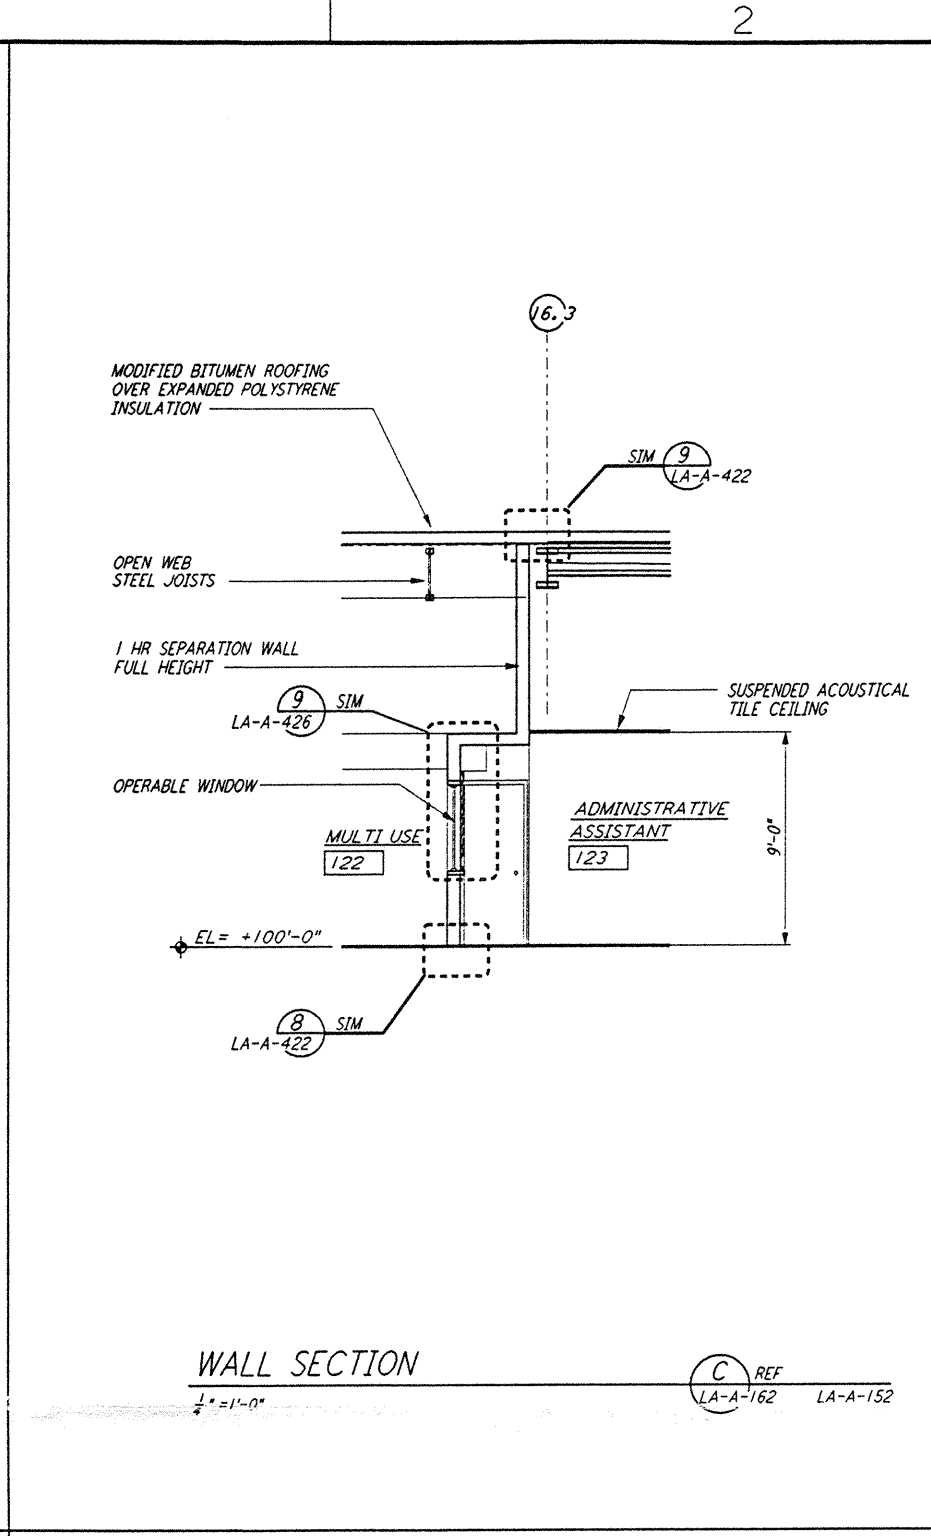
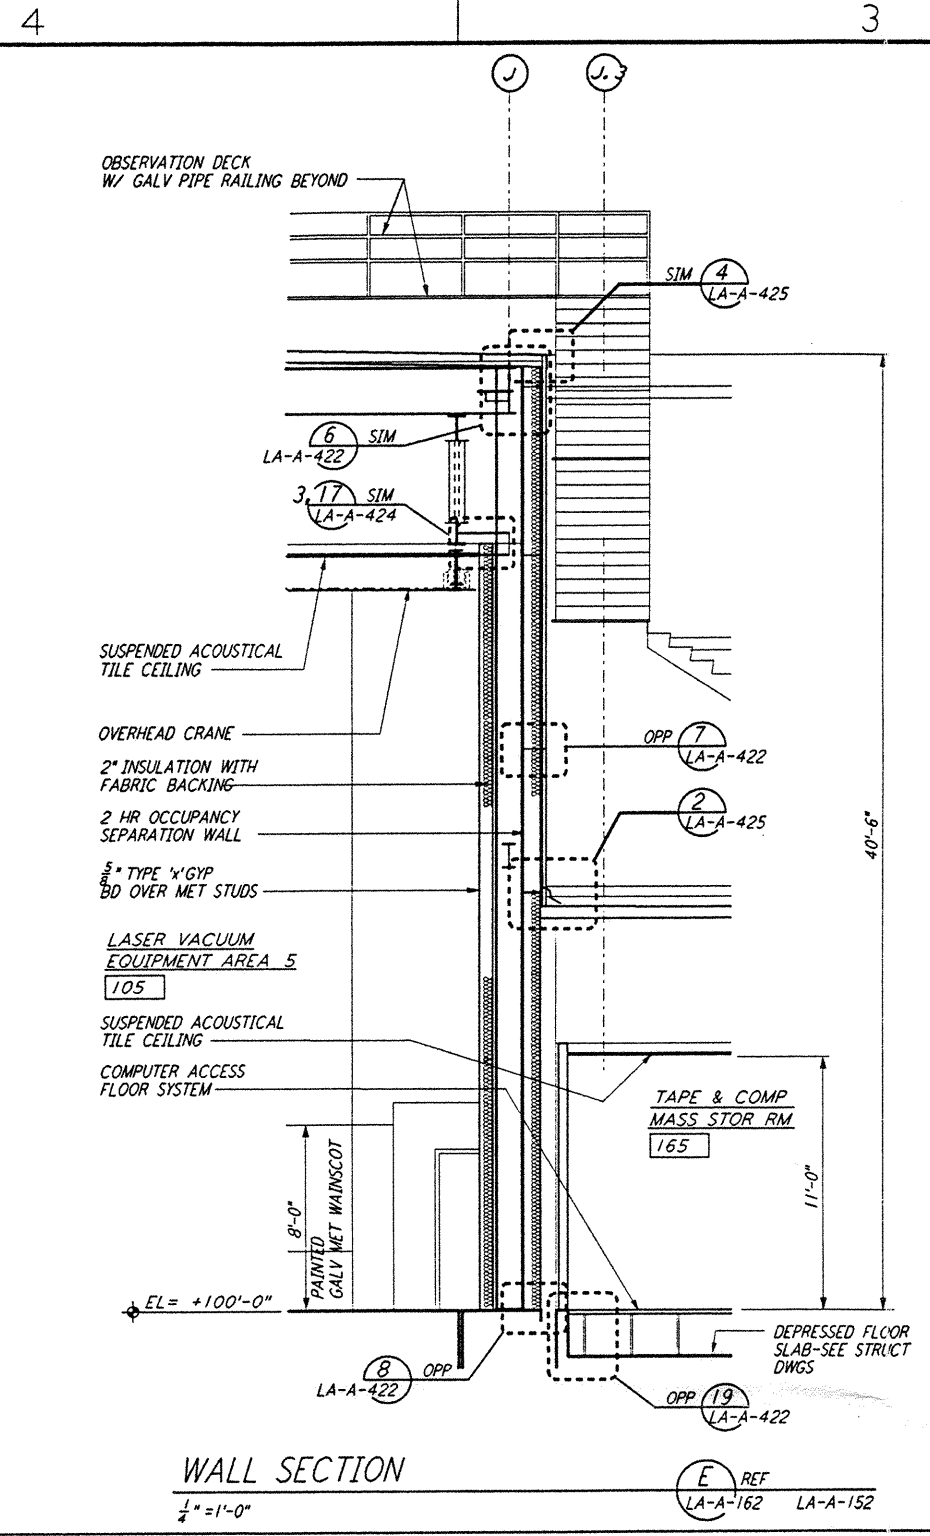



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NO.	DATE	BY	CHKD	ENGR	PROJ	DESCRIPTION

ISSUED FOR CONSTRUCTION	
DRAWN	CKT 11-15-96
CHECKED	TP 11-16-96
ENGINEER	SP 11-15-96
PROJ	SPM 11/15/96

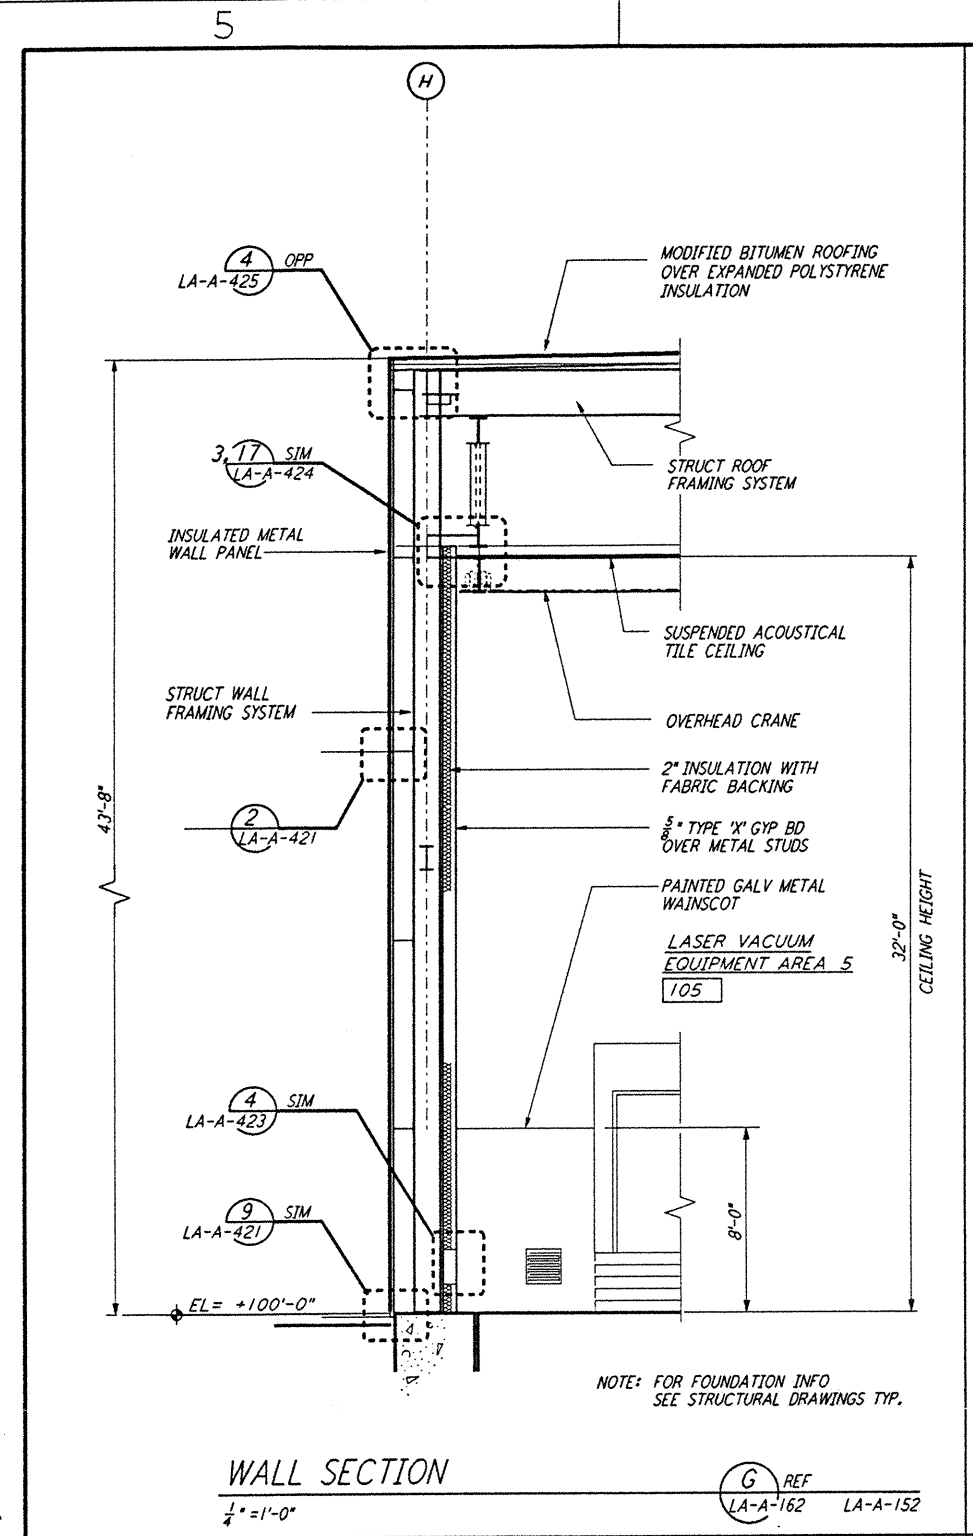

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LASER INTERFEROMETER
 GRAVITATIONAL-WAVE OBSERVATORY
 SITE NO. 2 - LIVINGSTON, LOUISIANA

TITLE: ARCHITECTURAL CORNER STATION WALL SECTIONS SHEET 2

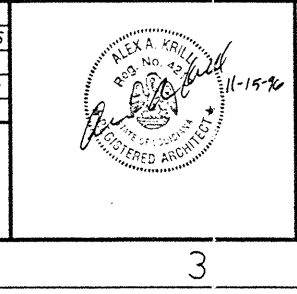PROJECT NUMBER: PPI 50969 8094

SHEET NUMBER: LA-A-162

SCALE: 1/4" = 1'-0"