
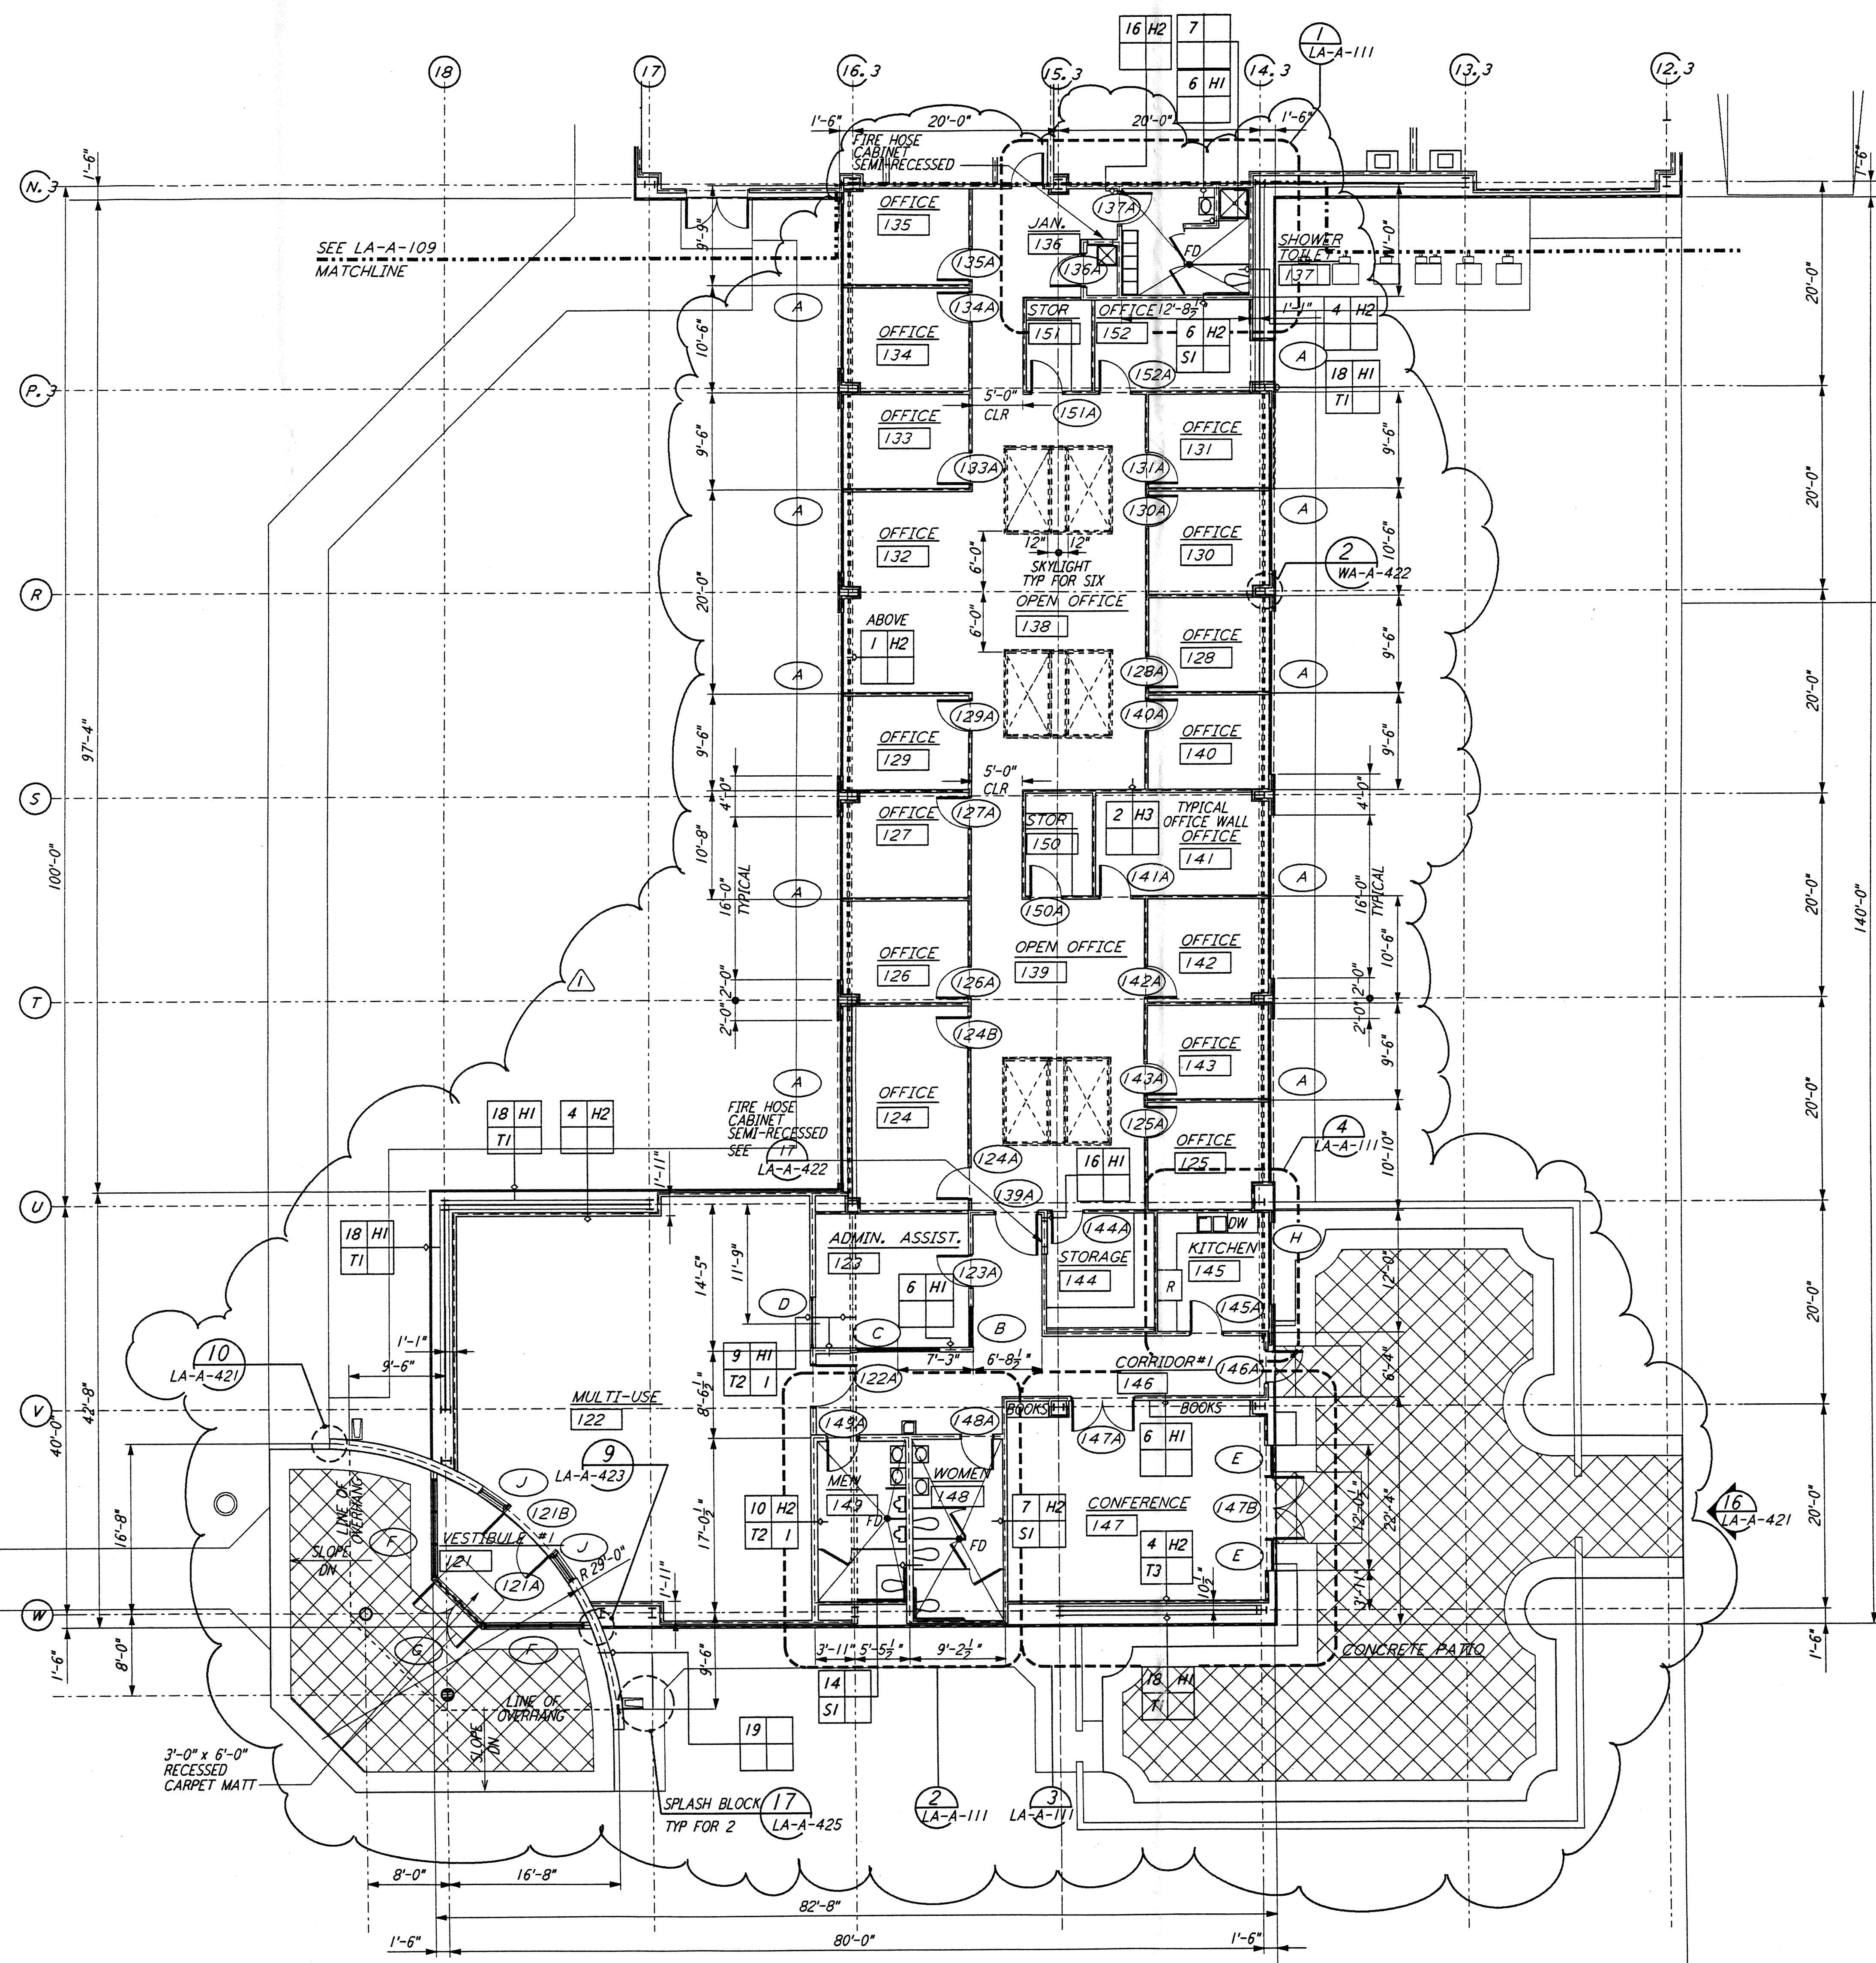
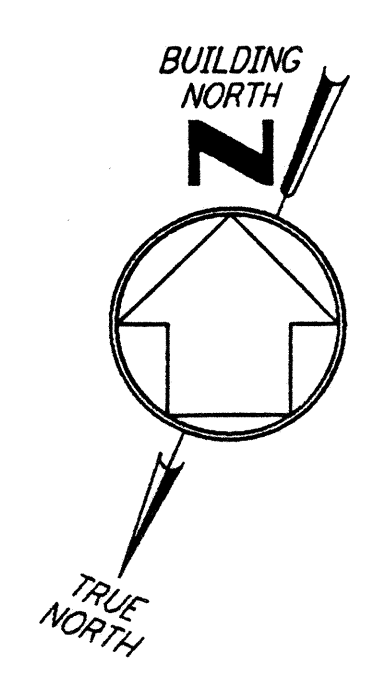


NOTE: SEE SPECIFICATIONS FOR ADDITIONAL INFORMATION AND SCHEDULES

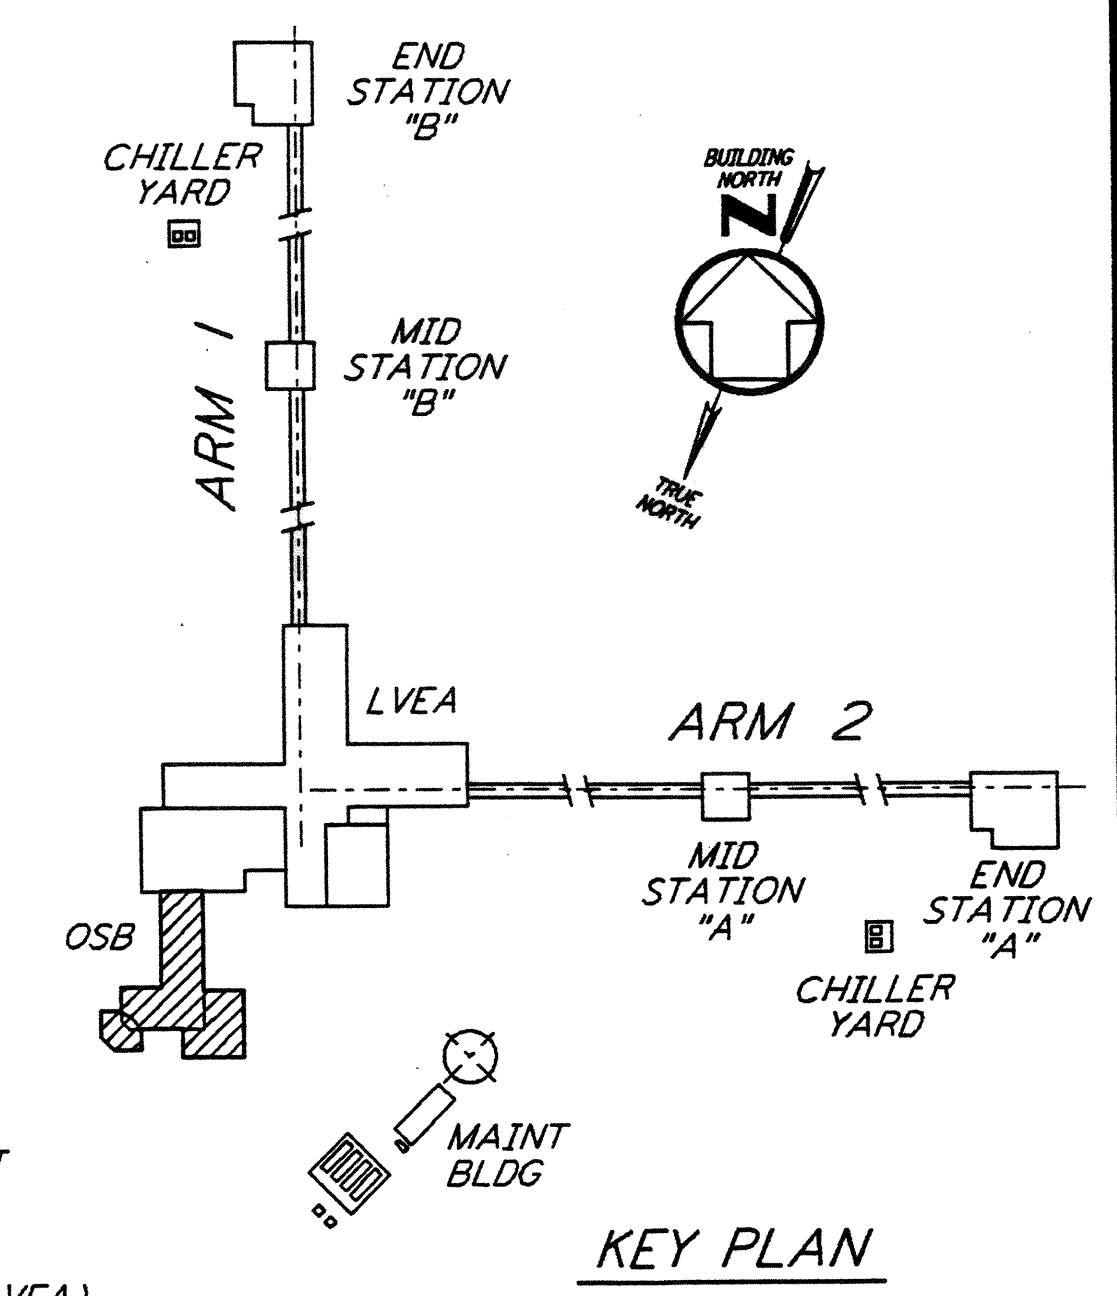

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LIGO-D960873-01-0
 0 8 16 24 32 FT
 1/8" = 1'-0"
 DATUM POINT EL +100.00 = 61.44' (LVEA)
 DATUM POINT EL +100.00 = 61.44' (OSB)

NO.	DATE	BY	CHKD	ENGR	PROJ	OSB REVISION	DESCRIPTION
1	2-28-97	CKT	TB	AK	TDM	OSB	REVISION

NO.	DATE	BY	CHKD	ENGR	PROJ	OSB REVISION	DESCRIPTION

NO.	DATE	BY	CHKD	ENGR	PROJ	OSB REVISION	DESCRIPTION

ISSUED FOR CONSTRUCTION
 DRAWN CKT 11-15-96
 CHECKED TB 11-15-96
 ENGINEER SF 11-15-96
 PROJ MDW 11-15-96

PARSONS
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LASER INTERFEROMETER
 GRAVITATIONAL-WAVE OBSERVATORY
 SITE NO. 2 - LIVINGSTON, LOUISIANA

ARCHITECTURAL
 CORNER STATION
 OSB PARTIAL FLOOR PLAN
 SHEET 1

SCALE AS NOTED
 CONTRACT NUMBER PP150969
 PROJECT NUMBER 8094
 SHEET NUMBER **LA-A-108**

10 MAR 11 14:52:28 1717 5372826 J:\VL\15\BULES\1\BDR\VIB001.PLT

10 MAR 11 14:52:28 1717 5372826 J:\VL\15\BULES\1\BDR\VIB001.PLT