



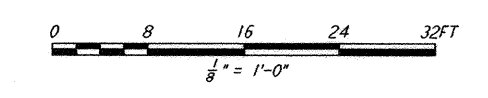

This document and the design it covers are the property of PARSONS. They are loaned only with the borrower's expressed written agreement that they will not be reproduced, copied, loaned, exhibited, or used in any other way, except by written consent from PARSONS to the borrower.

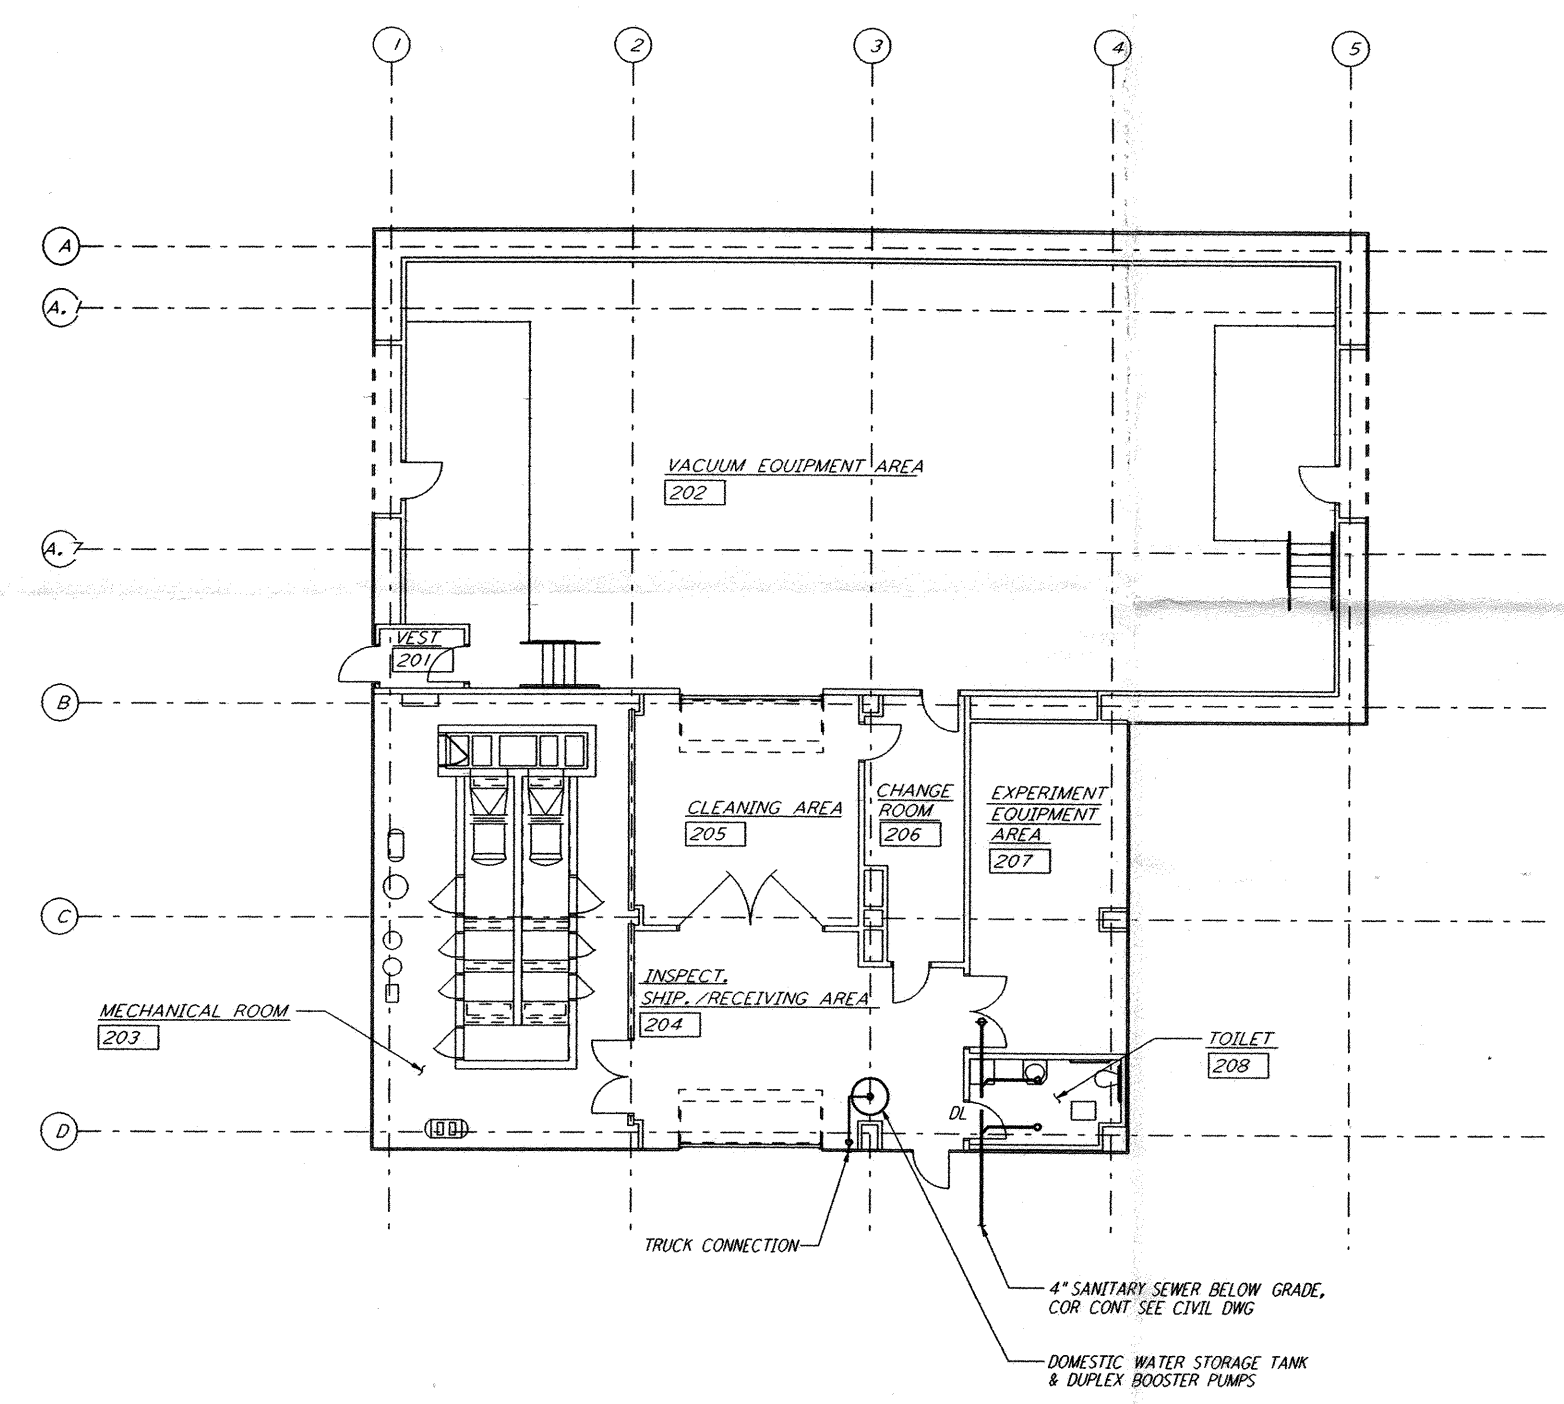

REVISION NO.	DATE	APRD BY	DESCRIPTION OF REVISION	ISSUE	DATE	APRD BY	DESCRIPTION OF REVISION
9				J	10/31/95	TDM	PRELIMINARY DESIGN REVIEW
8				H			
7				G			
6				F			
5				E			
4				D			
3				C			
2				B			
1				A			


PARSONS
 100 WEST WALNUT STREET
 PASADENA, CALIFORNIA


LIGO
 CALIFORNIA INSTITUTE OF TECHNOLOGY
 MASSACHUSETTS INSTITUTE OF TECHNOLOGY

LASER INTERFEROMETER
 GRAVITATIONAL-WAVE OBSERVATORY
 SITE NO. 1 - HANFORD, WASHINGTON
 TITLE: MID STATION FLOOR PLAN
 SCALE: AS NOTED
 CONTRACT NUMBER: PP150969
 PROJECT NUMBER: 8094
 SHEET NUMBER: **WA-P-211**

Mon Oct 30 21:36:27 1995 S3-VI8B2 J:\PLOTS\QUEUE\S3-VI8B2\MU211G.PRF