



- NOTES:**
- FOR LEGEND, ABBREVIATIONS AND GENERAL NOTES SEE SHEETS WA-H-001 AND WA-H-002.
 - SEE SHEET WA-H-511 FOR APPLICABLE NOTES AND LEGEND.

ROOM NAME	ROOM TEMPERATURE SETTING	
	MIN	MAX
LASER AREA-2	72	72
LASER AREA-5	72	72

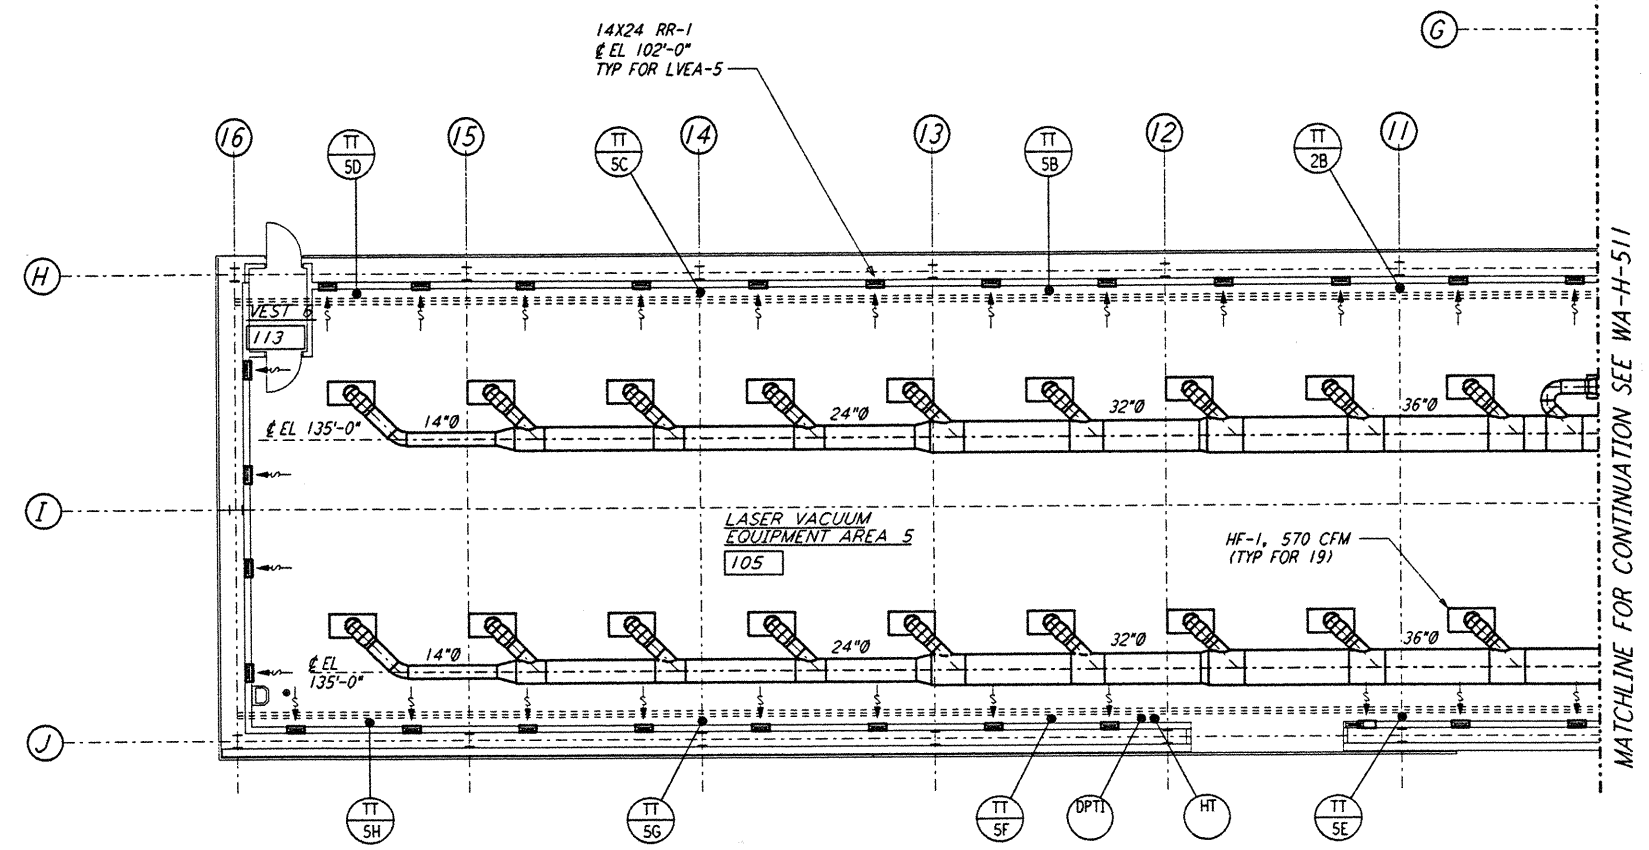

LVEA FLOOR PLAN
 1/8" = 1'-0"

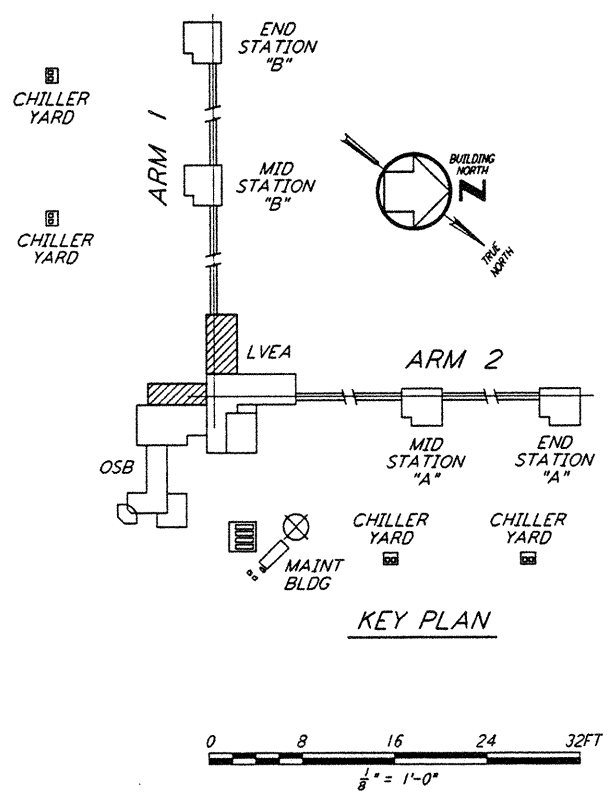

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NO.	DATE	BY	CHKD	ENGR	PROJ	DESCRIPTION

ISSUED FOR CONSTRUCTION
 DRAWN: CLP 6-24-96
 CHECKED: JPS 7/5/96
 ENGINEER: AA 7/1/96
 PROJ: WAF 7/1/96



PARSONS
 100 WEST WALNUT STREET
 PASADENA, CALIFORNIA

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 CALIFORNIA INSTITUTE OF TECHNOLOGY
 MASSACHUSETTS INSTITUTE OF TECHNOLOGY

LASER INTERFEROMETER
 GRAVITATIONAL-WAVE OBSERVATORY
 SITE NO. 1 - HANFORD, WASHINGTON

TITLE: HVAC CORNER STATION LVEA FLOOR PLAN SHEET 2
 SCALE: AS NOTED
 CONTRACT NUMBER: PPI50969
 PROJECT NUMBER: 8094
WA-H-512