




**AIR HANDLING UNIT STRUCTURE
 FOUNDATION PLAN**
 $\frac{3}{8}'' = 1'-0''$

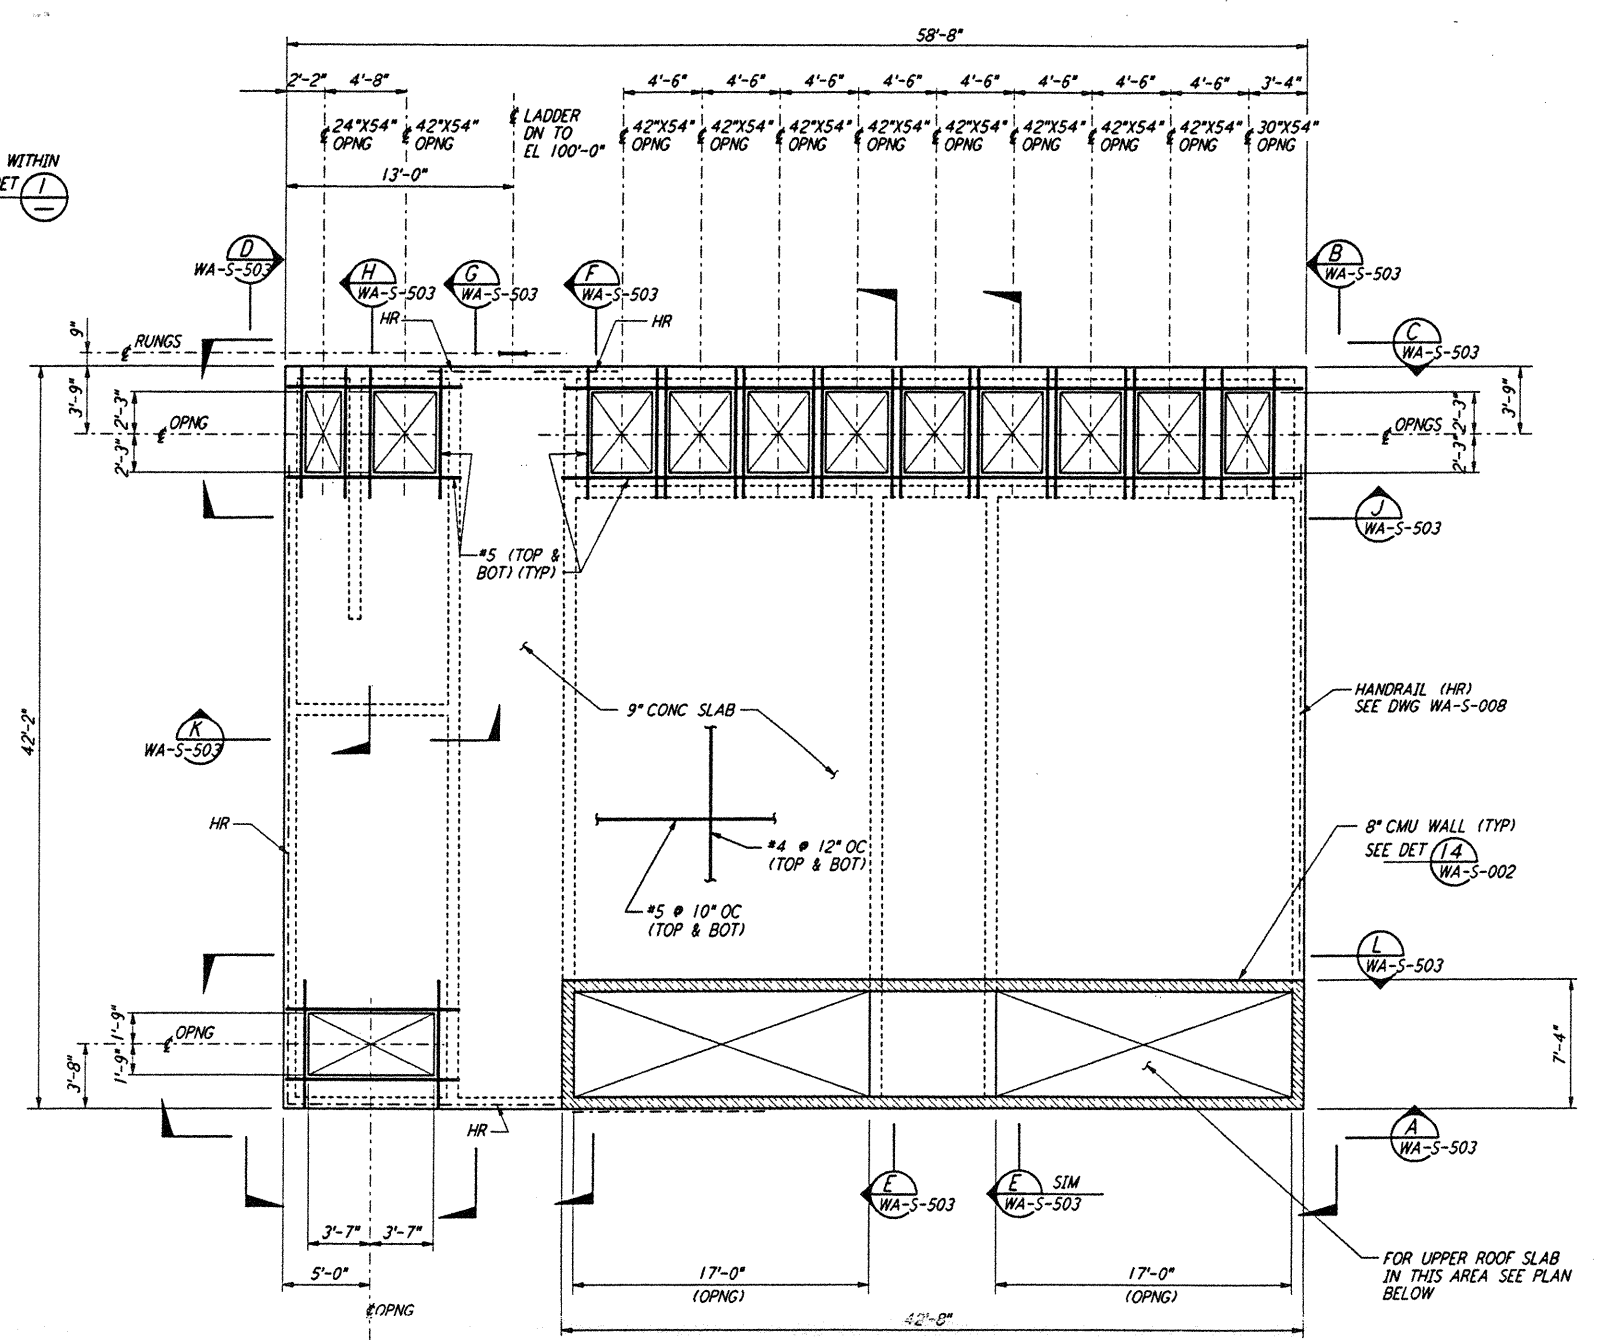

**AIR HANDLING UNIT STRUCTURE
 LOWER CONCRETE ROOF SLAB PLAN**
 $\frac{3}{8}'' = 1'-0''$
 TOC EL 110'-7"

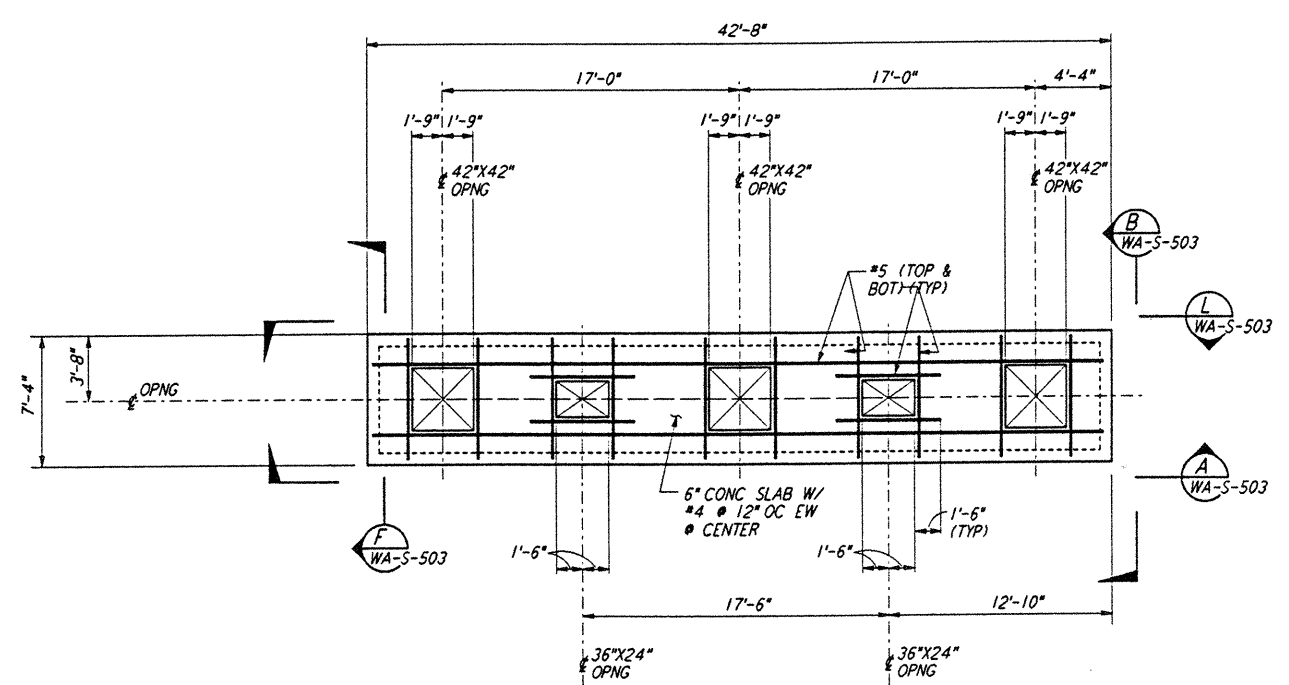


**AIR HANDLING UNIT STRUCTURE
 UPPER CONCRETE ROOF SLAB PLAN**
 $\frac{3}{8}'' = 1'-0''$
 TOC EL 115'-2"

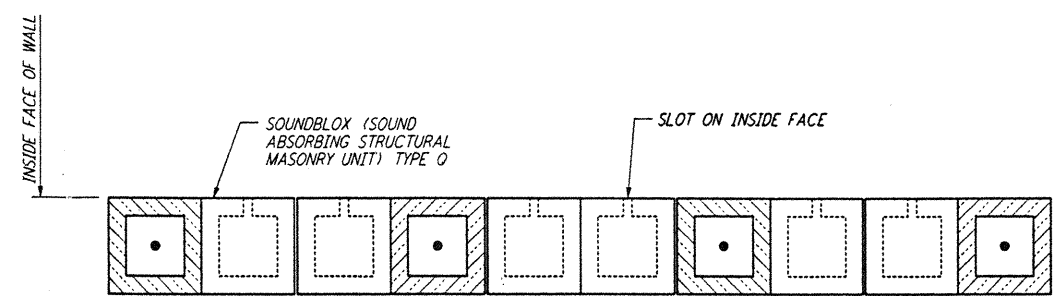

**TYPICAL SECTION OF SOUNDBLOX MASONRY WALL
 DETAIL (L)**
 $\frac{1}{2}'' = 1'-0''$

- NOTES:**
1. FOR GENERAL NOTES, ABBREVIATIONS & SYMBOLS SEE DRAWING WA-S-001.
 2. CONTRACTOR SHALL ADJUST LOCATION AND SIZE OF EQUIPMENT PADS TO SUIT VENDOR EQUIPMENTS.

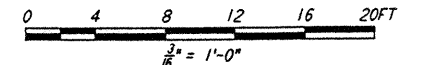


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NO.	DATE	BY	CHKD	ENGR	PROJ	DESCRIPTION

ISSUED FOR CONSTRUCTION
 DRAWN: MCS 6-24-96
 CHECKED: 7-1-96
 ENGINEER: 7/4 4-28-96
 PROJ: 11000 7/19/96



PARSONS
 100 WEST WALNUT STREET
 PASADENA, CALIFORNIA

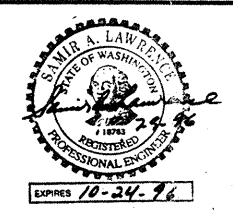LIGO
 CALIFORNIA INSTITUTE OF TECHNOLOGY
 MASSACHUSETTS INSTITUTE OF TECHNOLOGY

LASER INTERFEROMETER
 GRAVITATIONAL-WAVE OBSERVATORY
 SITE NO. 1 - HANFORD, WASHINGTON
 TITLE: **STRUCTURAL CORNER STATION AIR HANDLING UNIT ENCLOSURE PLAN**
 SCALE: AS NOTED
 SHEET NUMBER: **PP150969 8094**
 PROJECT NUMBER: **WA-S-502**