




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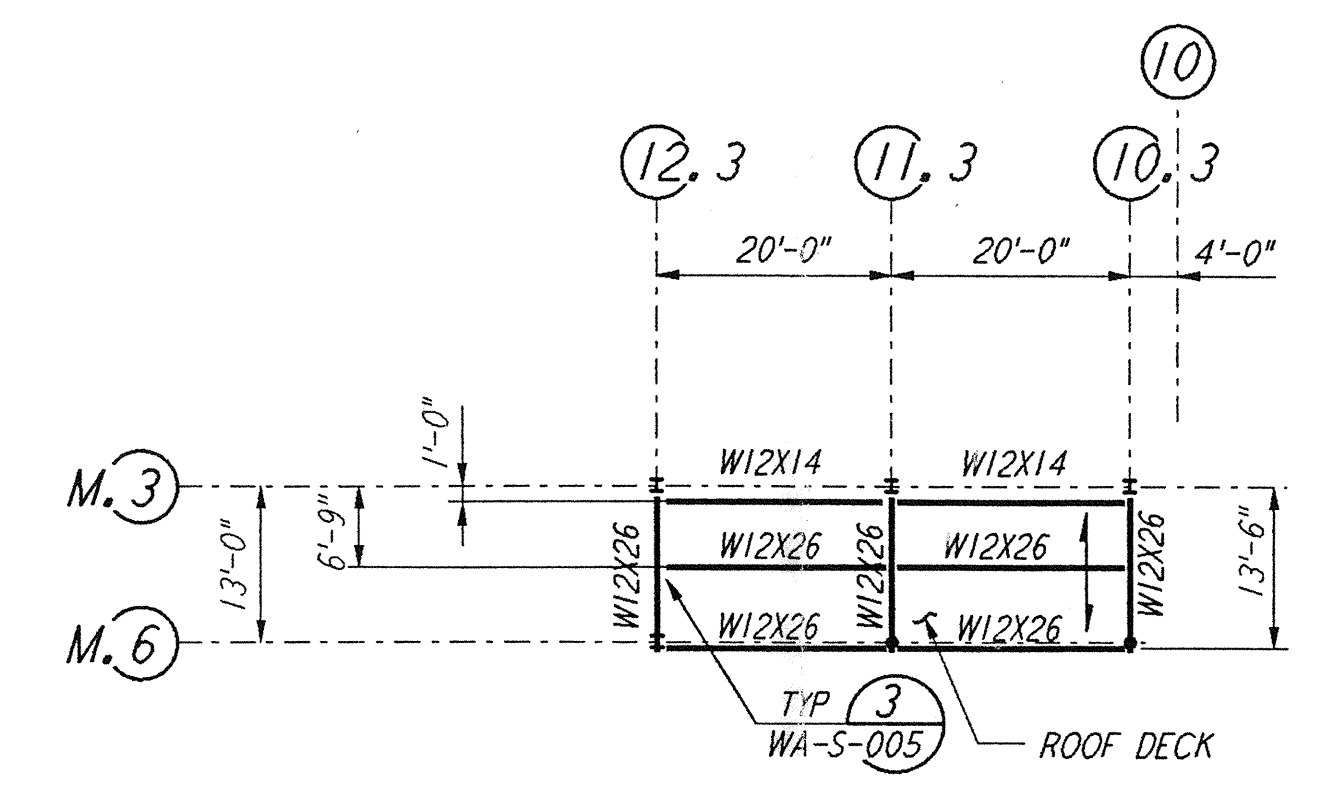
LOW ROOF FRAMING PLAN
 $\frac{1}{16}'' = 1'-0''$

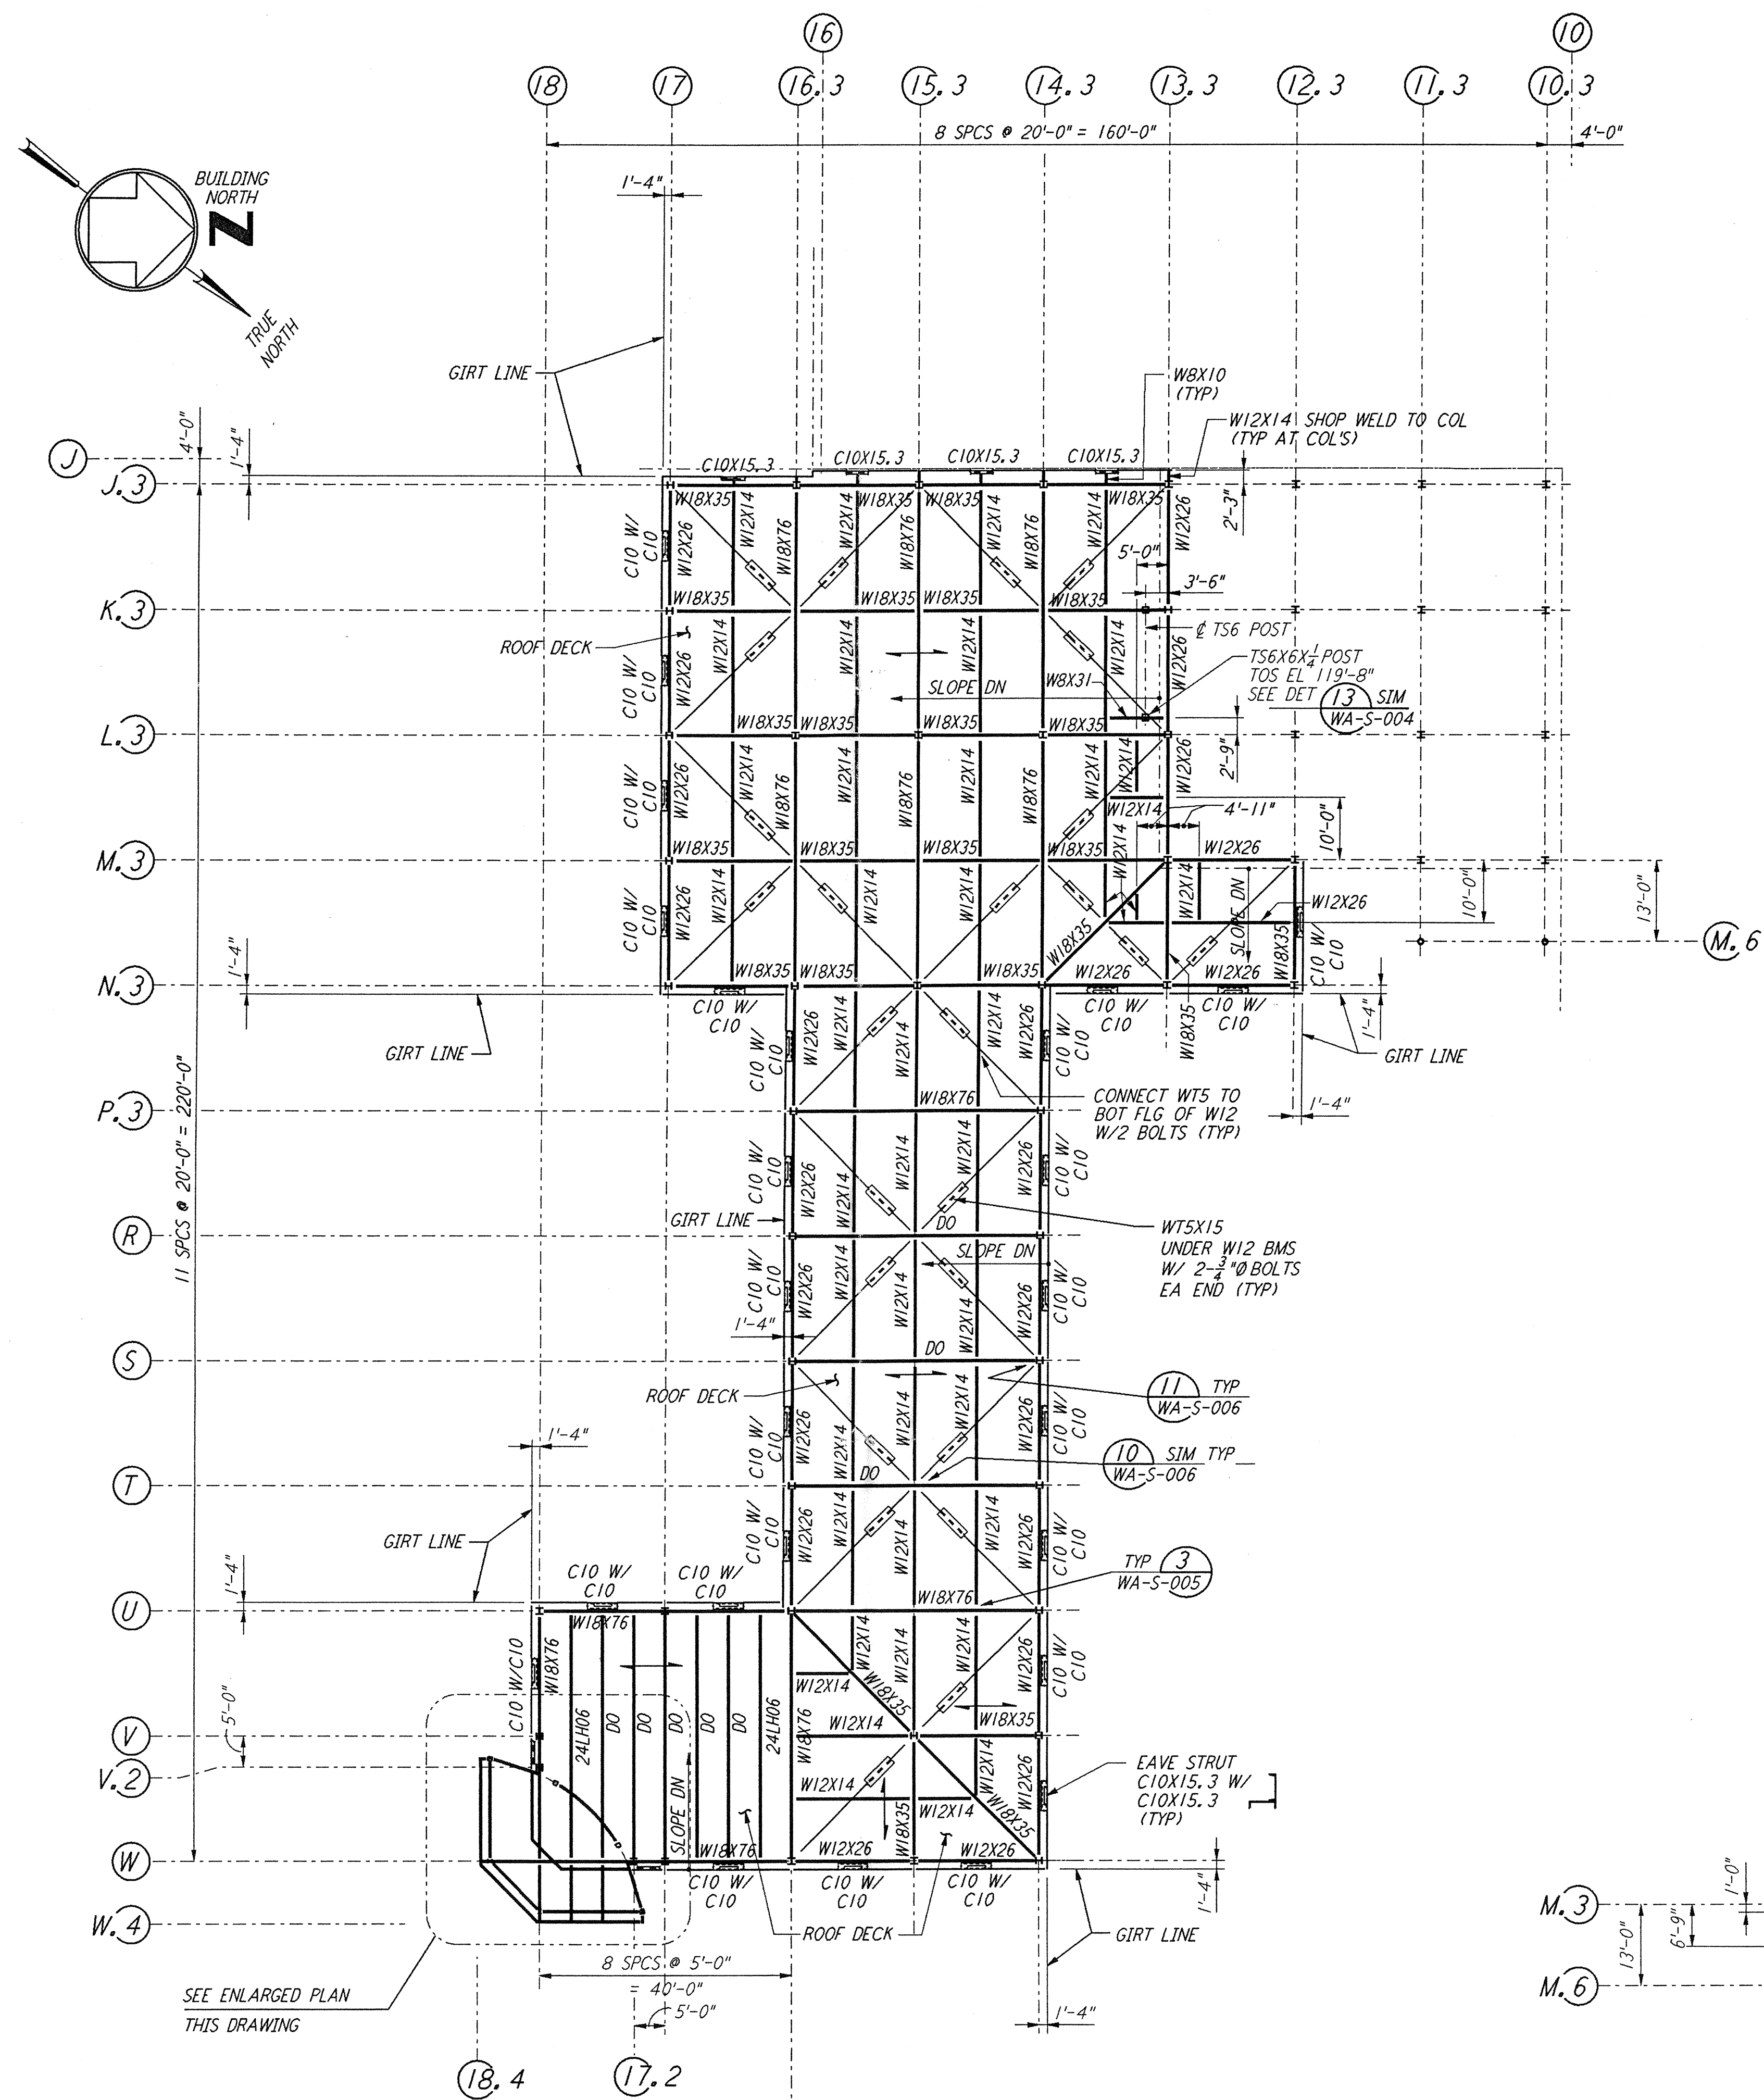


HIGH ROOF FRAMING PLAN
 $\frac{1}{16}'' = 1'-0''$

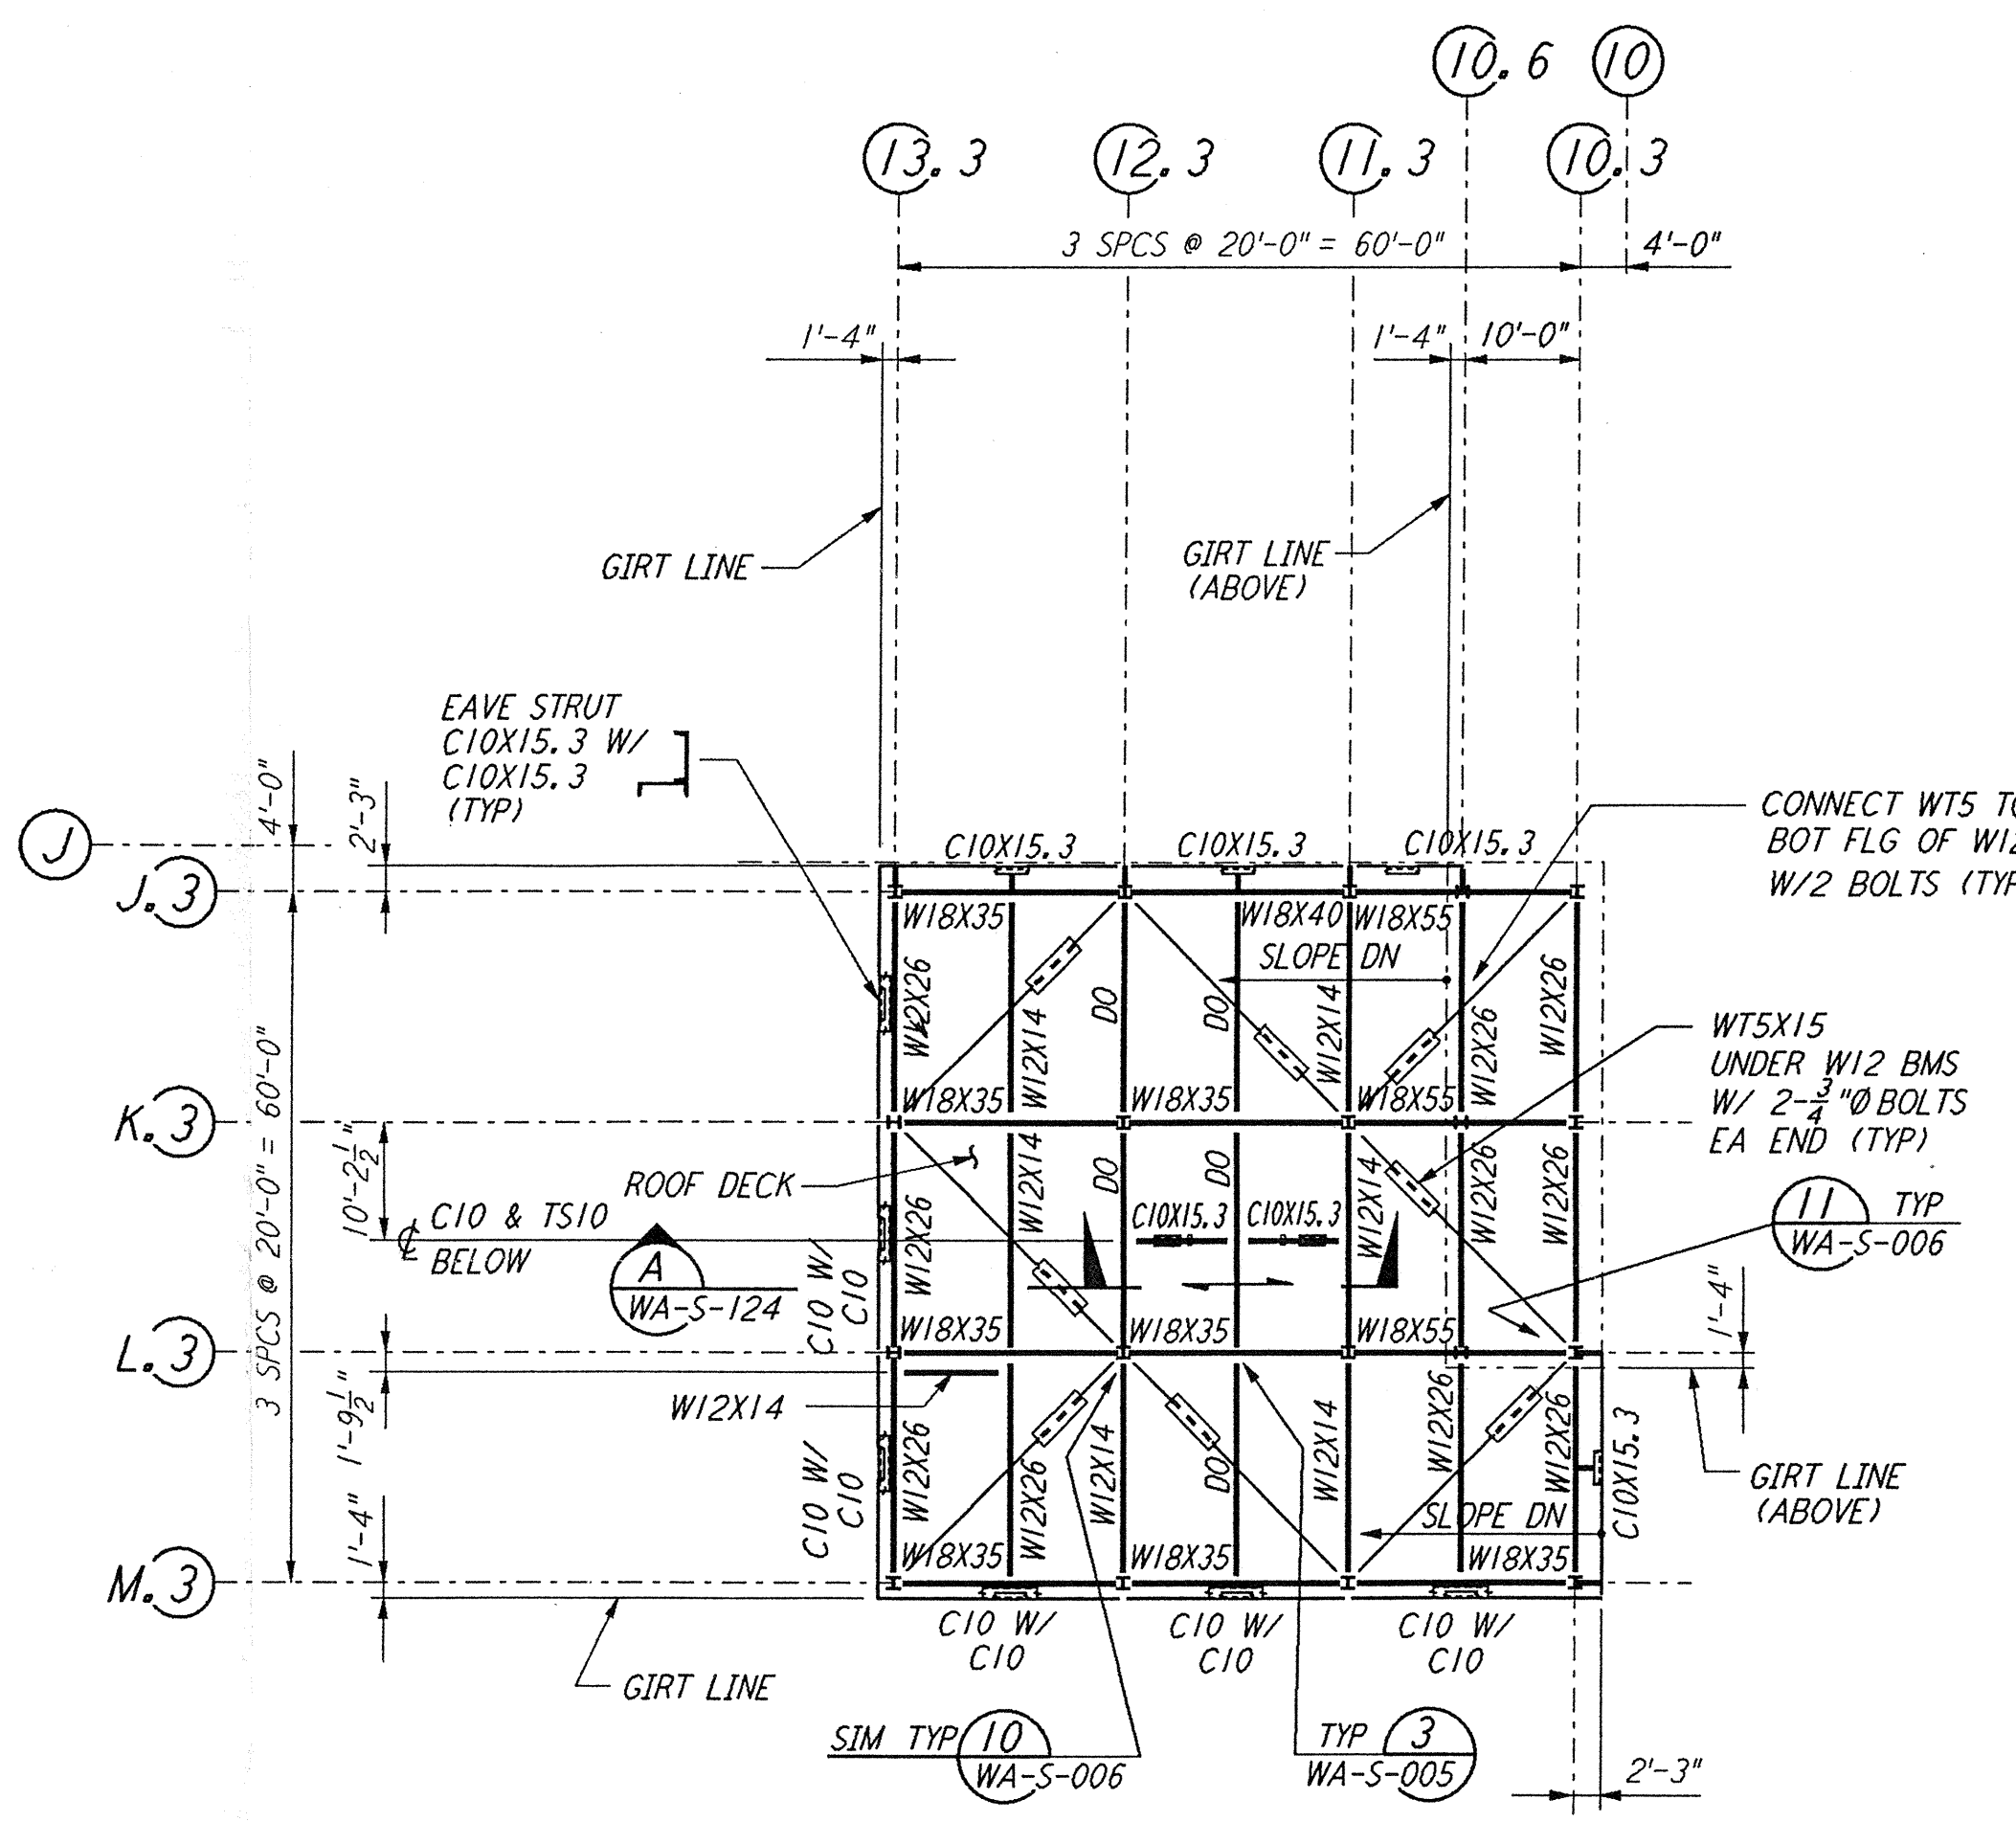

DUCT ENCLOSURE ROOF PLAN
 $\frac{1}{16}'' = 1'-0''$

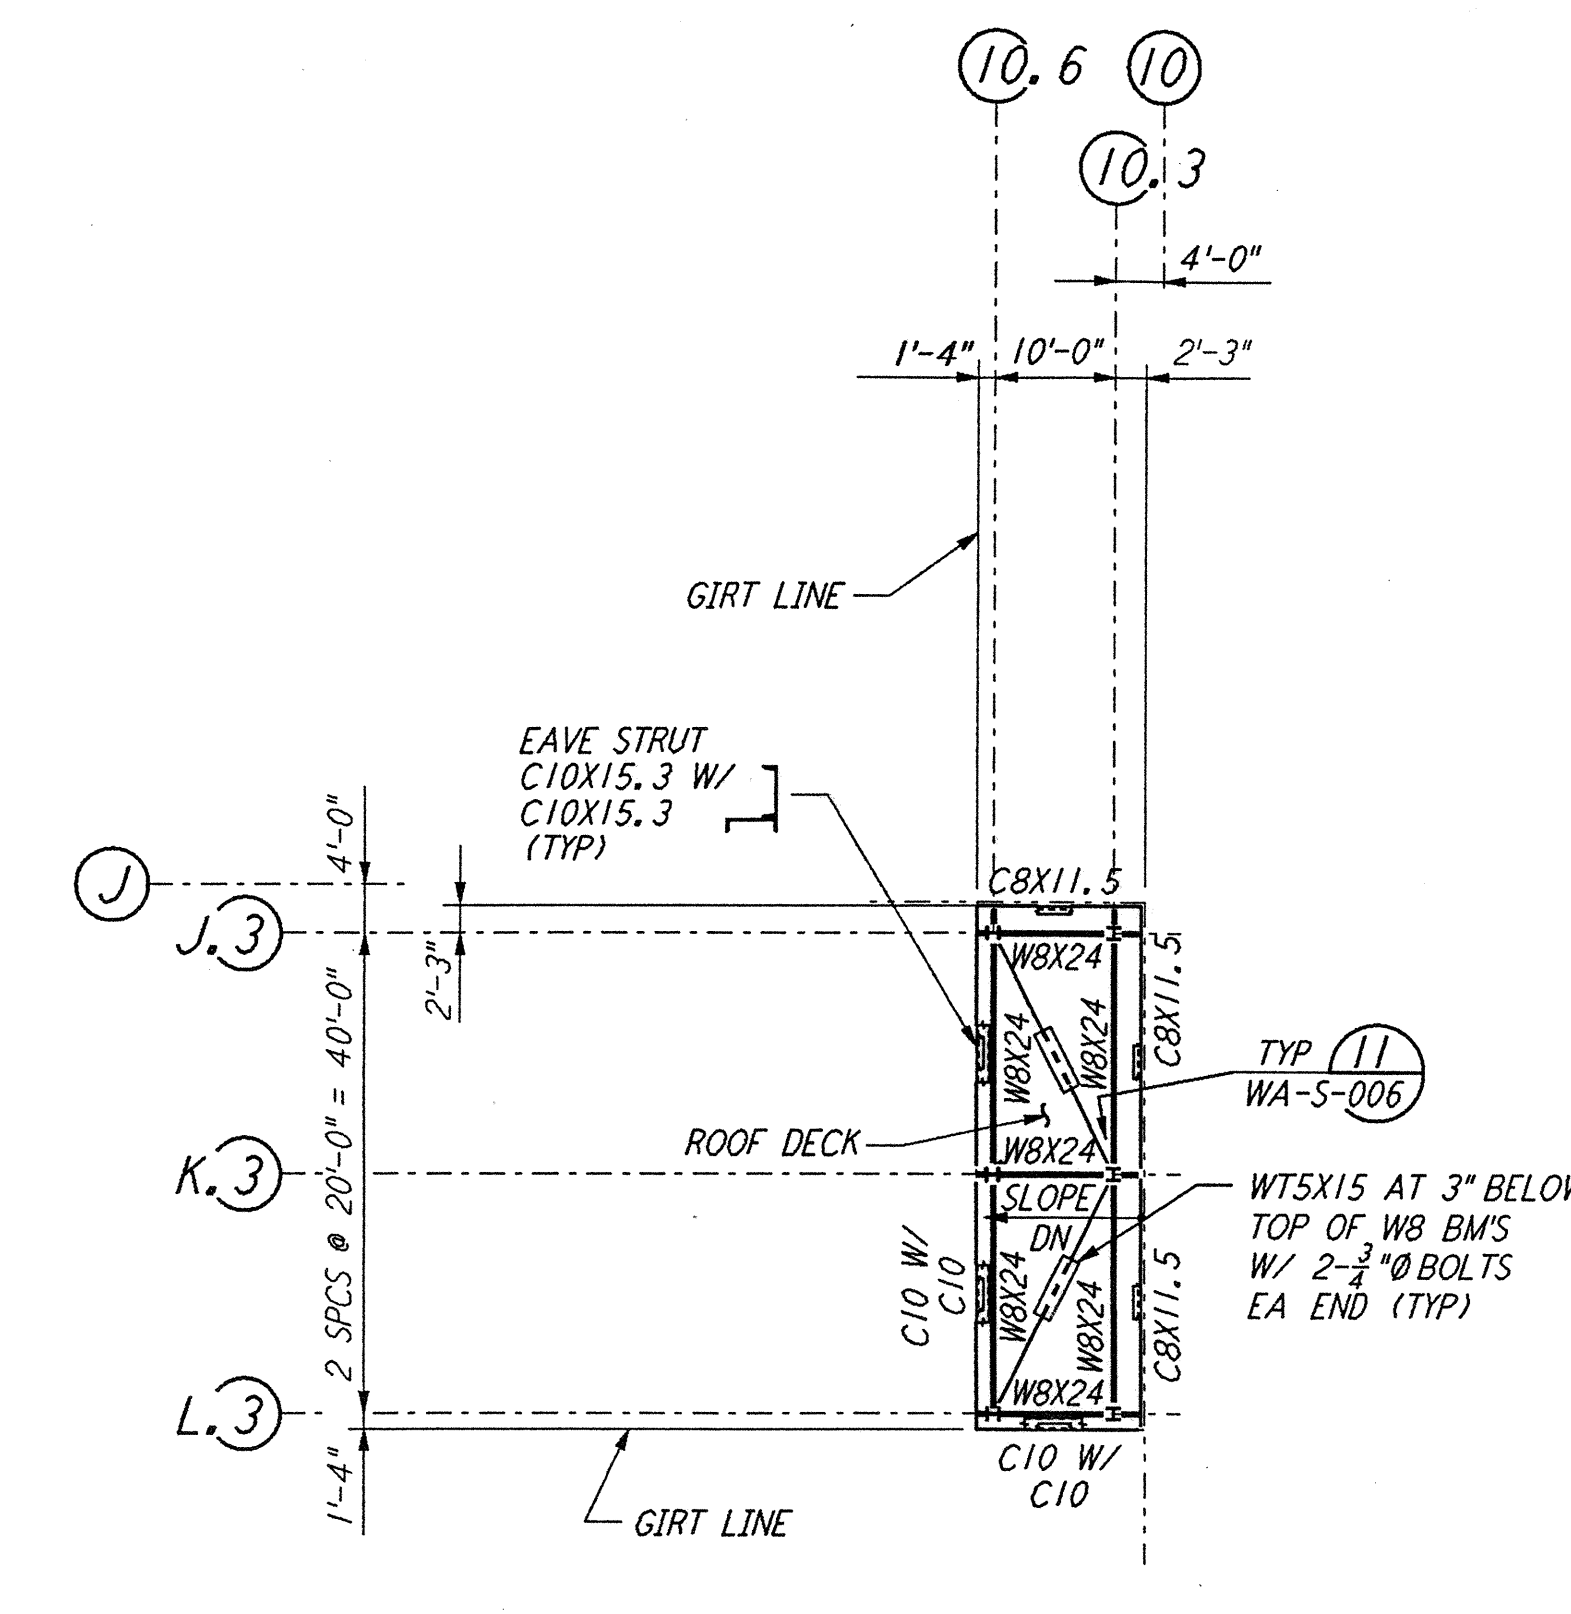


CANOPY FRAMING PLAN
 $\frac{1}{16}'' = 1'-0''$

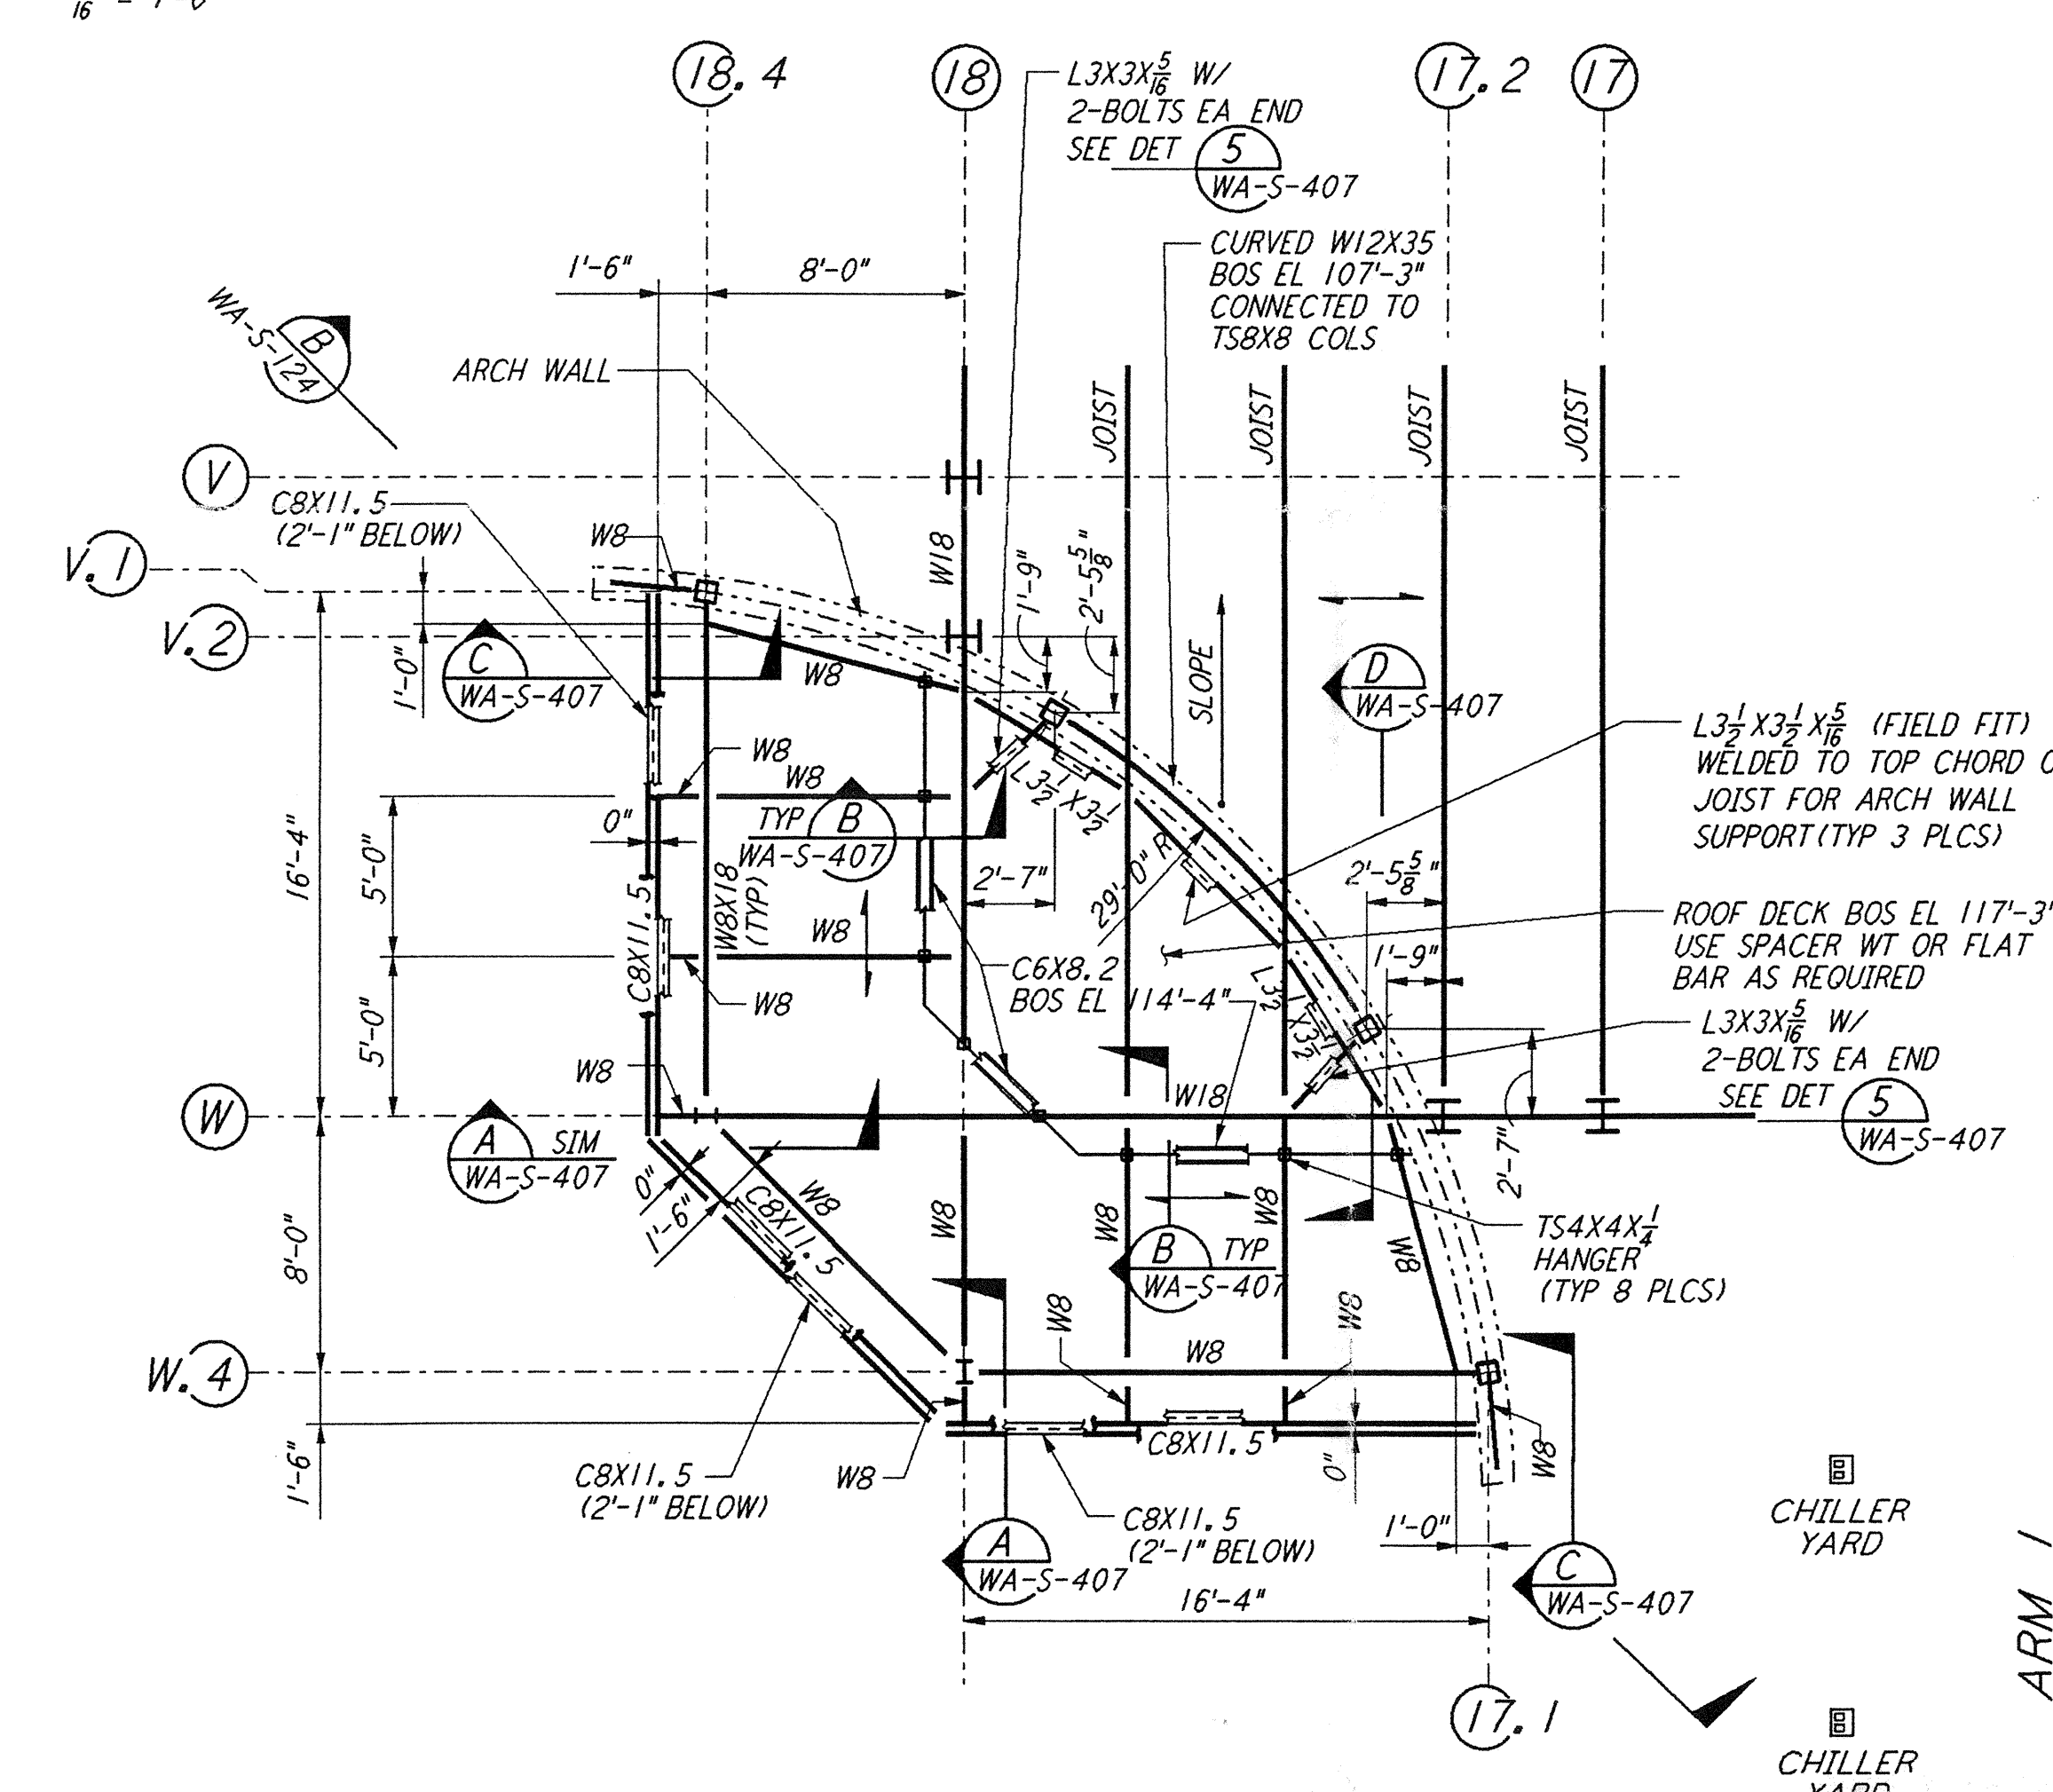


ENLARGED FRAMING PLAN
 $\frac{3}{16}'' = 1'-0''$

NOTE:
 1. FOR STRUCTURAL GENERAL NOTES, ABBREVIATIONS AND LEGEND, SEE DWG WA-S-001.

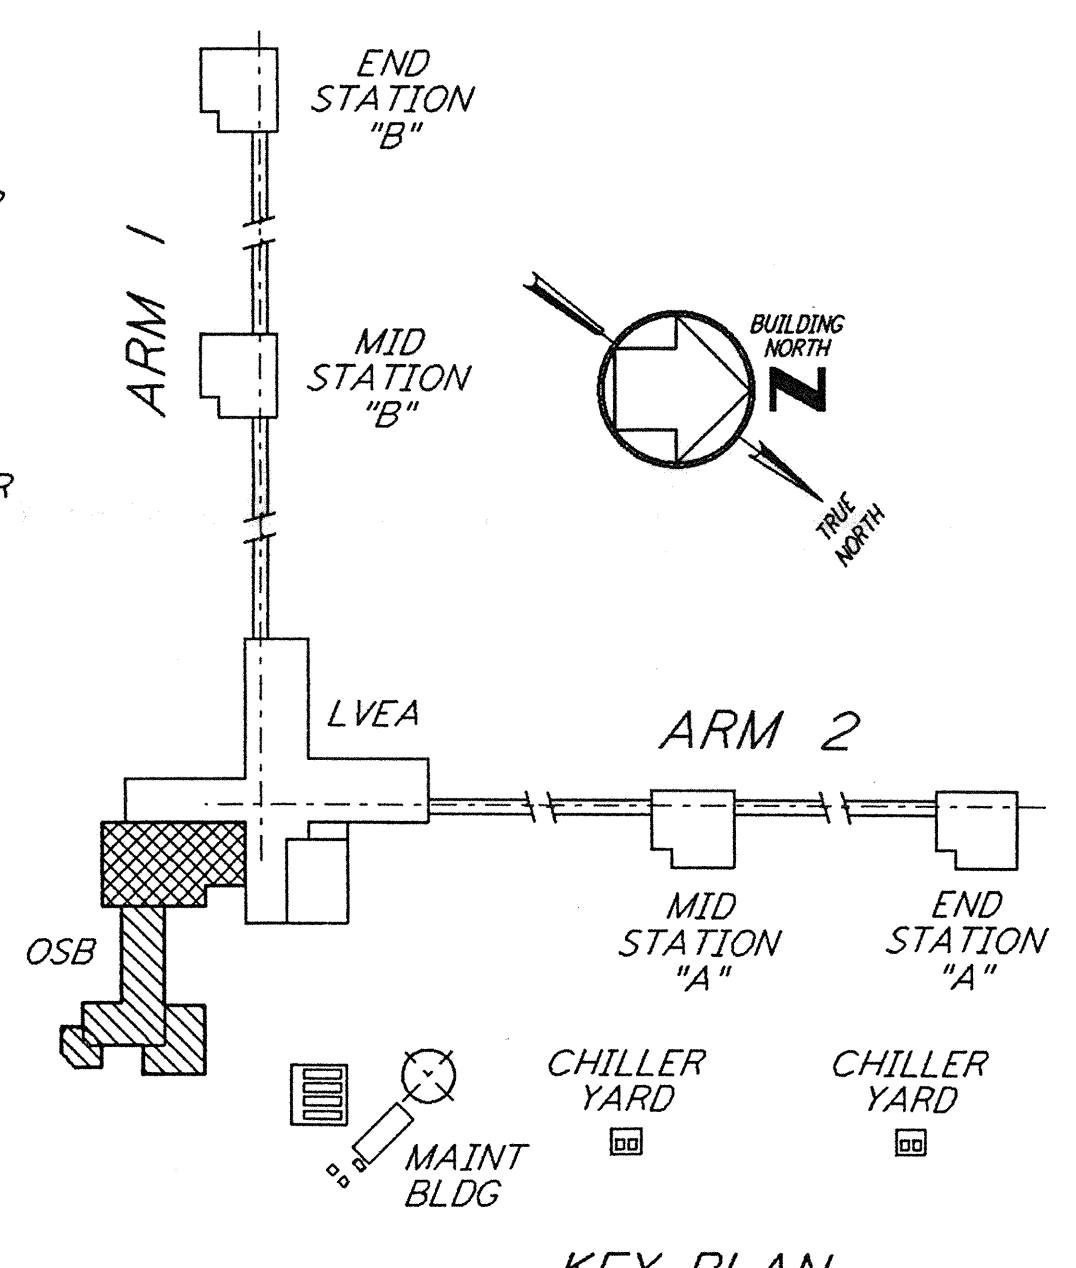

KEY PLAN

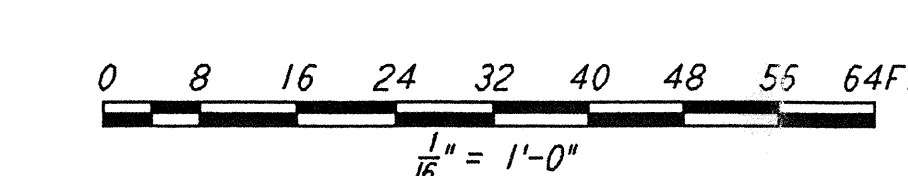

NO.	DATE	BY	CHKD	ENGR	PROJ	DESCRIPTION
B	4-19-96	MCS	bbj			FINAL DESIGN REVIEW & BID
A	10-31-95					PRELIMINARY DESIGN REVIEW

NO.	DATE	BY	CHKD	ENGR	PROJ	DESCRIPTION

DRAWN	MCS
CHECKED	
ENGINEER	
PROJ	

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 GRAVITATIONAL-WAVE OBSERVATORY
 SITE NO. 1 - HANFORD, WASHINGTON

STRUCTURAL CORNER STATION OSB ROOF FRAMING PLANS

SCALE: AS NOTED
 CONTRACT NUMBER: PP150969
 PROJECT NUMBER: 8094

SHEET NUMBER: **WA-S-117**