

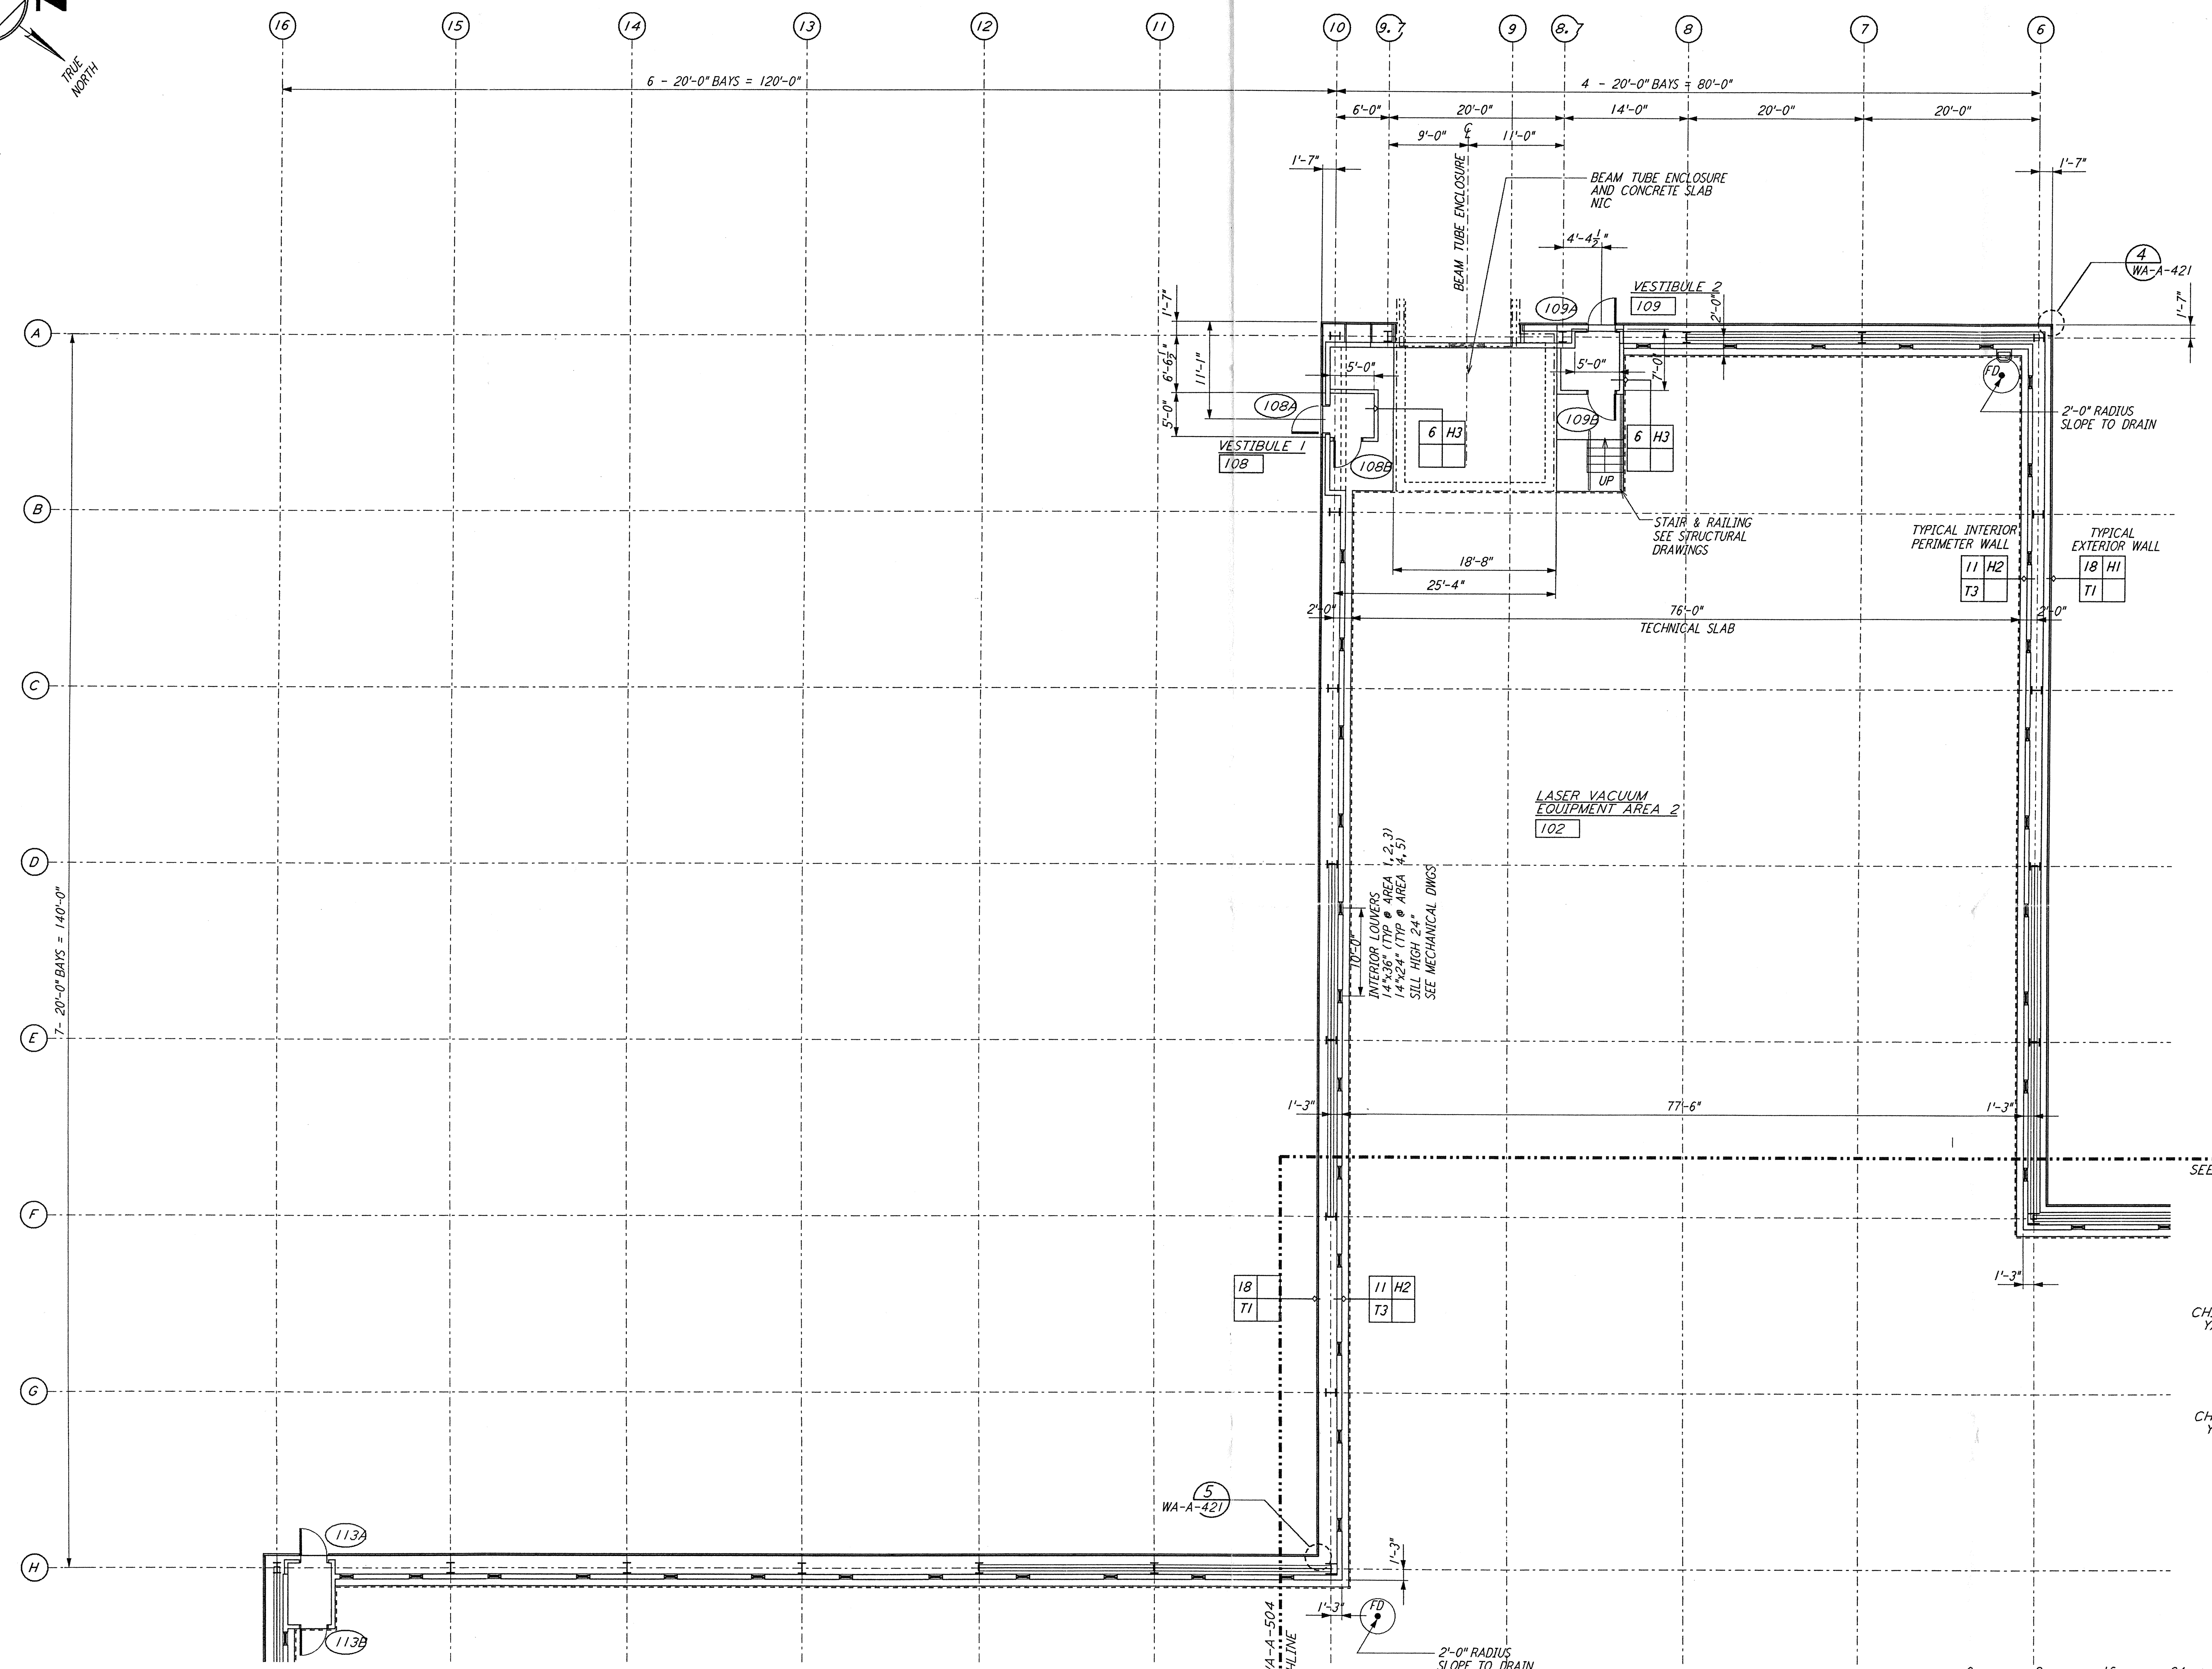


NOTE: SEE SPECIFICATIONS FOR ADDITIONAL INFORMATION AND SCHEDULES

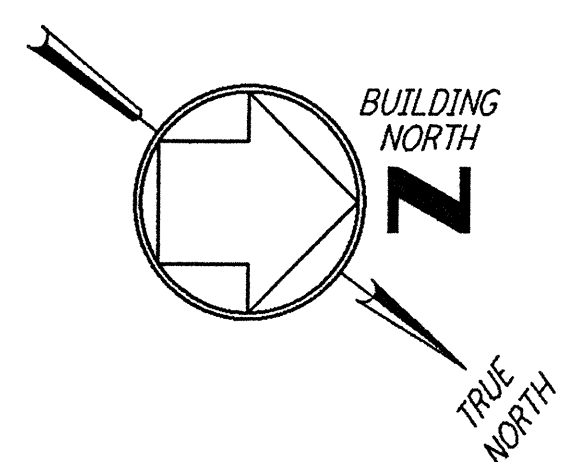

Date Received: 4/19/96	LIGO: 0960275-A-0
TRM #: 23	Contractor: WA-A-503, 664-A
Date: 4/19/96	Approved:
TRM #:	LIGO:
Date: / /	Approved:
Client Transmittal:	LIGO:
Date: / /	Approved:

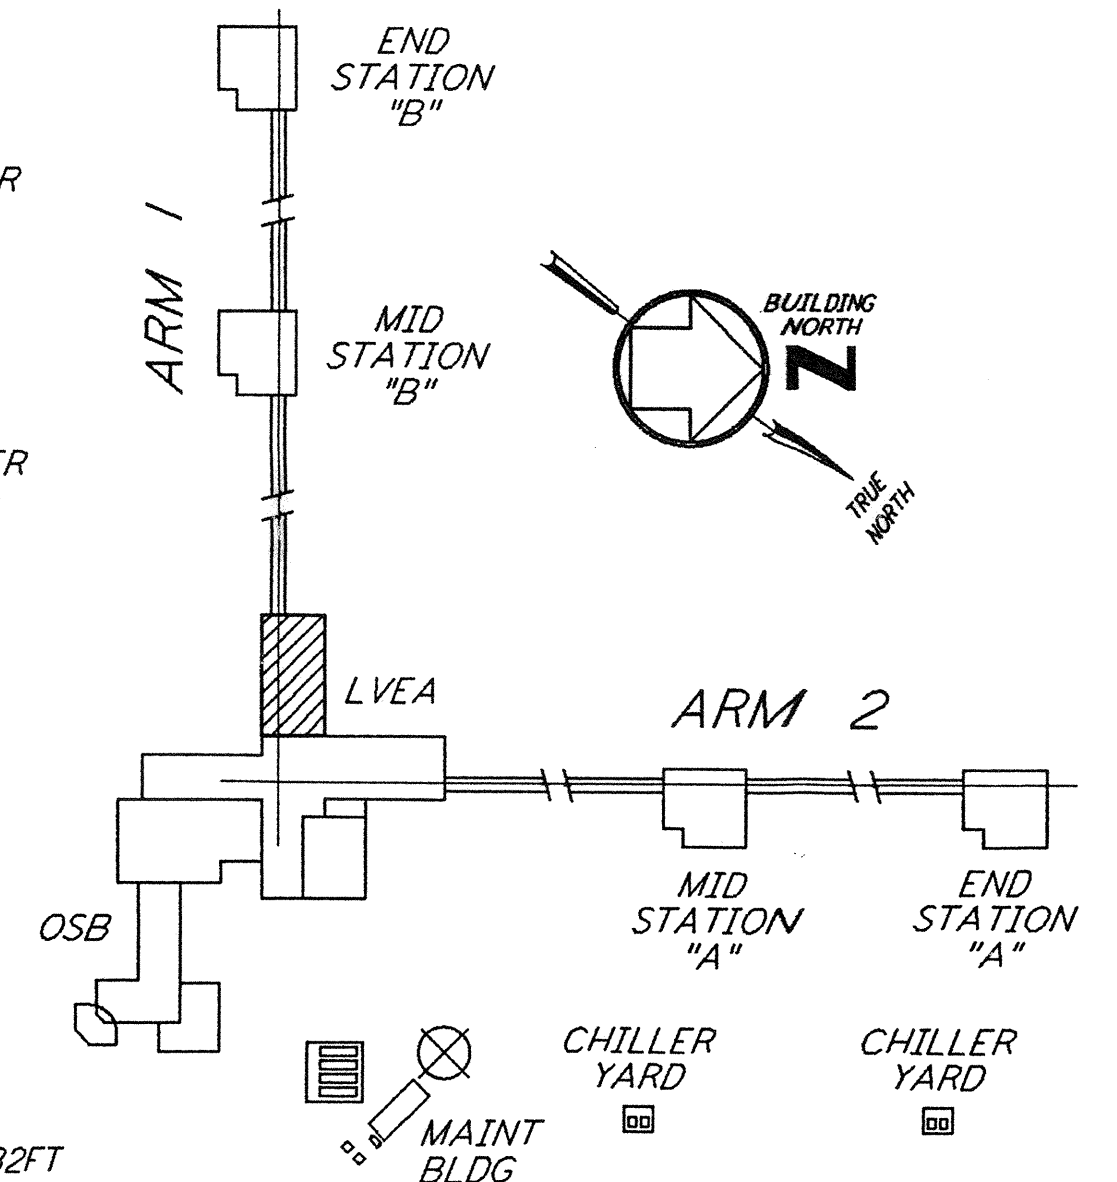

0 8 16 24 32 FT
 1/8" = 1'-0"
 DATUM POINT EL +100.00 = 531.11' (LVEA)
 DATUM POINT EL +100.00 = 531.11' (OSB)

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REFERENCES	REVISIONS	APPROVALS
DRAWING NO.	NO.	DATE
DESCRIPTION	BY	DATE
	CHKD	ENGR
	ENGR	PROJ
	DATE	DESCRIPTION
A	4-19-96	SF SF SF DM FINAL DESIGN REVIEW & BID

DRAWN	CKT/DS
CHECKED	
ENGINEER	
PROJ	

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 PASADENA, CALIFORNIA

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 MASSACHUSETTS INSTITUTE OF TECHNOLOGY

LASER INTERFEROMETER
 GRAVITATIONAL-WAVE OBSERVATORY
 SITE NO. 1 - HANFORD, WASHINGTON

TITLE: ARCHITECTURAL CORNER STATION LVEA PARTIAL FLOOR PLAN SHEET 2

AS NOTED CONTRACT NUMBER: PPI50969 PROJECT NUMBER: 8094

SHEET NUMBER: WA-A-503 REVISIONS: A