
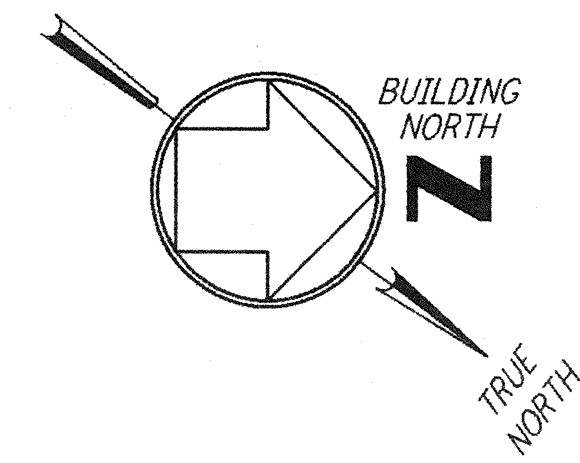
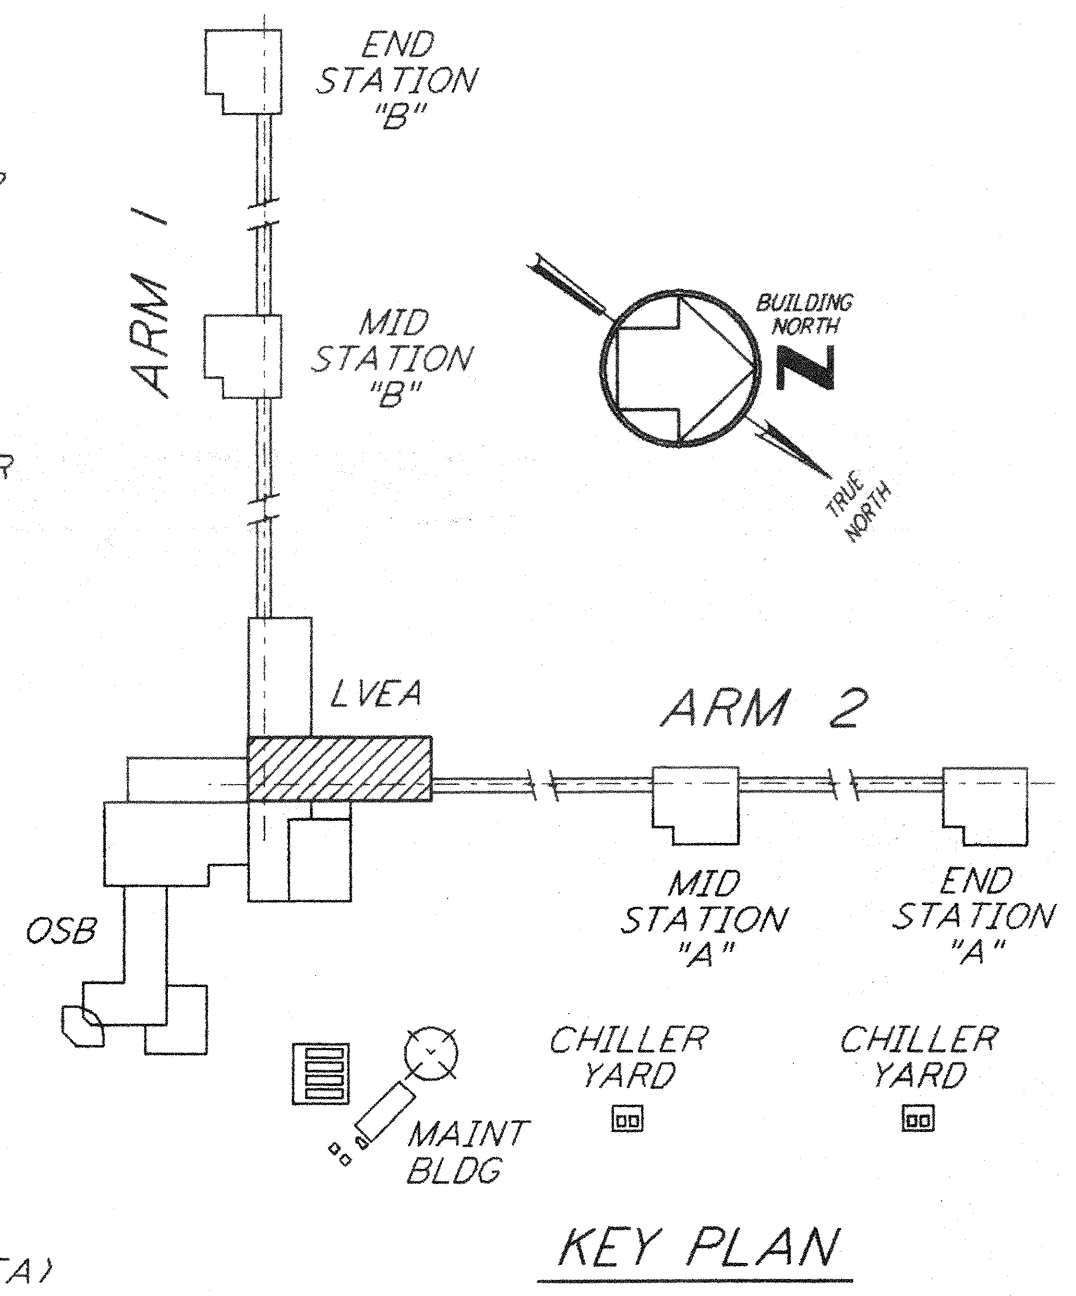


NOTE: SEE SPECIFICATIONS FOR ADDITIONAL INFORMATION AND SCHEDULES

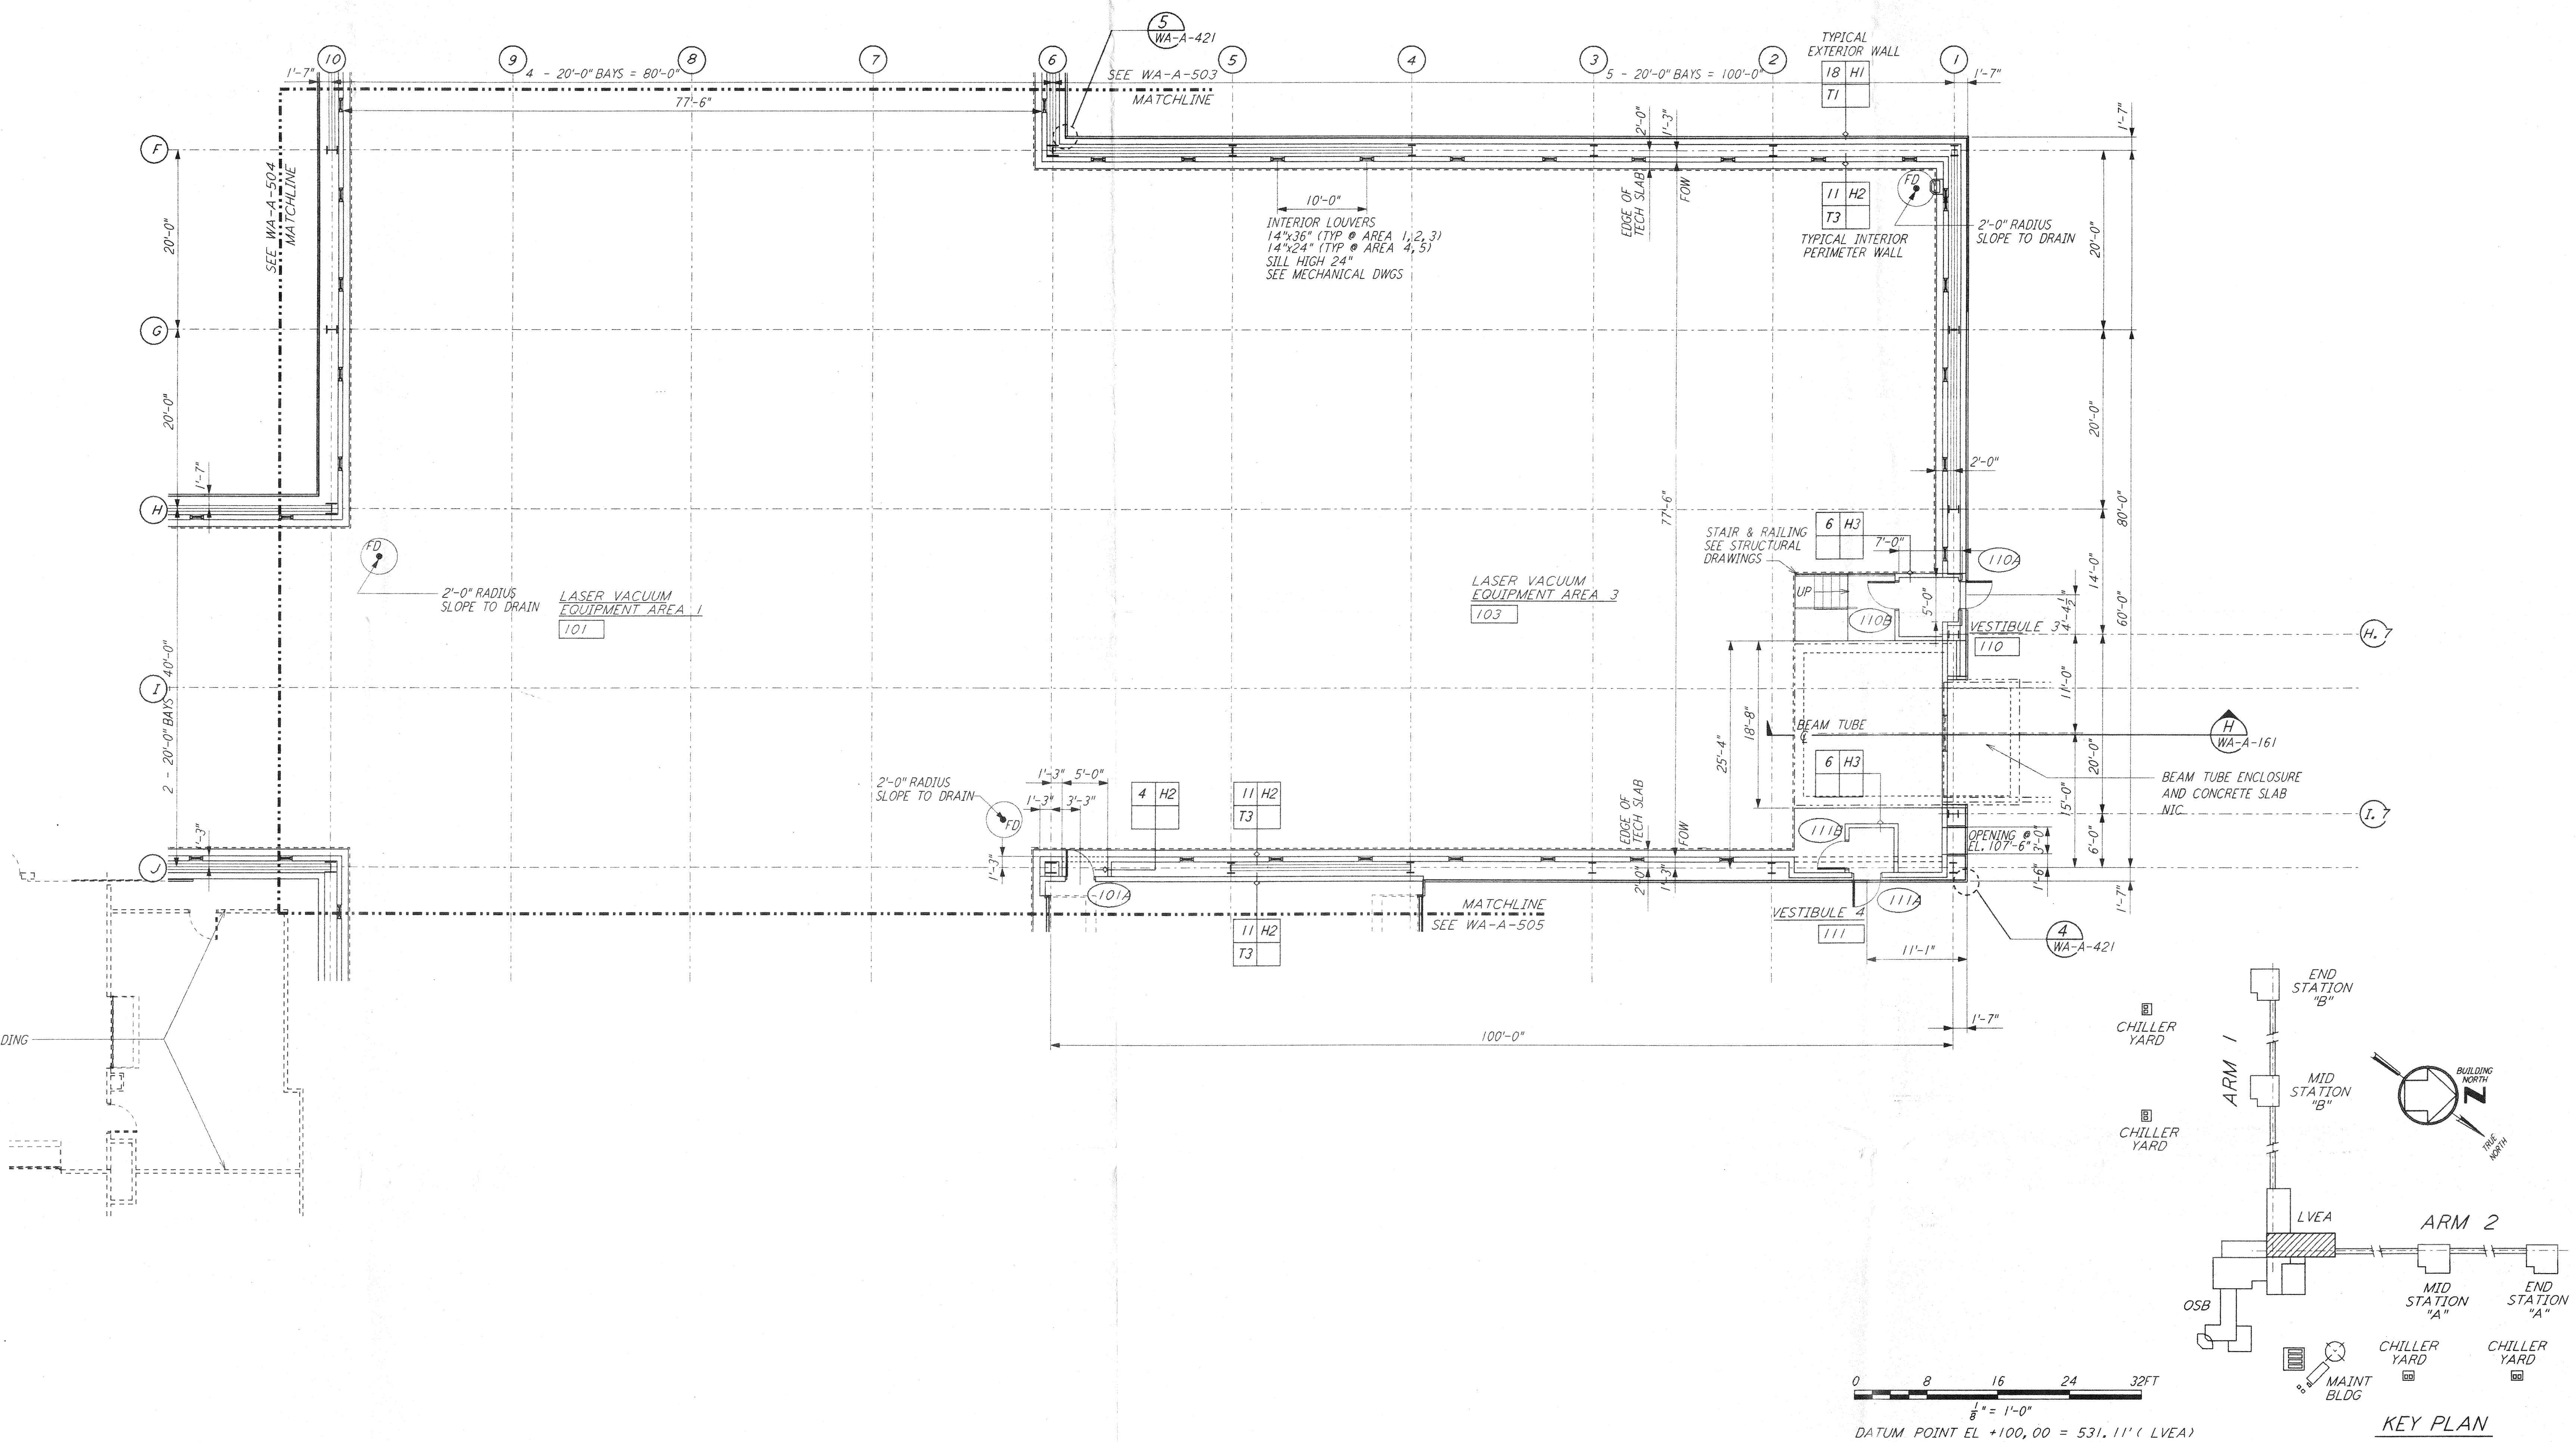

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0 8 16 24 32 FT
 1/8" = 1'-0"
 DATUM POINT EL +100.00 = 531.11' (LVEA)
 DATUM POINT EL +100.00 = 531.11' (OSB)

NO.	DATE	BY	CHKD	ENGR	PROJ	DESCRIPTION

ISSUED FOR CONSTRUCTION			
DRAWN	CKT/DS	5-12-96	
CHECKED	TB	5-26-96	
ENGINEER	tkk	7-12-96	
PROJ	WWS	7-11-96	

Handwritten signature and date: 4/2/96

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 100 WEST WALNUT STREET
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LASER INTERFEROMETER
 GRAVITATIONAL-WAVE OBSERVATORY
 SITE NO. 1 - HANFORD, WASHINGTON

TITLE	AS NOTED	PP150969	8094
SHEET NUMBER	WA-A-502		REVISIONS
ARCHITECTURAL CORNER STATION LVEA PARTIAL FLOOR PLAN SHEET 1			

LIGO-D960274-00-0