


MID/END STATIONS ROOF PLAN
 1/8" = 1'-0" (2)

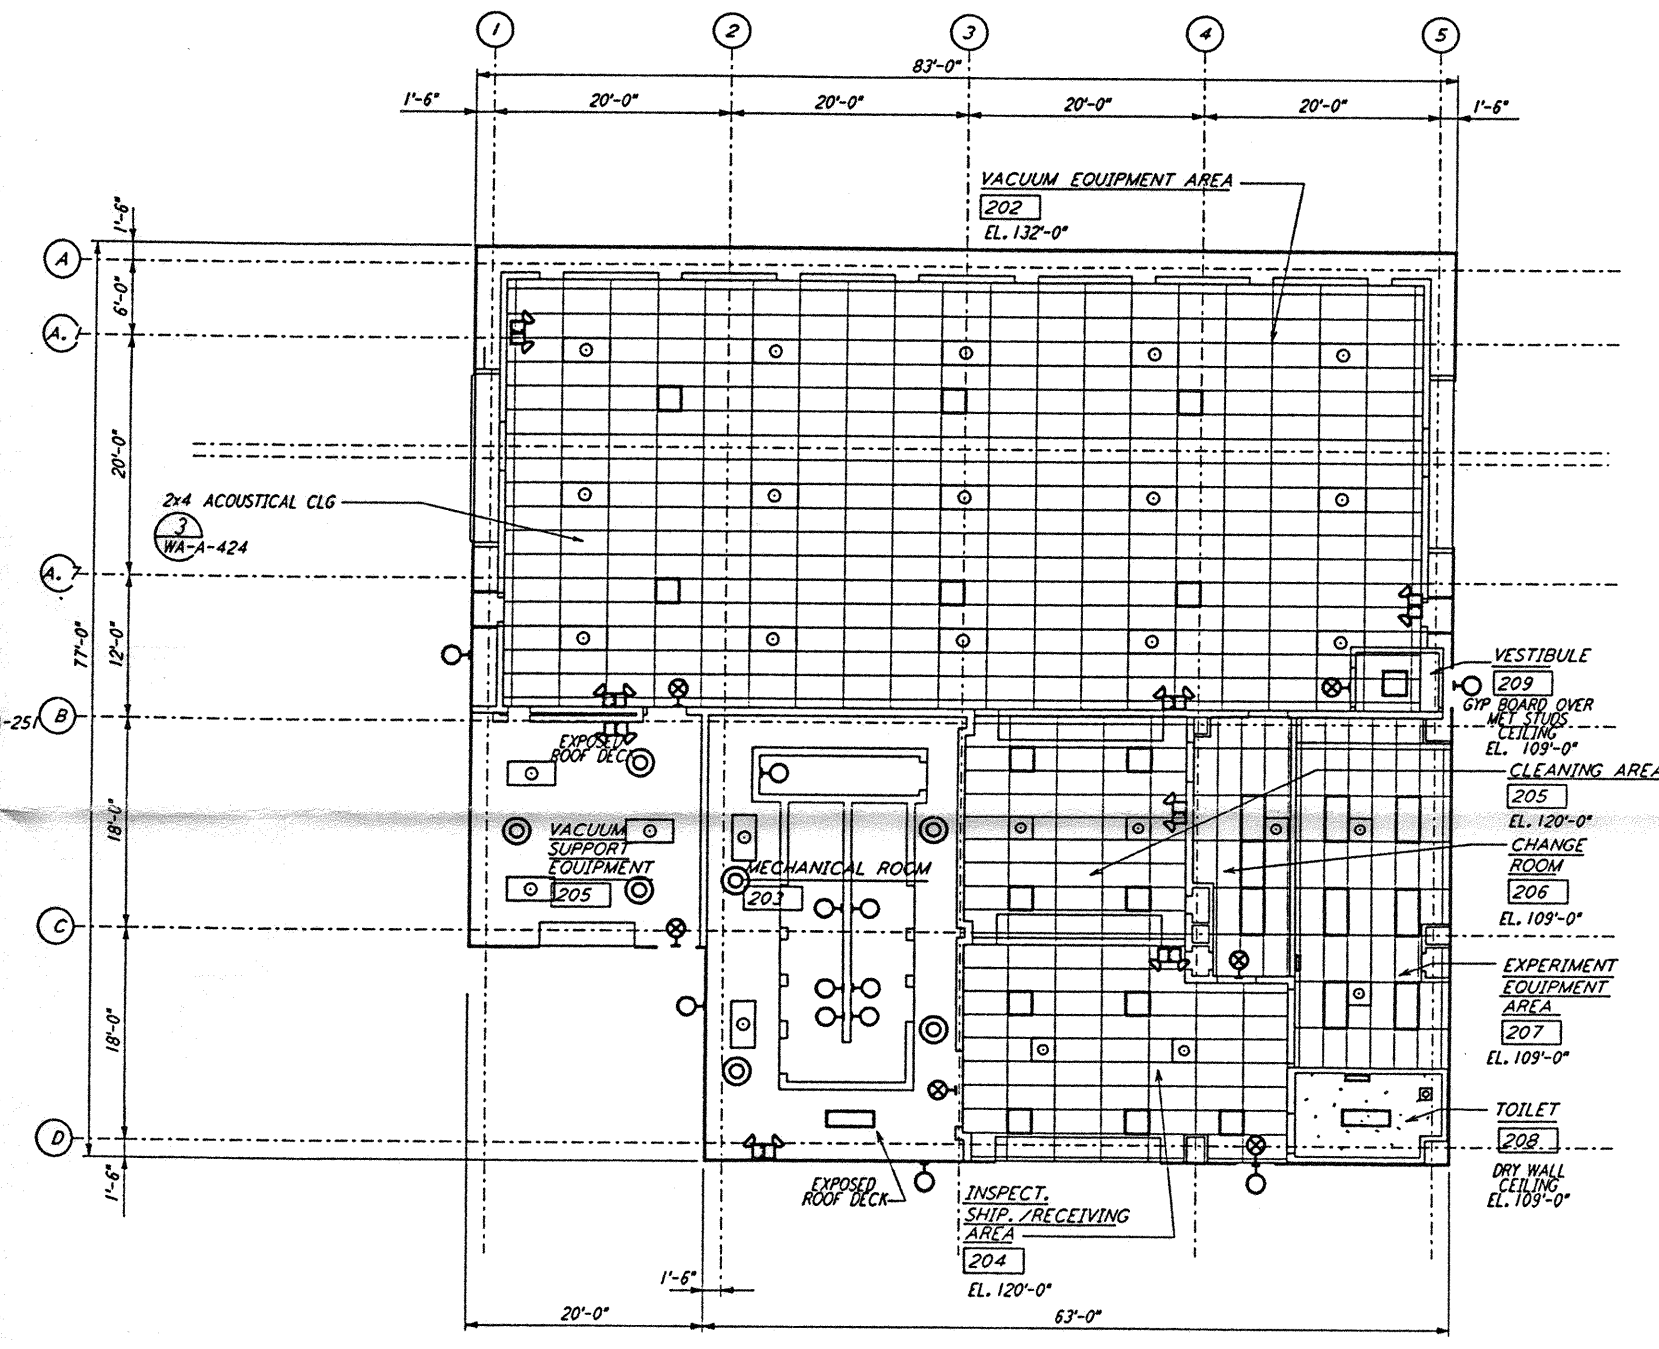

MID/END STATIONS REFLECTED CEILING PLAN
 1/8" = 1'-0" (1)

KEY PLAN
 DATUM POINT EL +100.00 = 531.111' (LVEA)
 DATUM POINT EL +100.00 = 531.111' (OSB)
 DATUM POINT EL +100.00 = 528.07' (MID NORTH)
 DATUM POINT EL +100.00 = 527.05' (END NORTH)
 DATUM POINT EL +100.00 = 532.22' (MID SOUTH WEST)
 DATUM POINT EL +100.00 = 535.26' (END SOUTH WEST)

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NO.	DATE	BY	CHKD	ENGR	PROJ	DESCRIPTION
B	4-19-96	SF	SF	PTDM		FINAL DESIGN REVIEW & BID
A	01/17/96	SF	SF	TDM		PRELIMINARY DESIGN REVIEW

DRAWN	CKT
CHECKED	
ENGINEER	
PROJ	

PARSONS
 100 WEST WALNUT STREET
 PASADENA, CALIFORNIA

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LASER INTERFEROMETER
 GRAVITATIONAL-WAVE OBSERVATORY
 SITE NO. 1 - HANFORD, WASHINGTON

ARCHITECTURAL
 MID & END STATIONS
 REFLECTED CEILING PLAN
 & ROOF PLAN

AS NOTED PP150969 8094
 SHEET NUMBER
WA-A-221

LIGO-D960261-B-□