
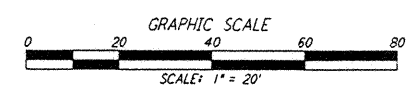
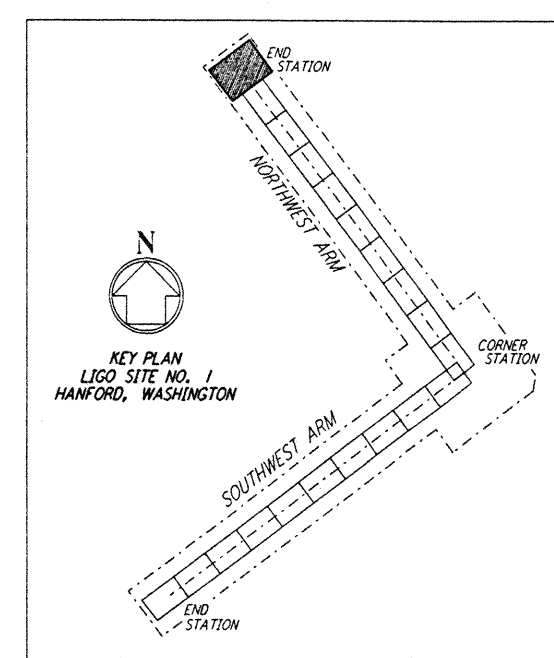
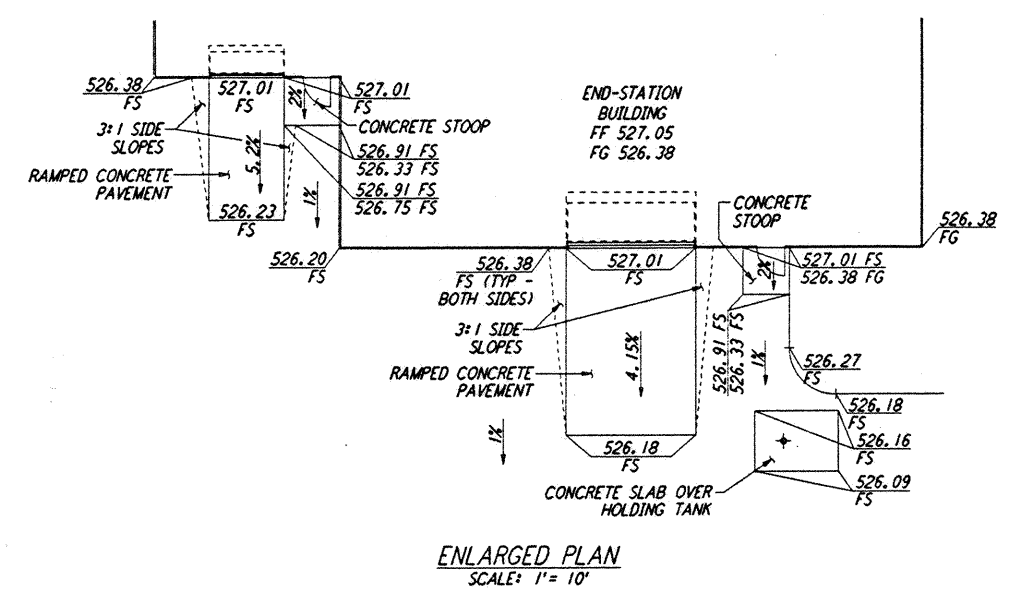


NOTES:
 1. SEE SHEET WA-C-002 FOR GENERAL NOTES, LEGEND AND ABBREVIATIONS.

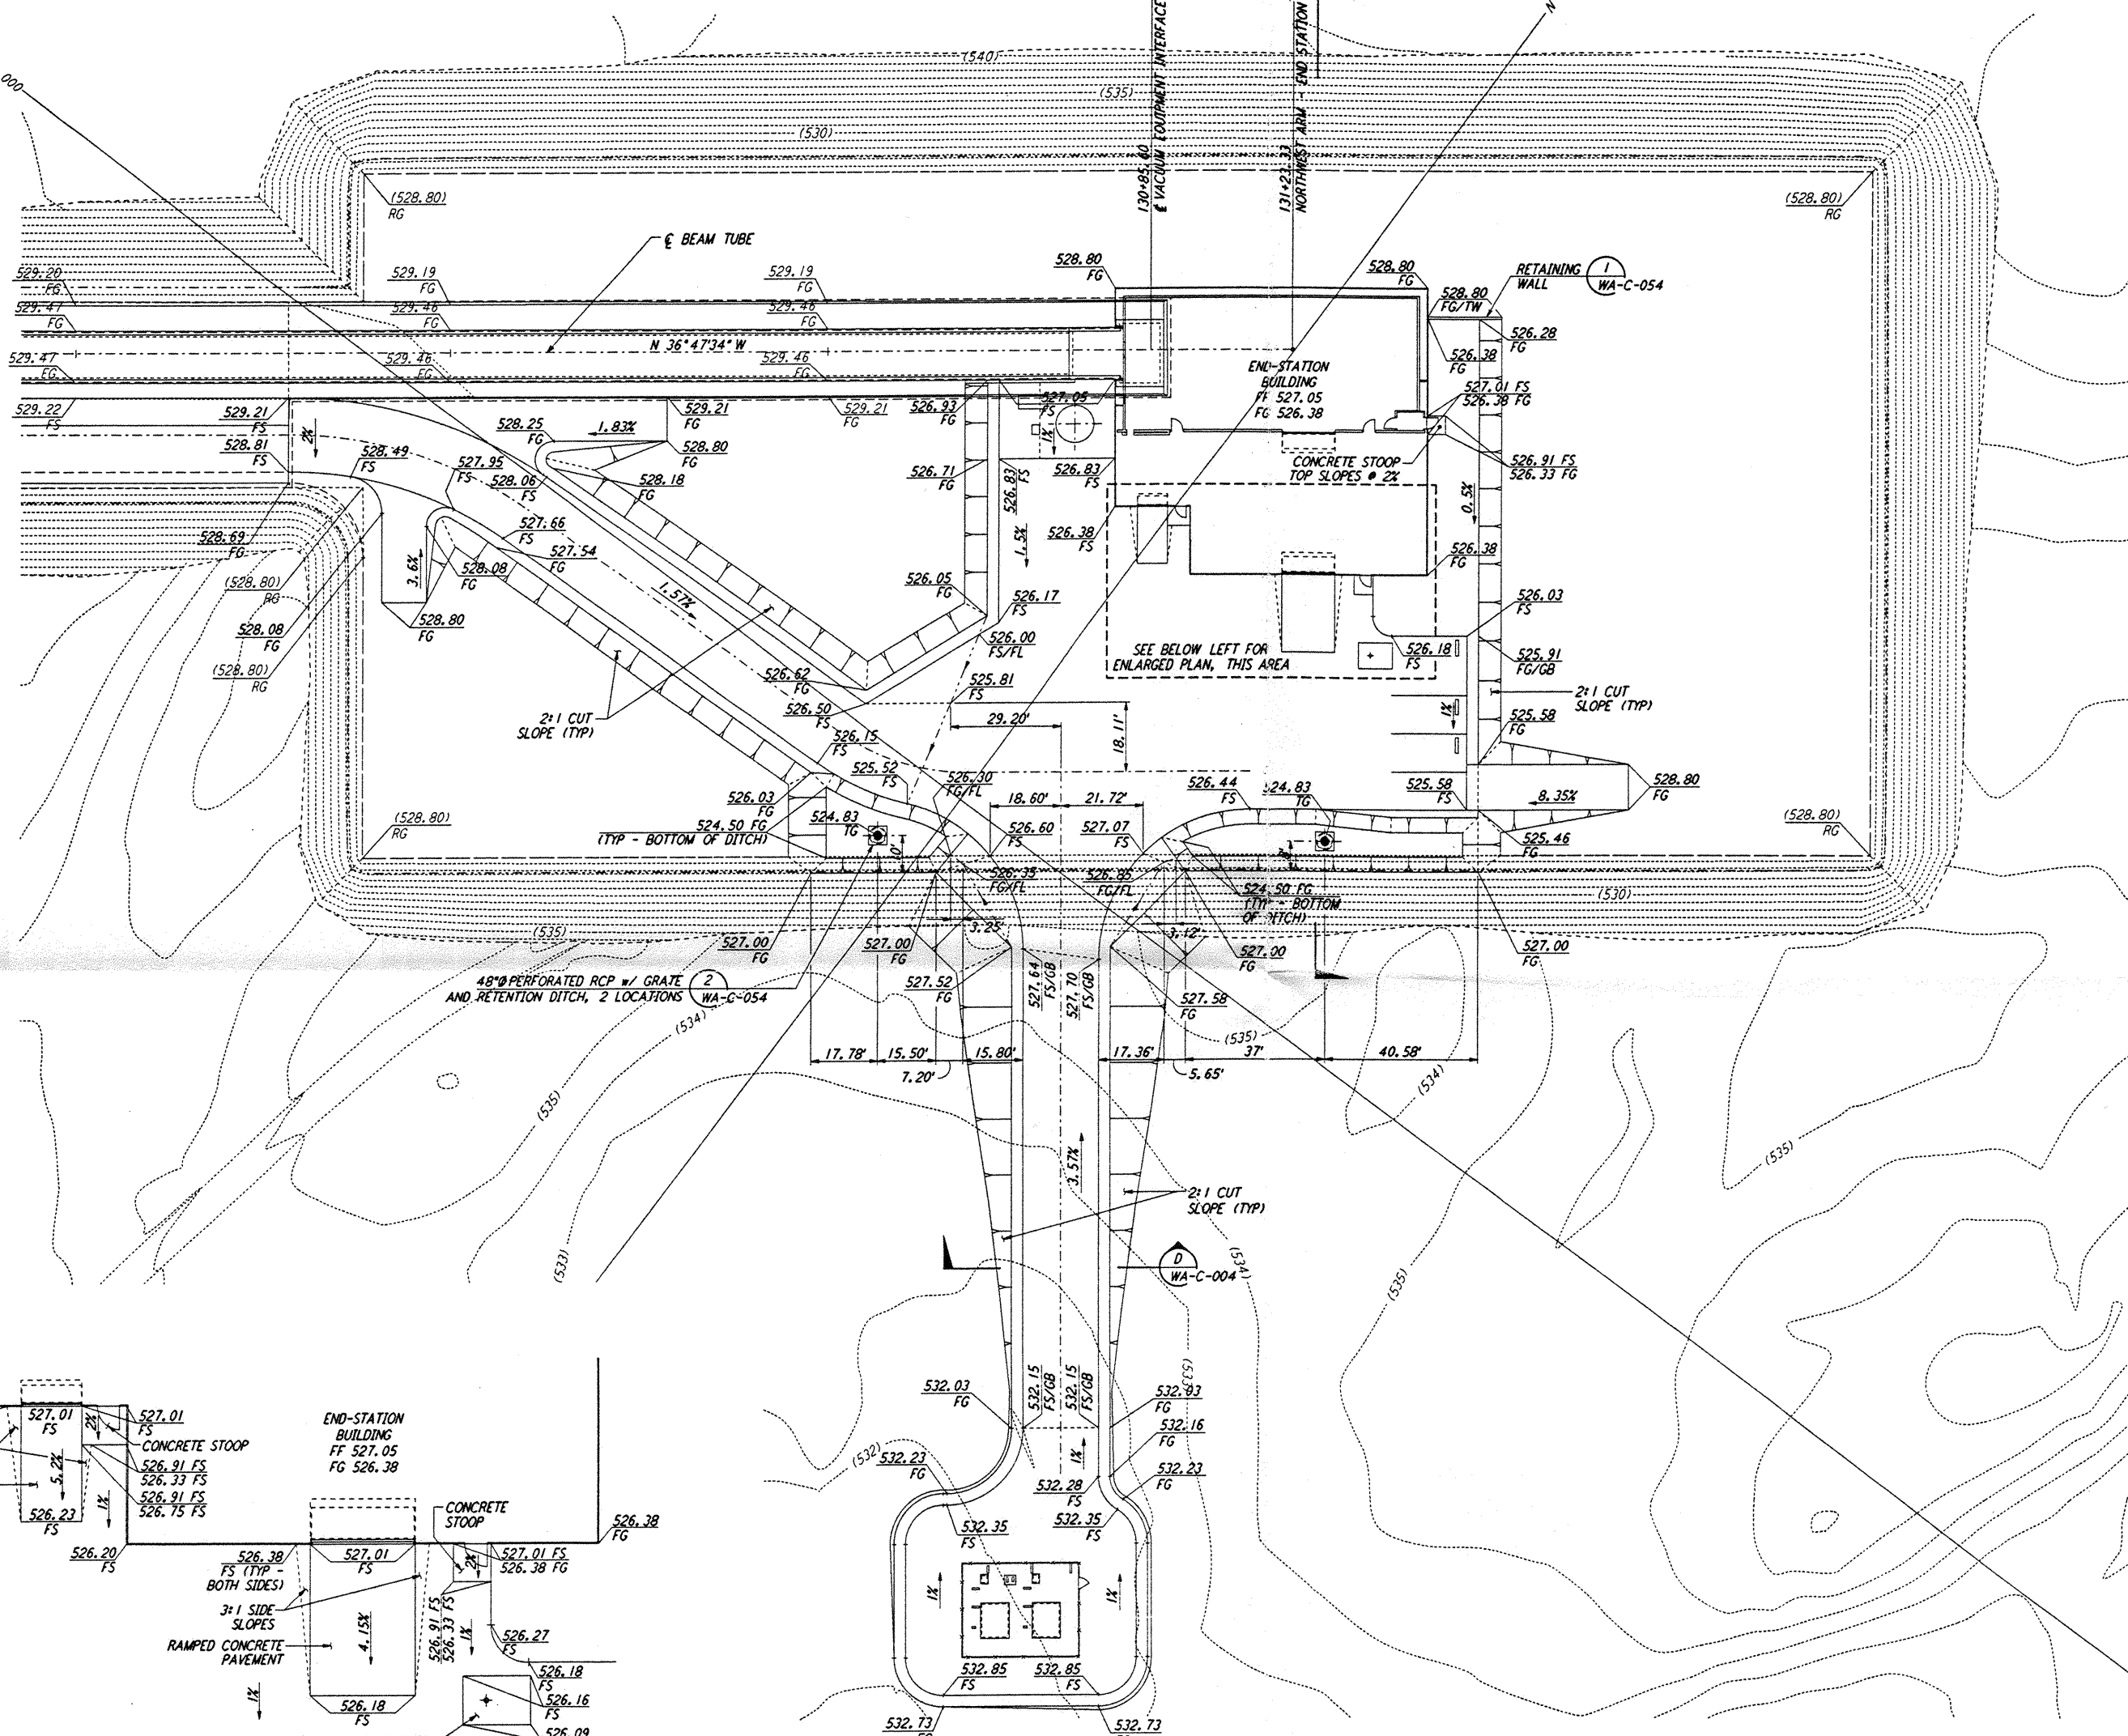


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LASER INTERFEROMETER
 GRAVITATIONAL-WAVE OBSERVATORY
 SITE NO. 1 - HANFORD, WASHINGTON

TITLE: CIVIL NORTHWEST ARM END-STATION GRADING PLAN

SCALE: 1" = 20'

PROJECT NUMBER: PPI50969 8094

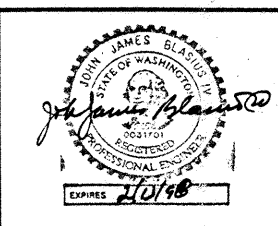SHEET NUMBER: **WA-C-026**

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